

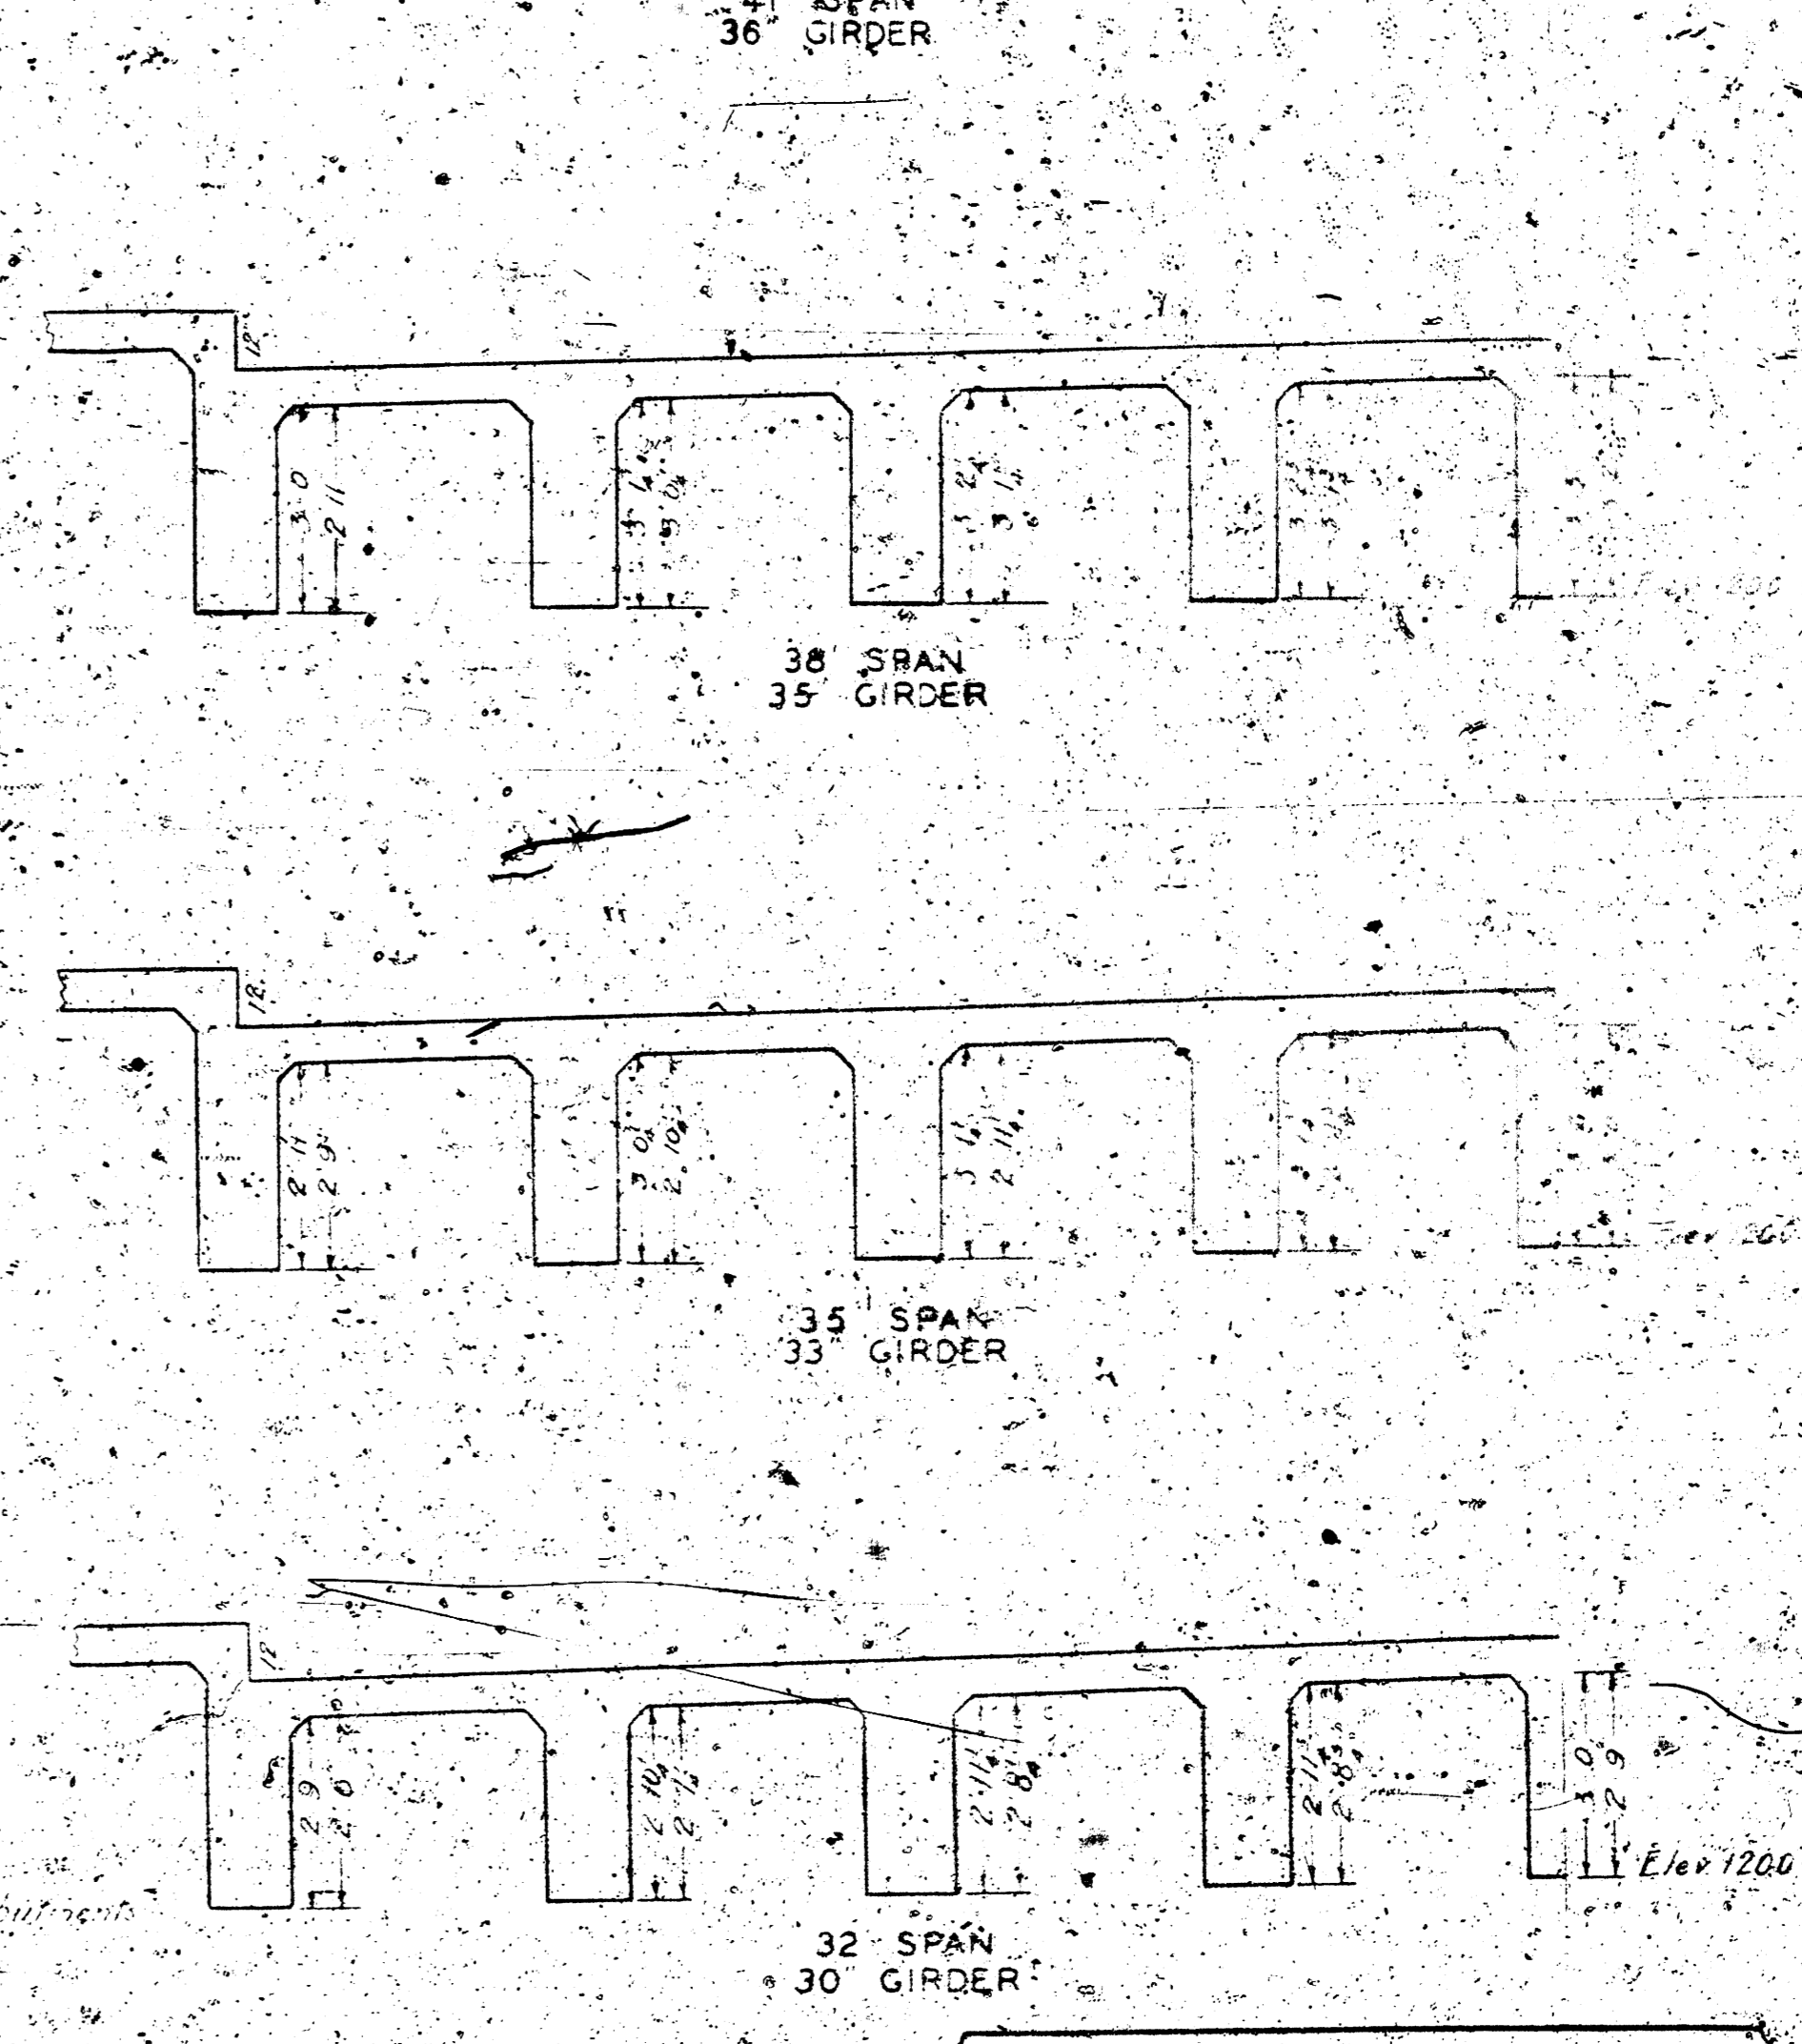
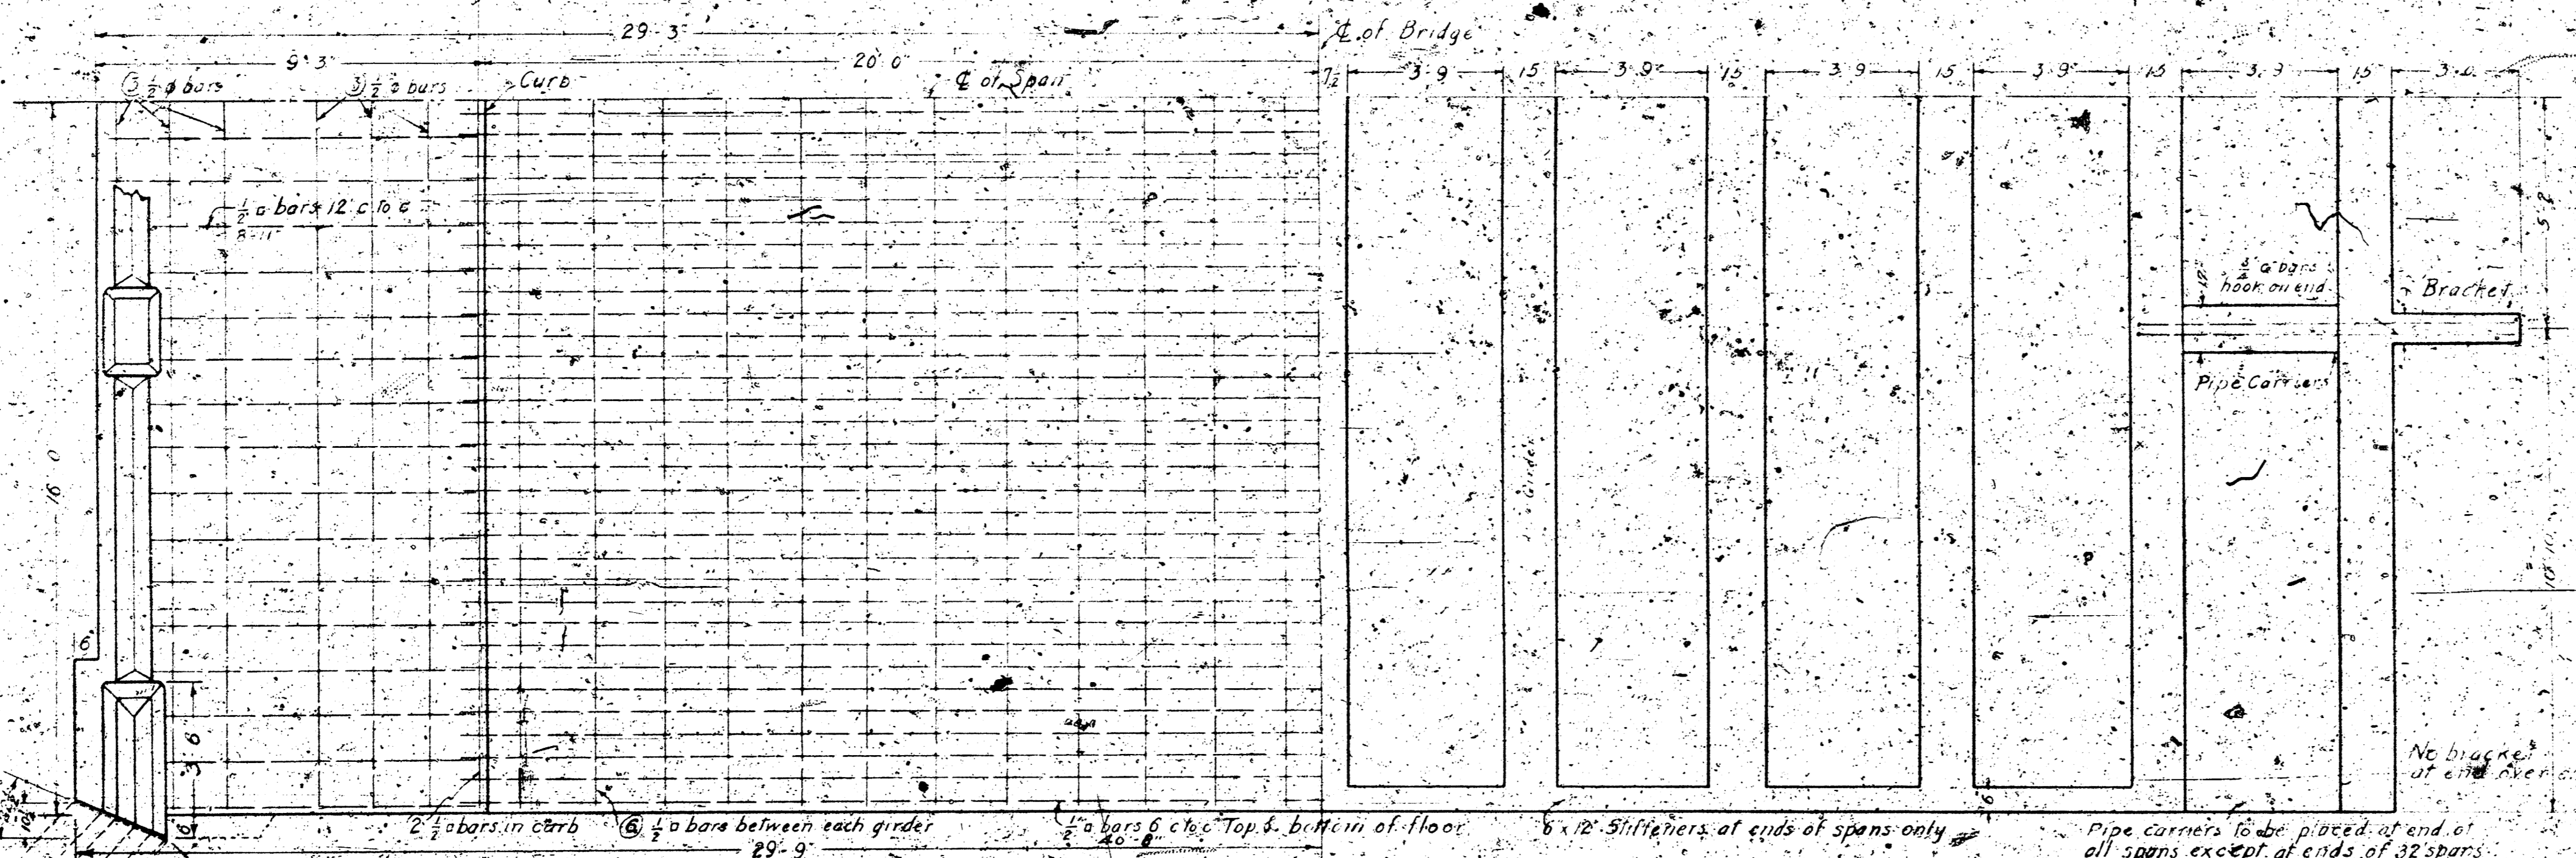
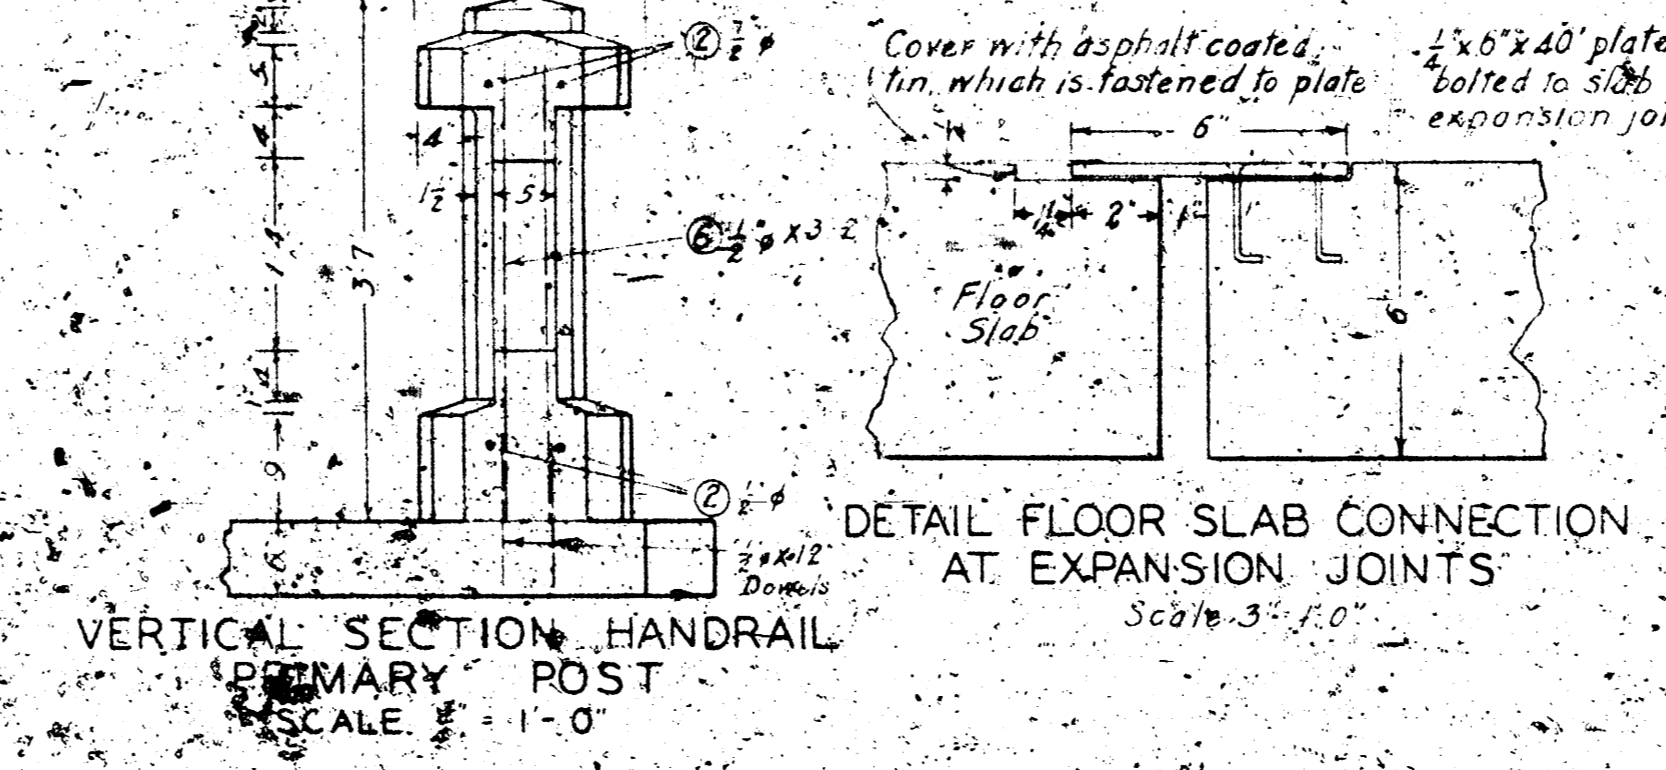
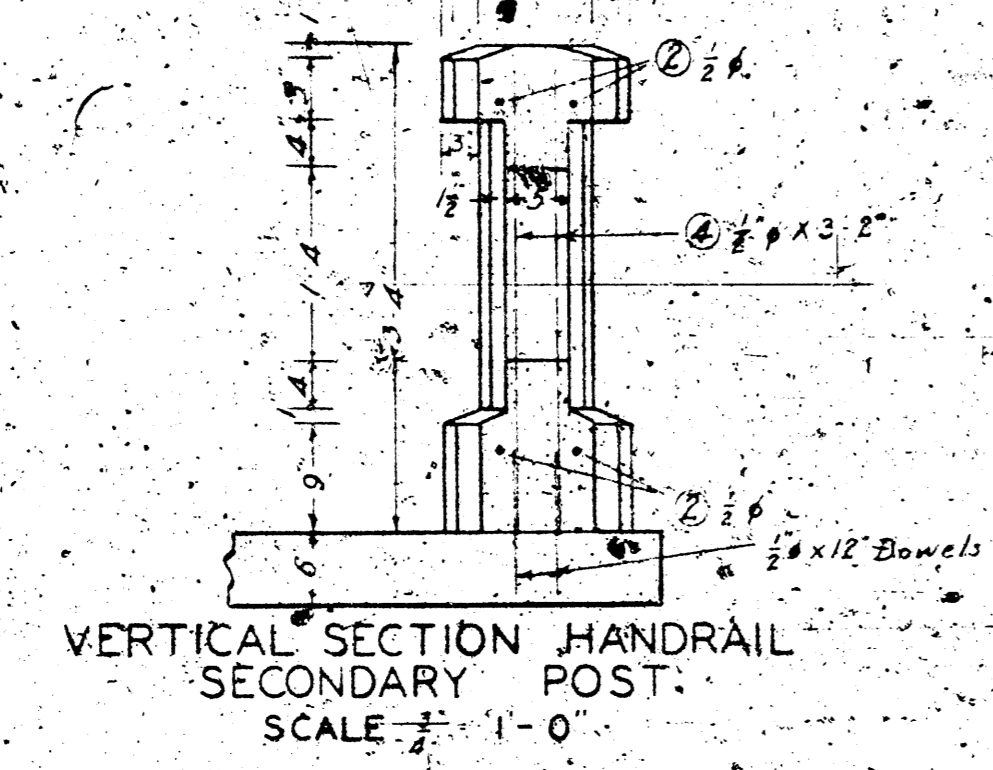
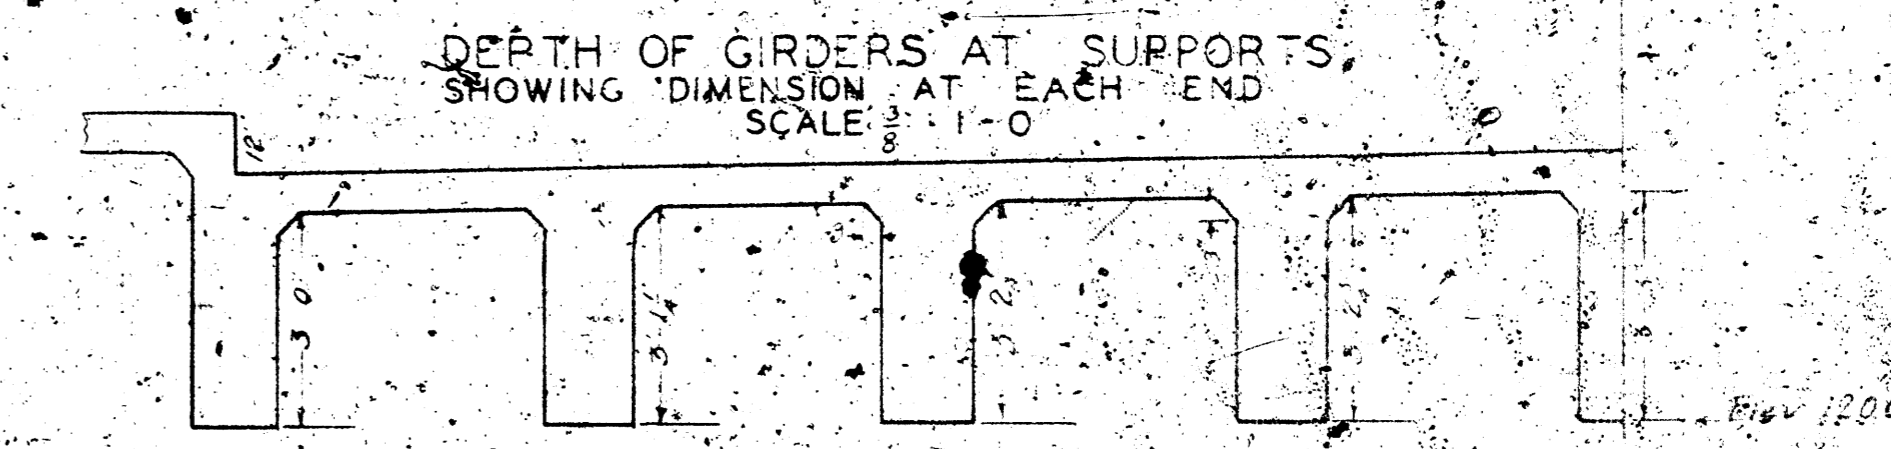
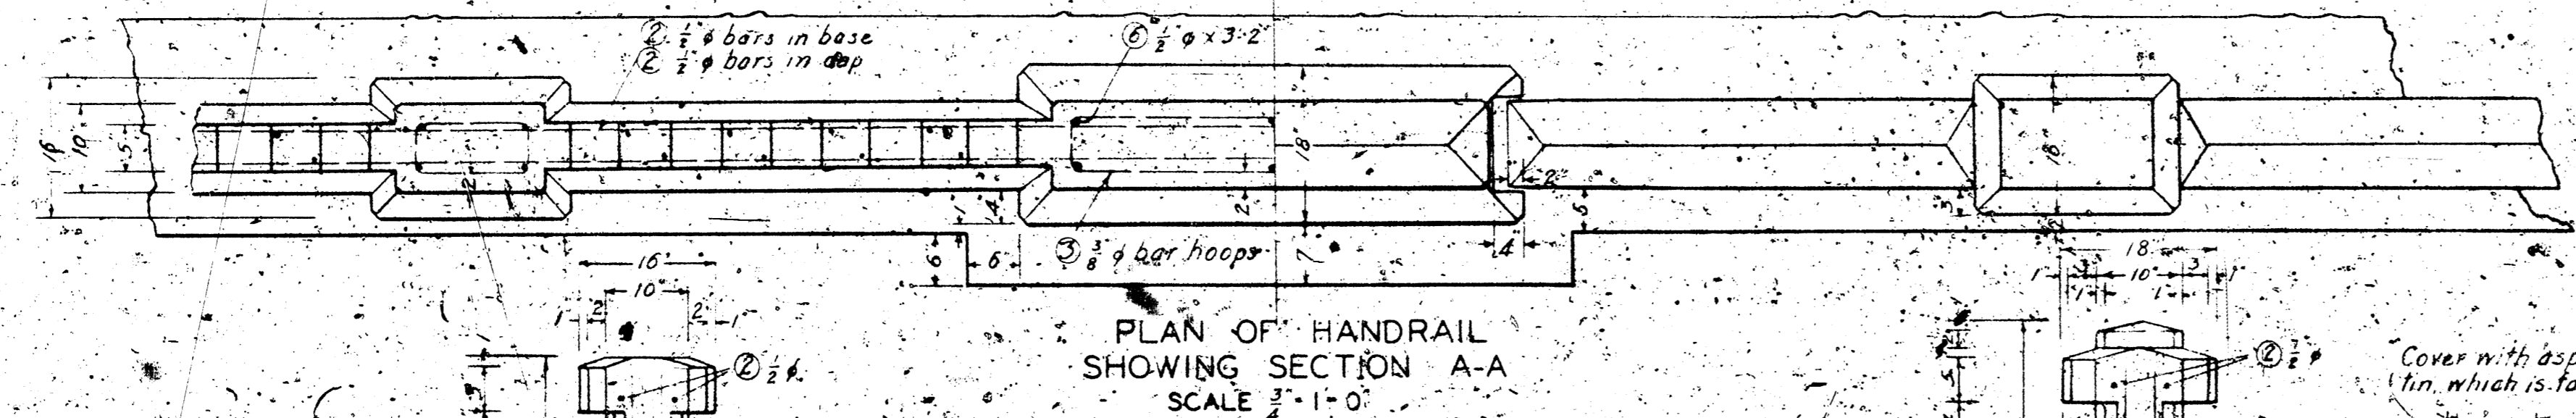
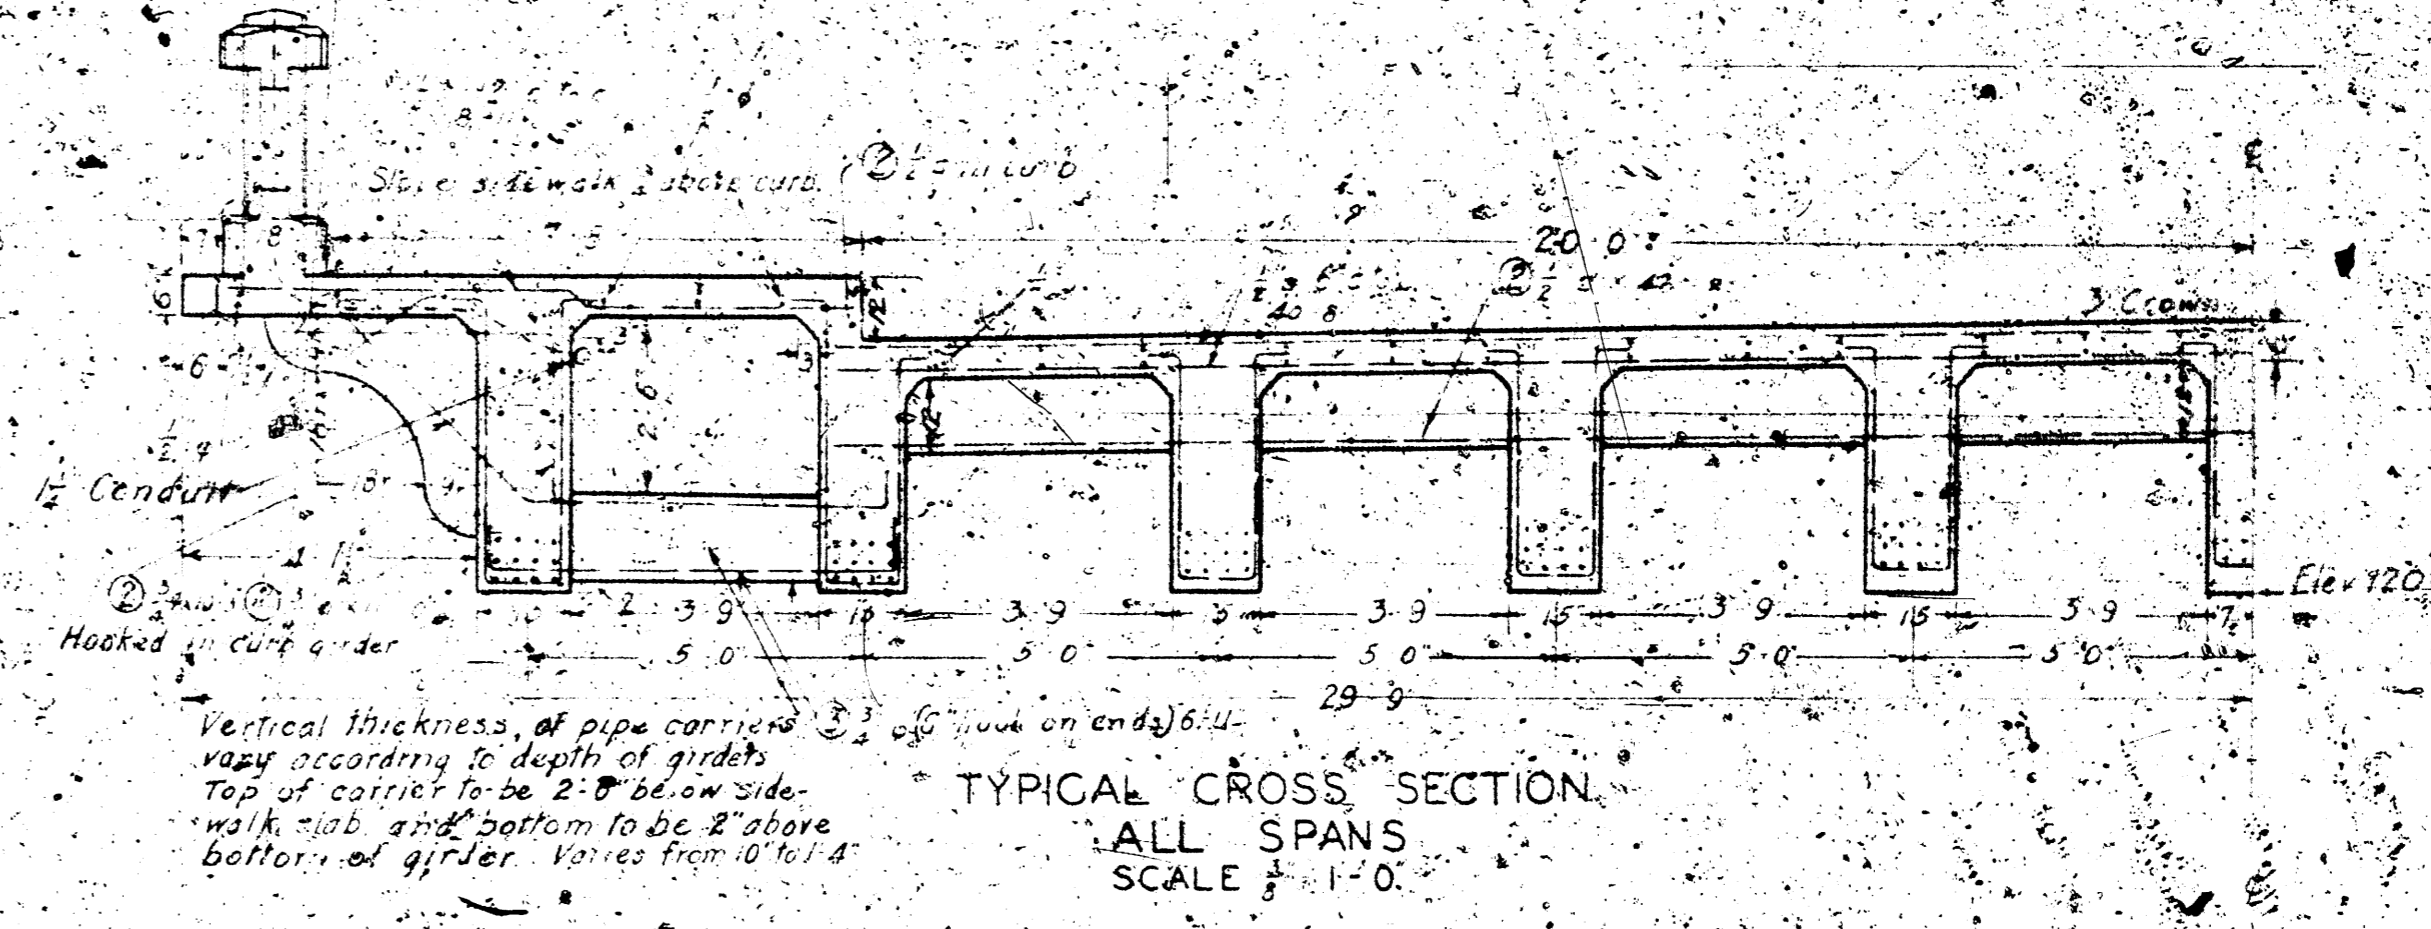



13TH STREET BRIDGE
 ABUTMENTS
 EXPANSION PLATES
 SHEET NO. 3
 SCALE 1" = 1'-0"
 EXCEPT AS SHOWN

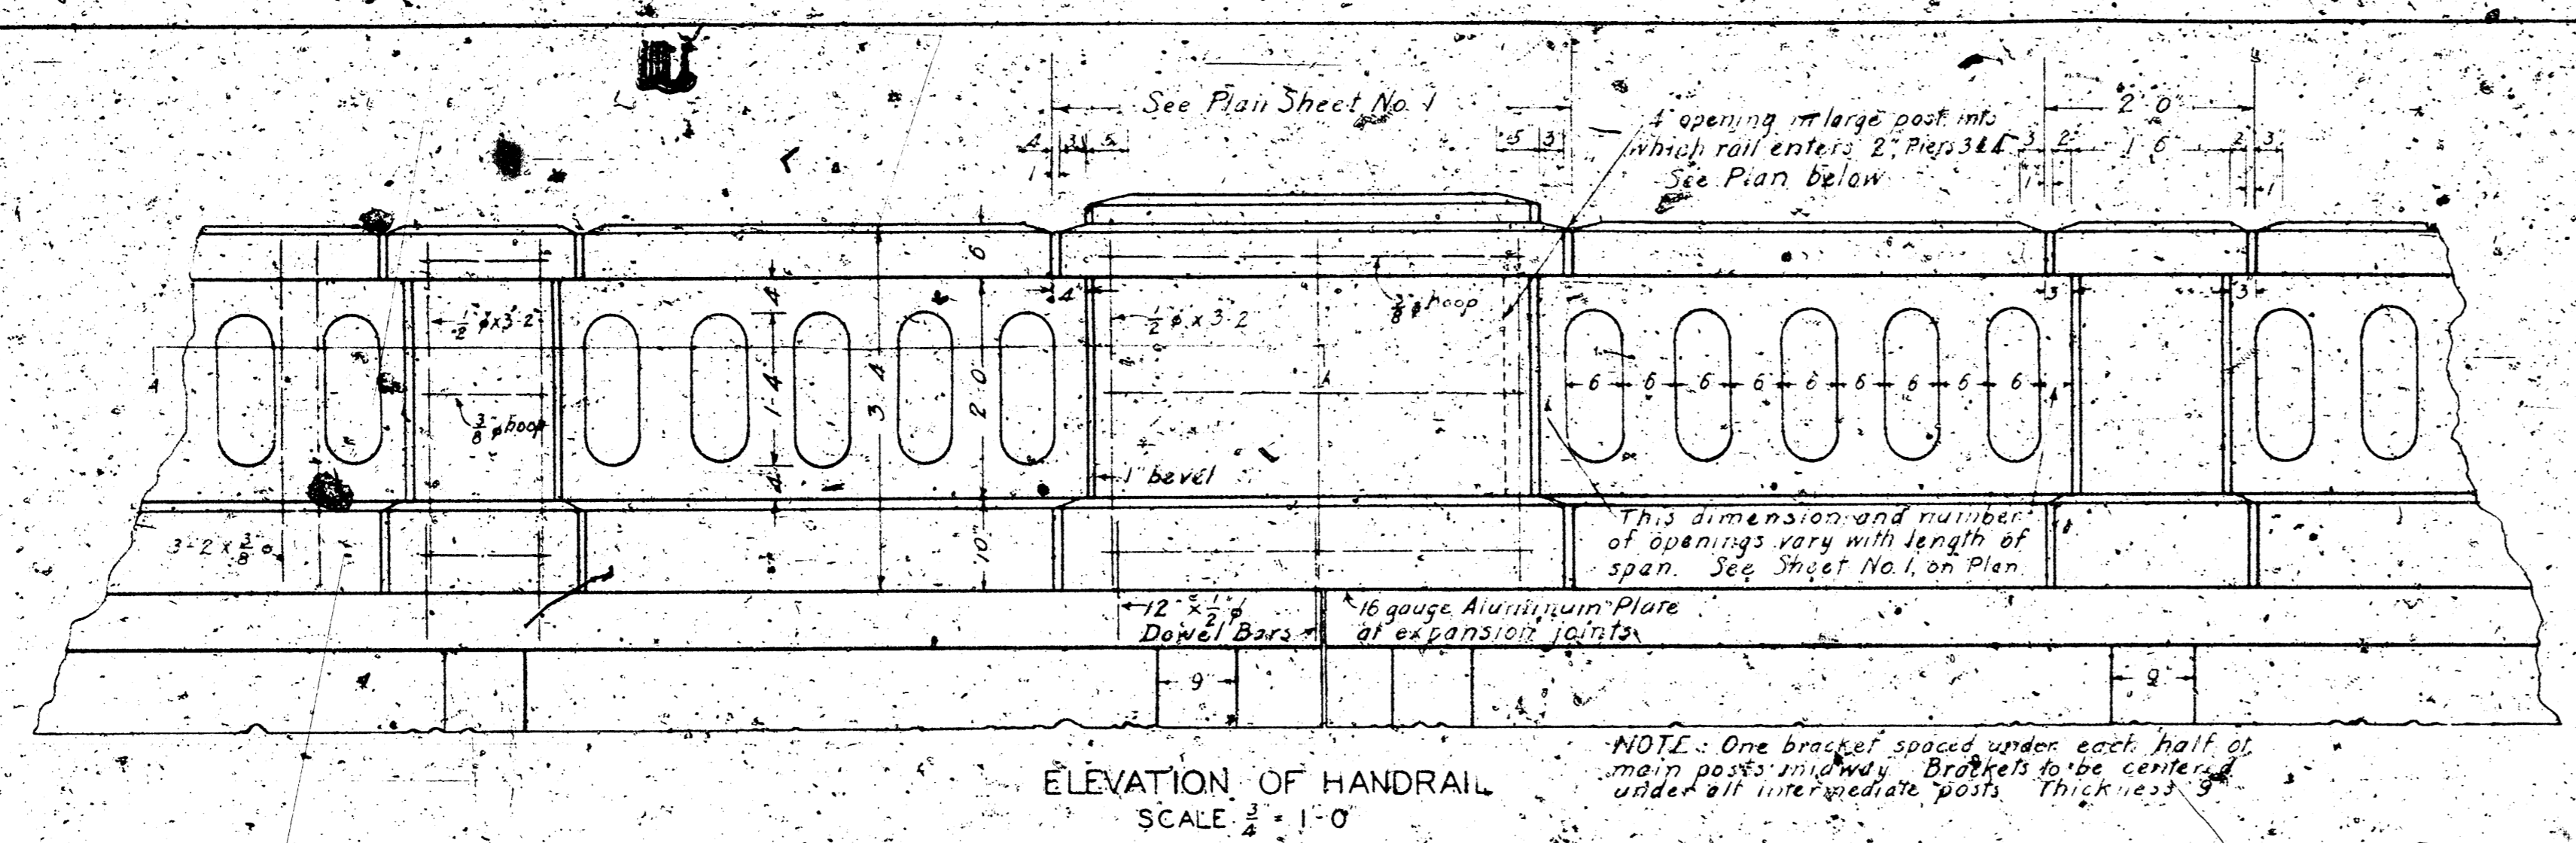



13-TH STREET BRIDGE
FLOOR PLAN & CROSS SECTION
DETAIL OF HANDRAIL
SHEET NO. 4
5 SHEETS

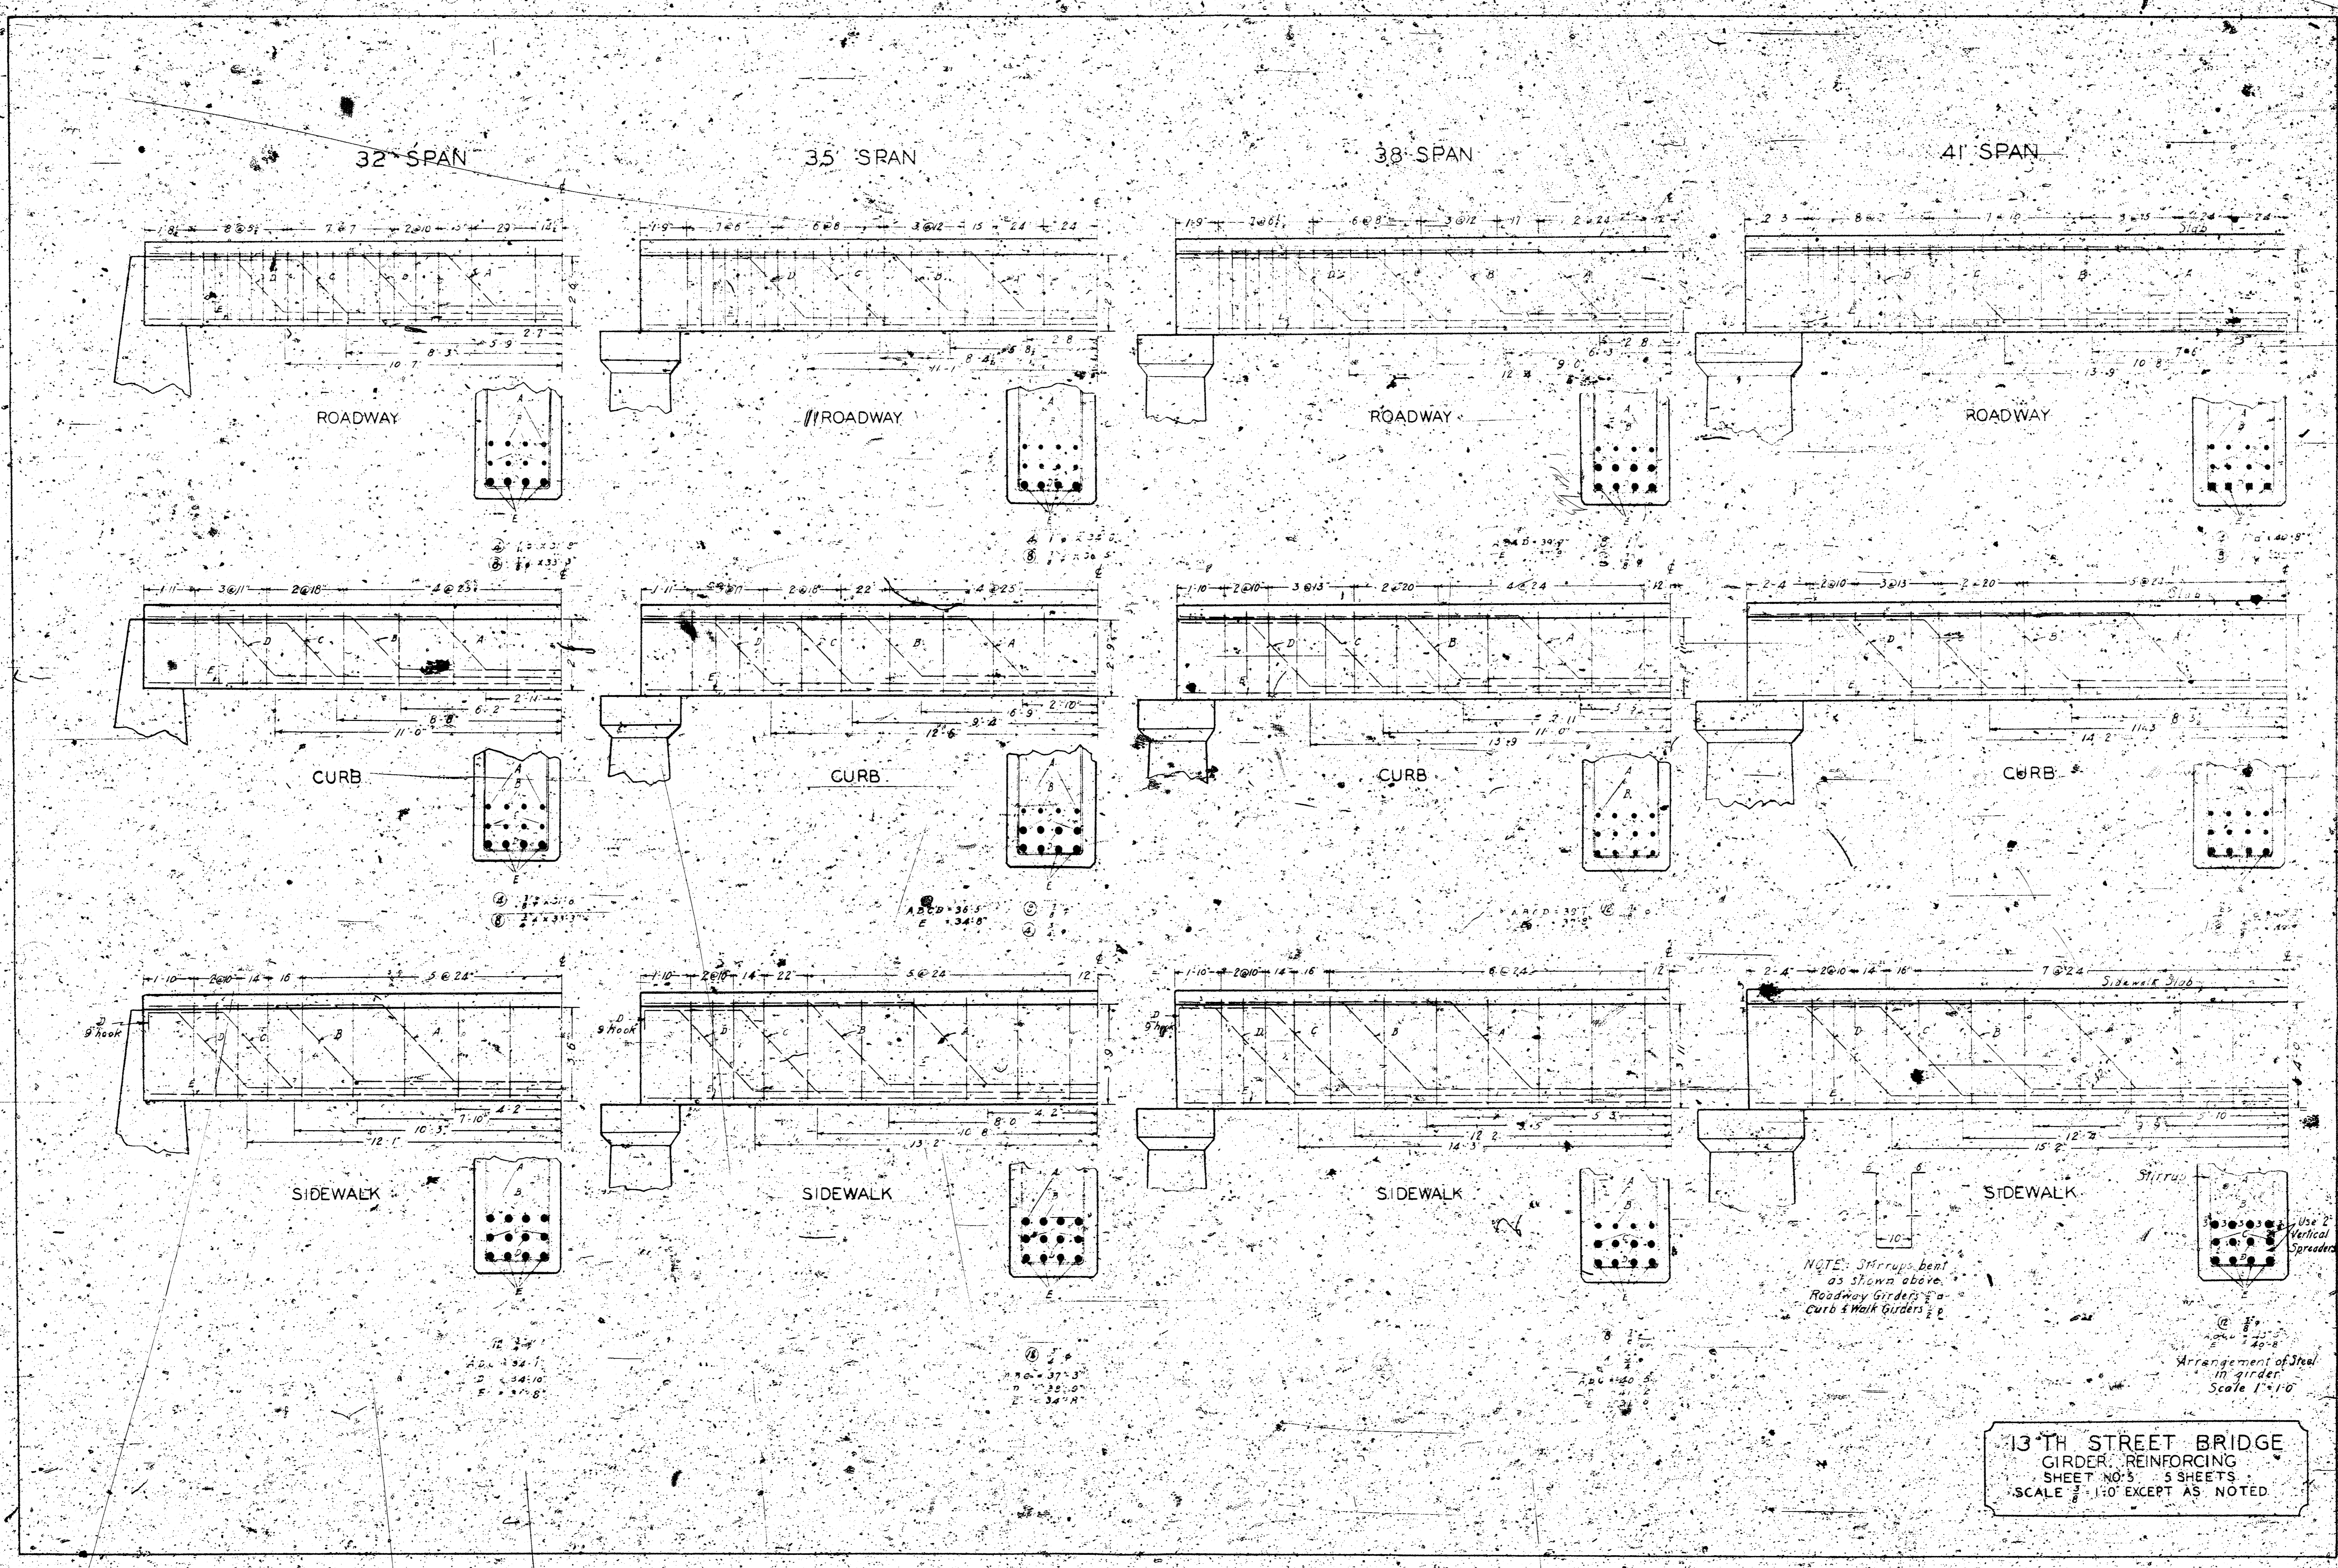


13TH STREET BRIDGE
 GIRDER REINFORCING
 SHEET NO. 5 5 SHEETS
 SCALE 1/4" = 1'-0" EXCEPT AS NOTED

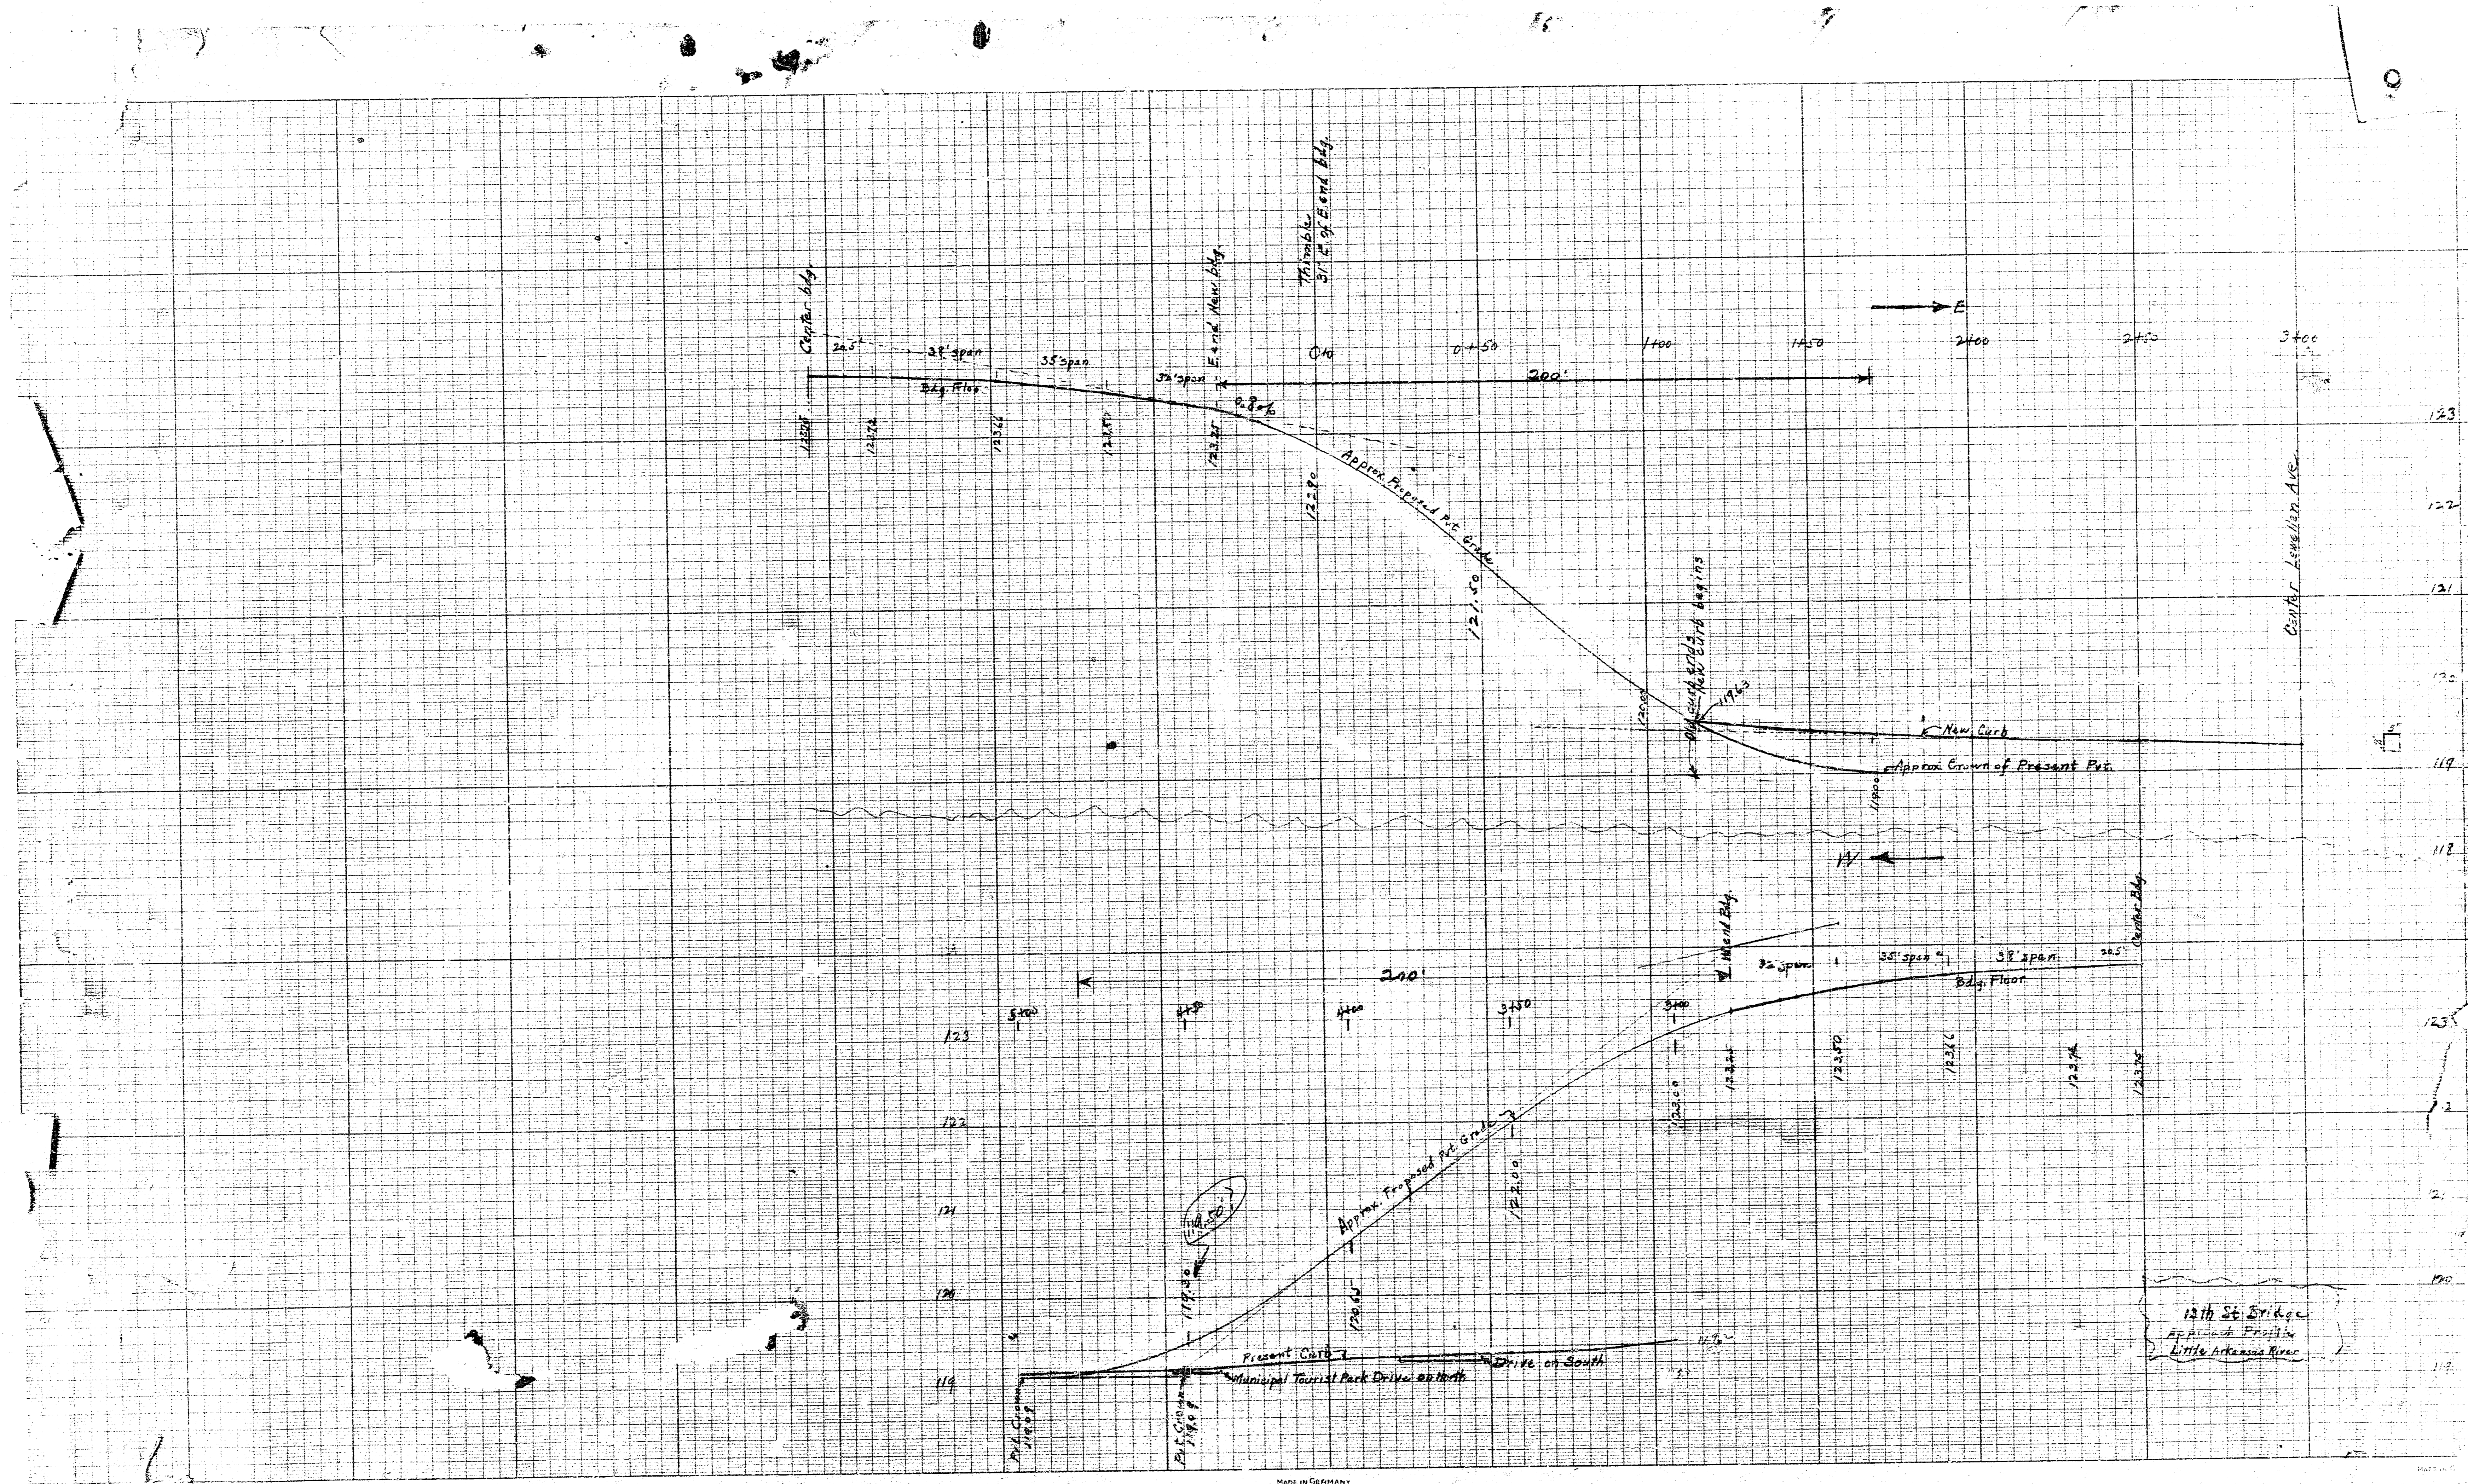

317 ST
11/18/50
11/18/50

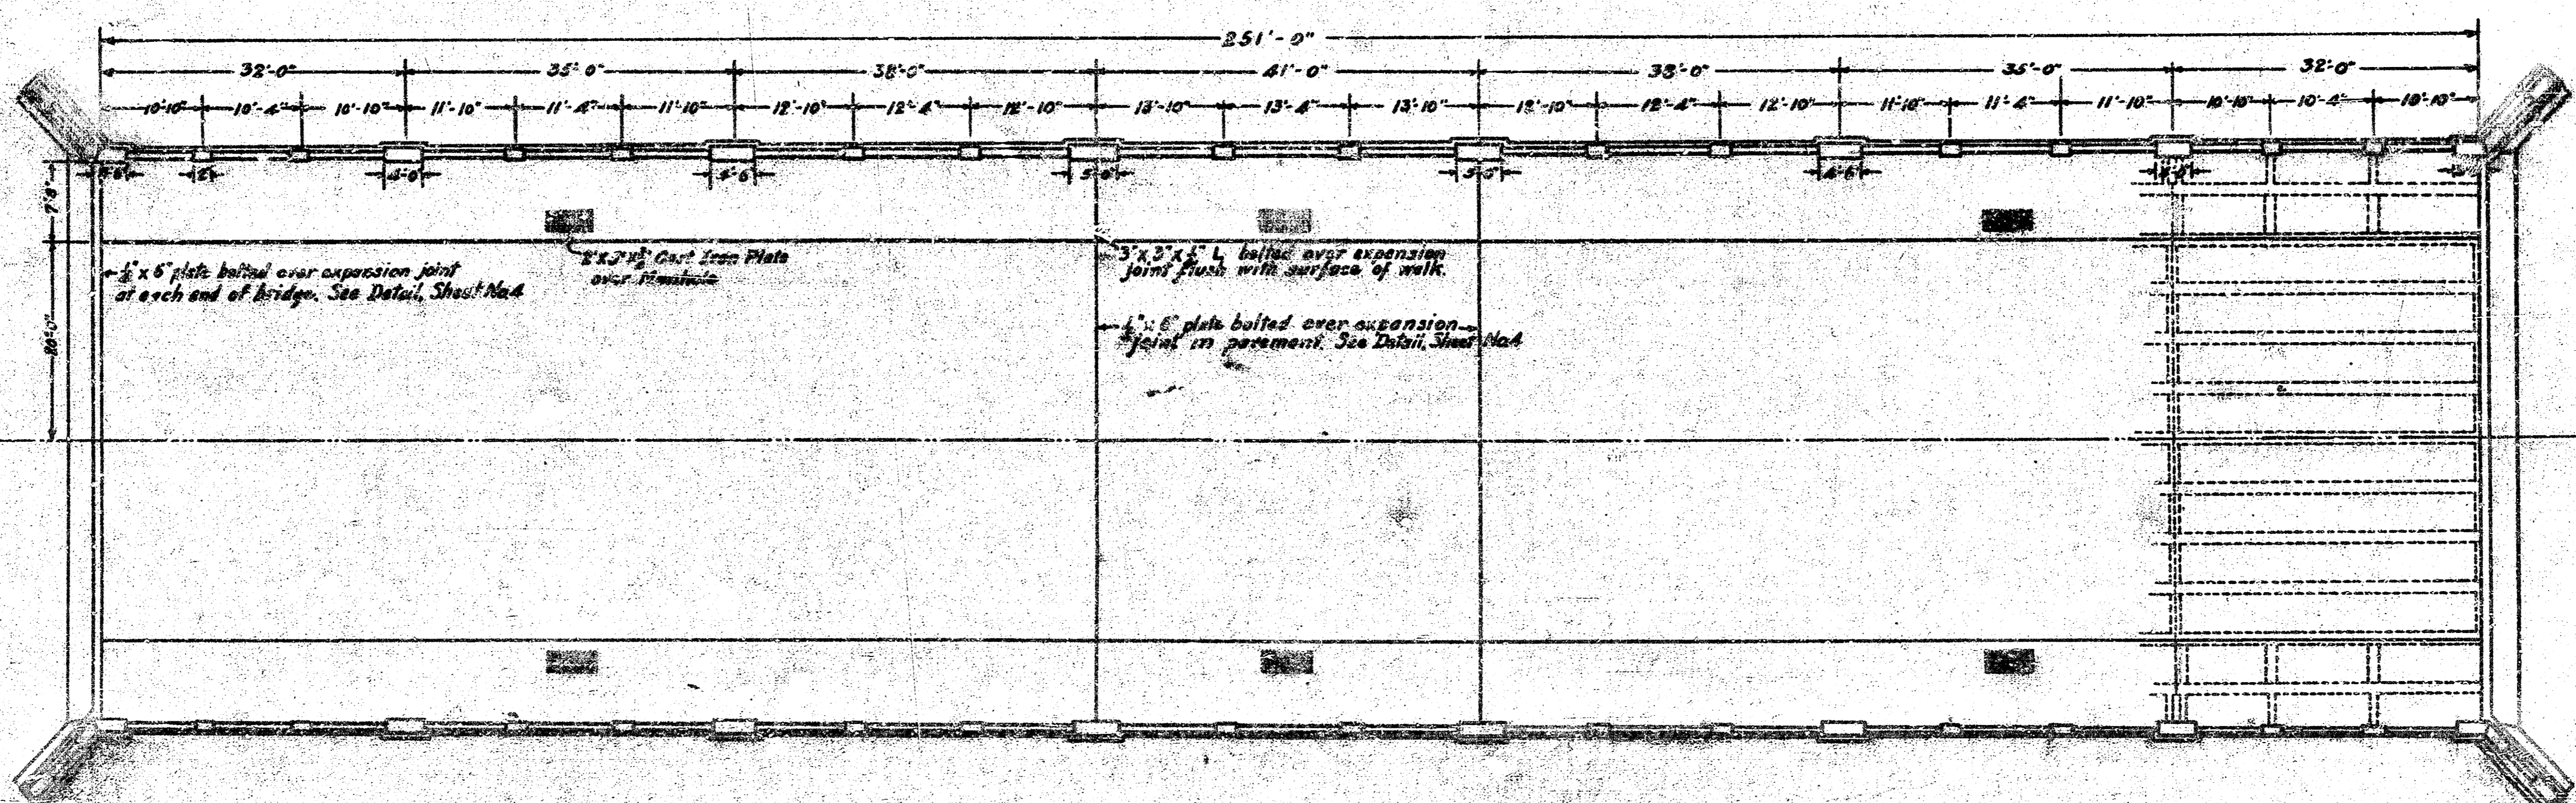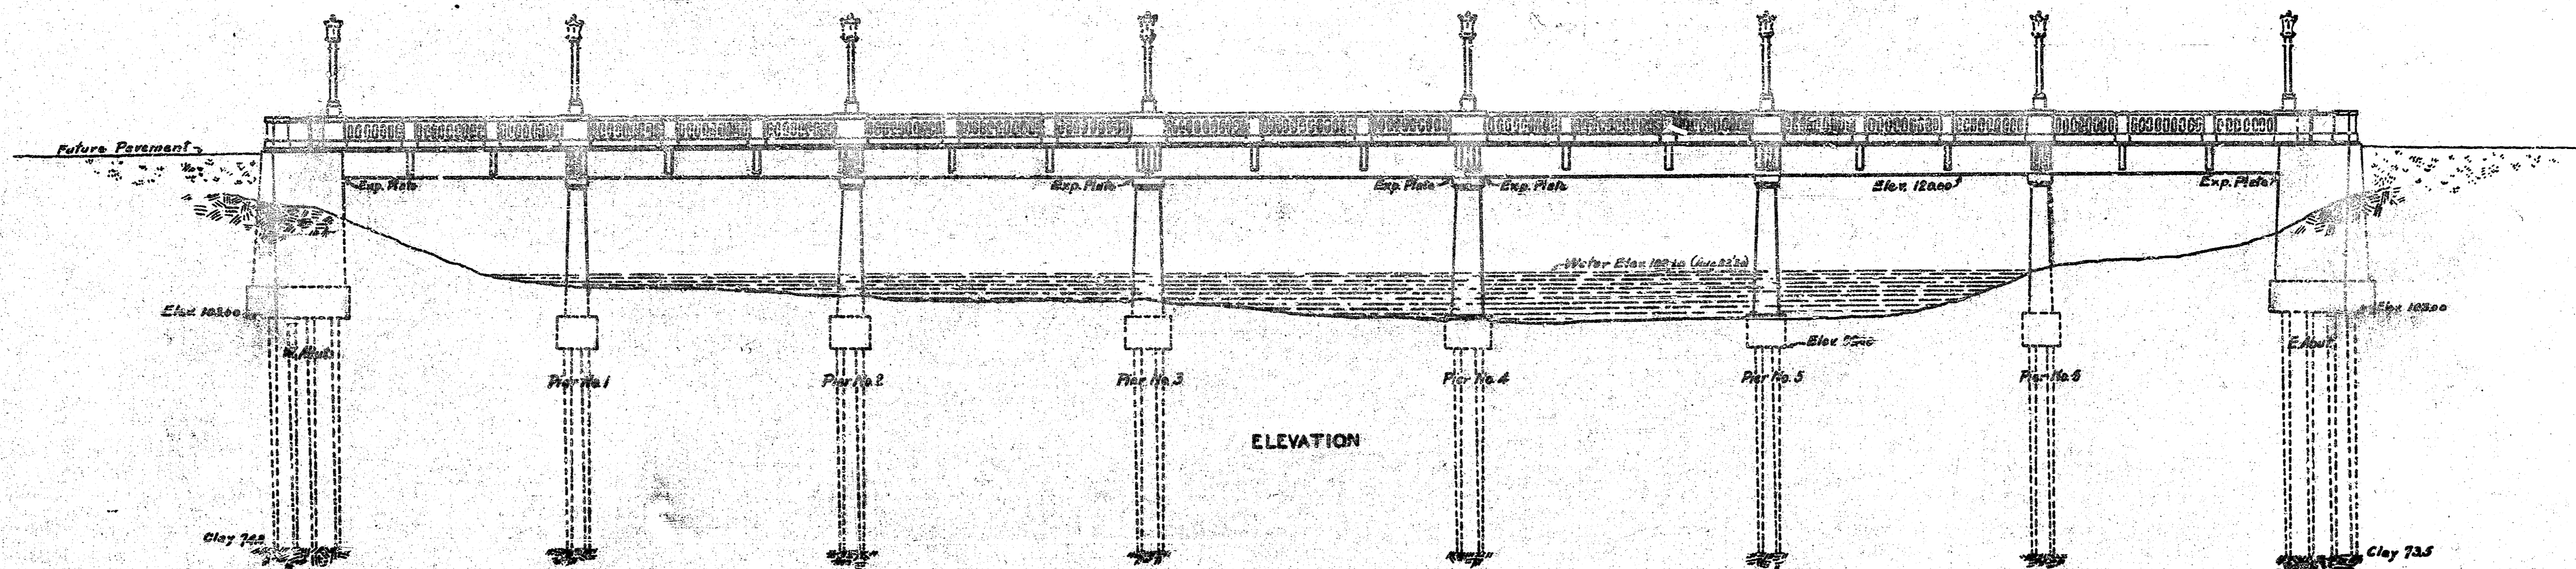


13TH STREET BRIDGE
 OVER LITTLE ARKANSAS RIVER
 WICHITA, KANSAS
 1931
 DESIGNED BY
 P. BROCKWAY, CITY ENGINEER
 L. K. WHITE, ASST. CITY ENGINEER
 SHEET NO. 1 OF 5 SHEETS
 SCALE 1/2" = 1'-0"

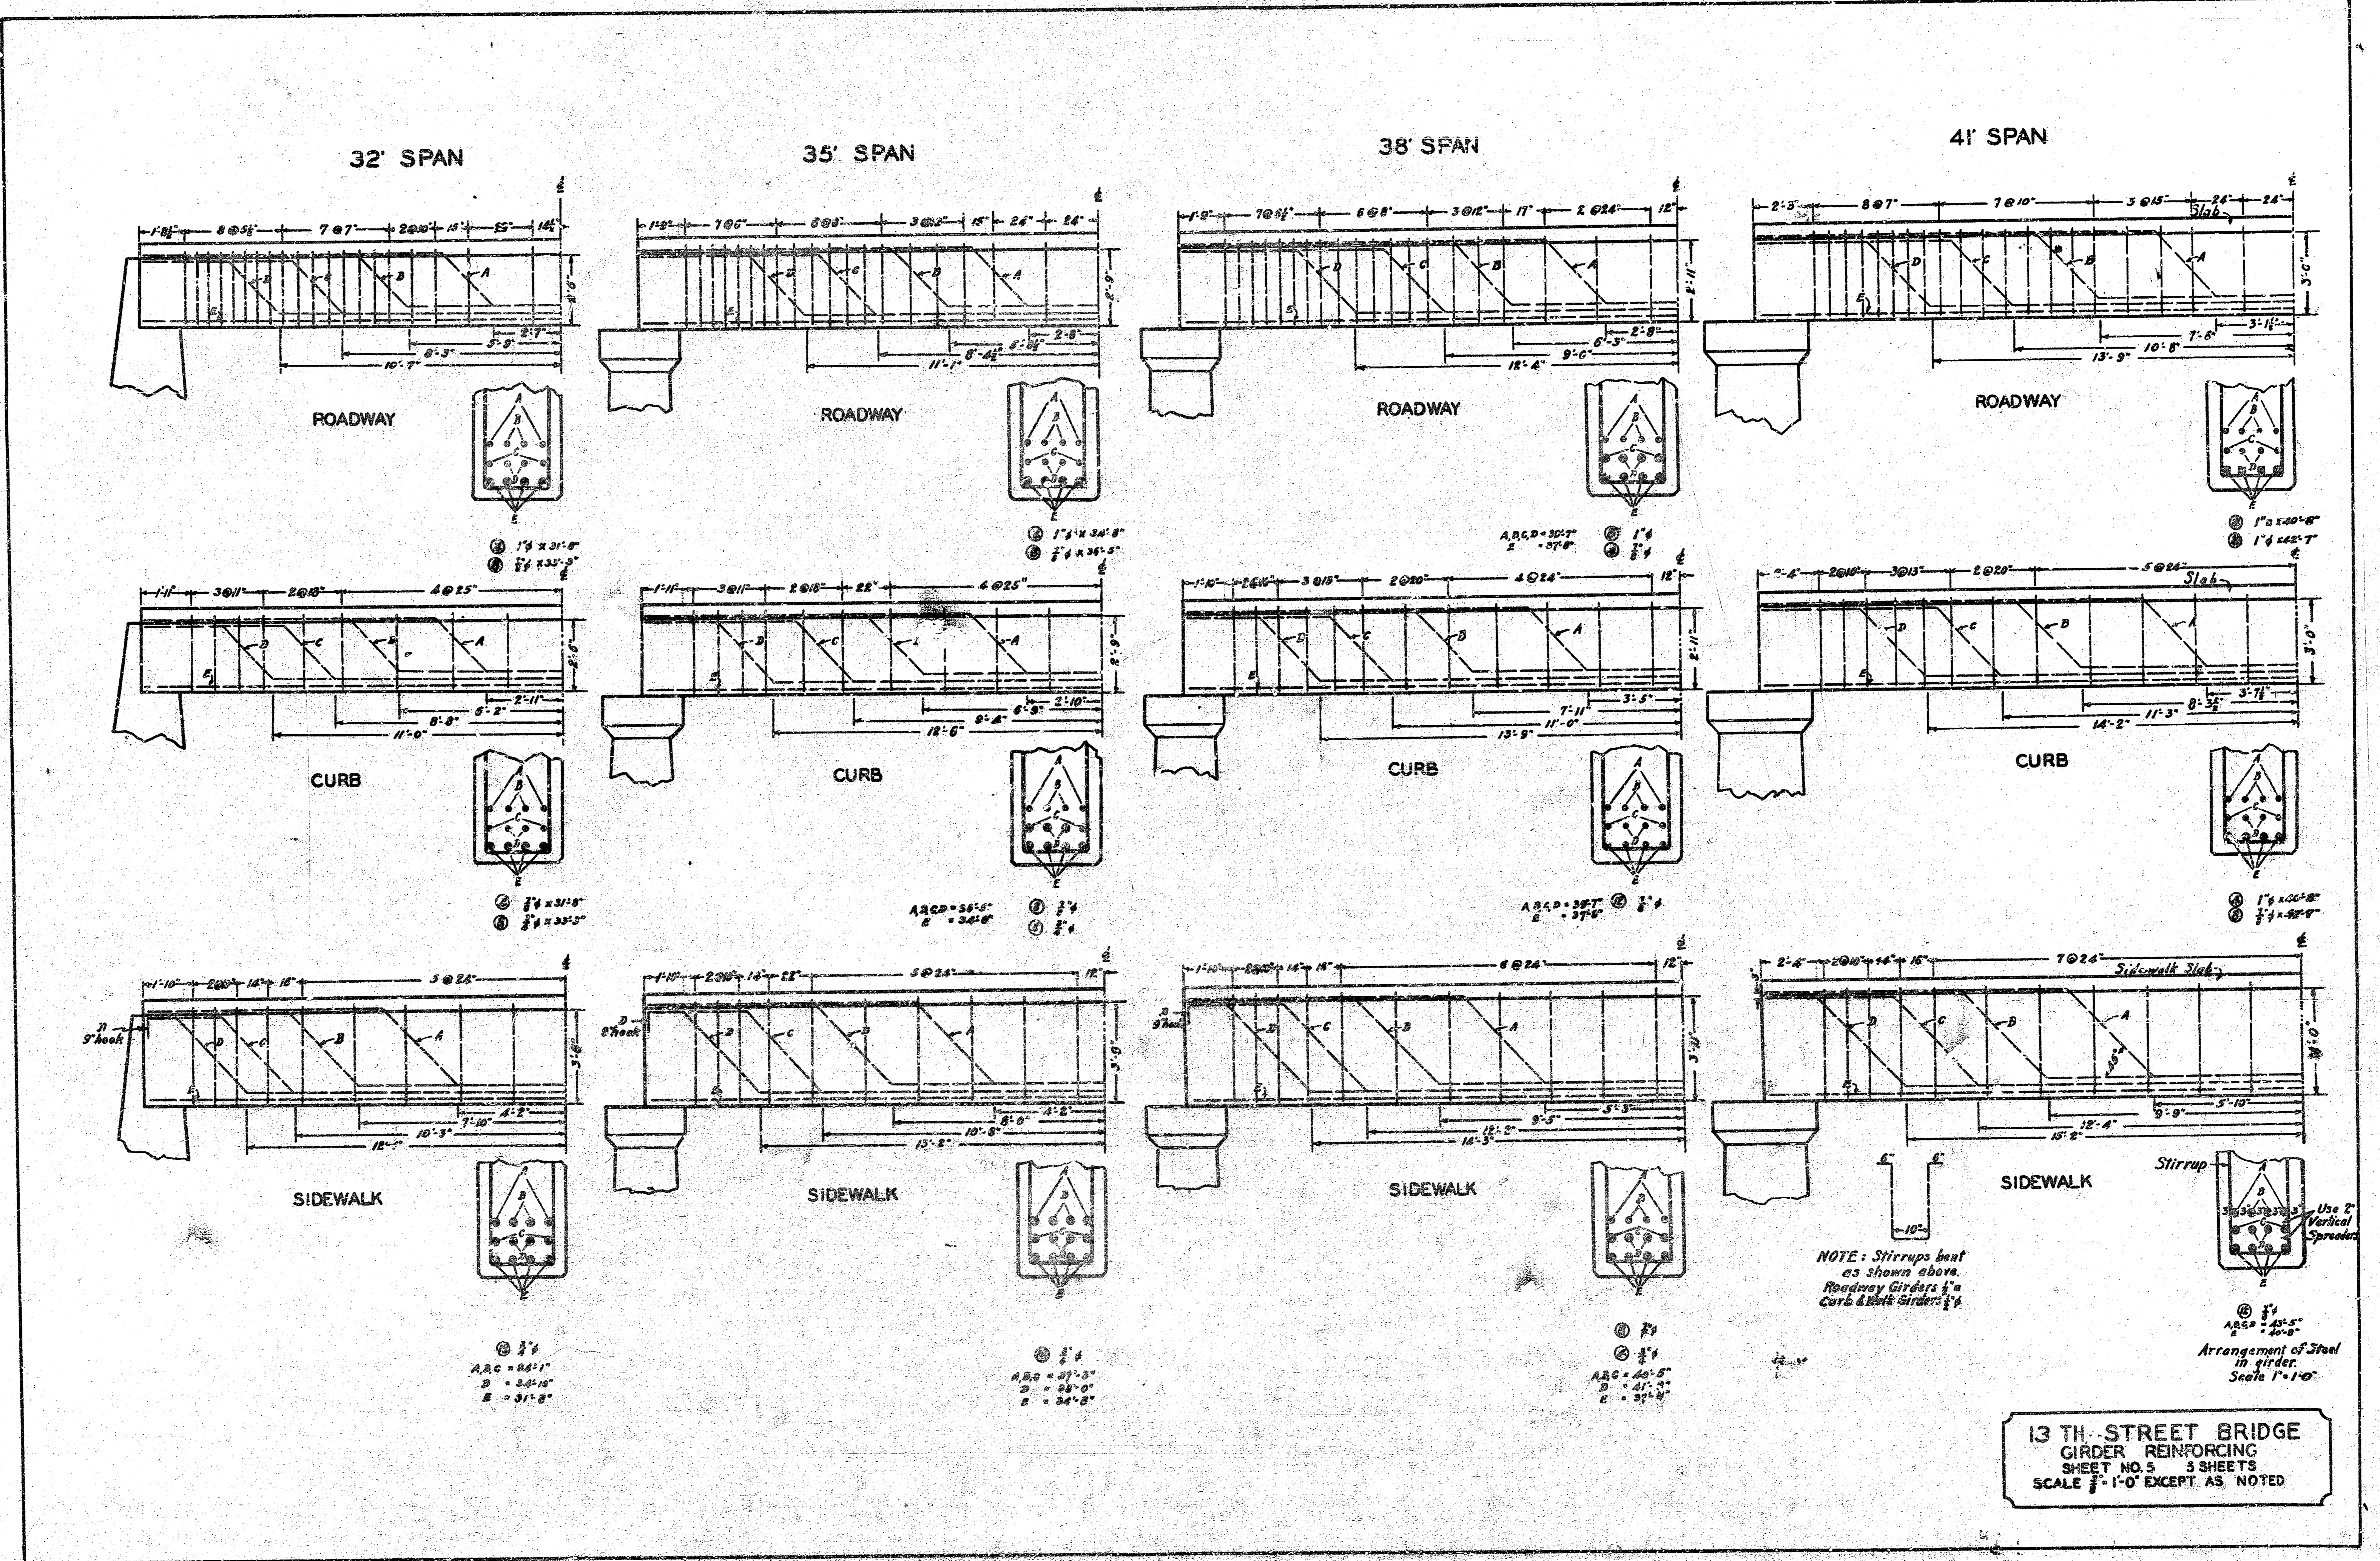


13 TH. STREET BRIDGE
 GIRDER REINFORCING
 SHEET NO. 5 OF 5 SHEETS
 SCALE 3/4" = 1'-0" EXCEPT AS NOTED

80° 60'

11/10/11

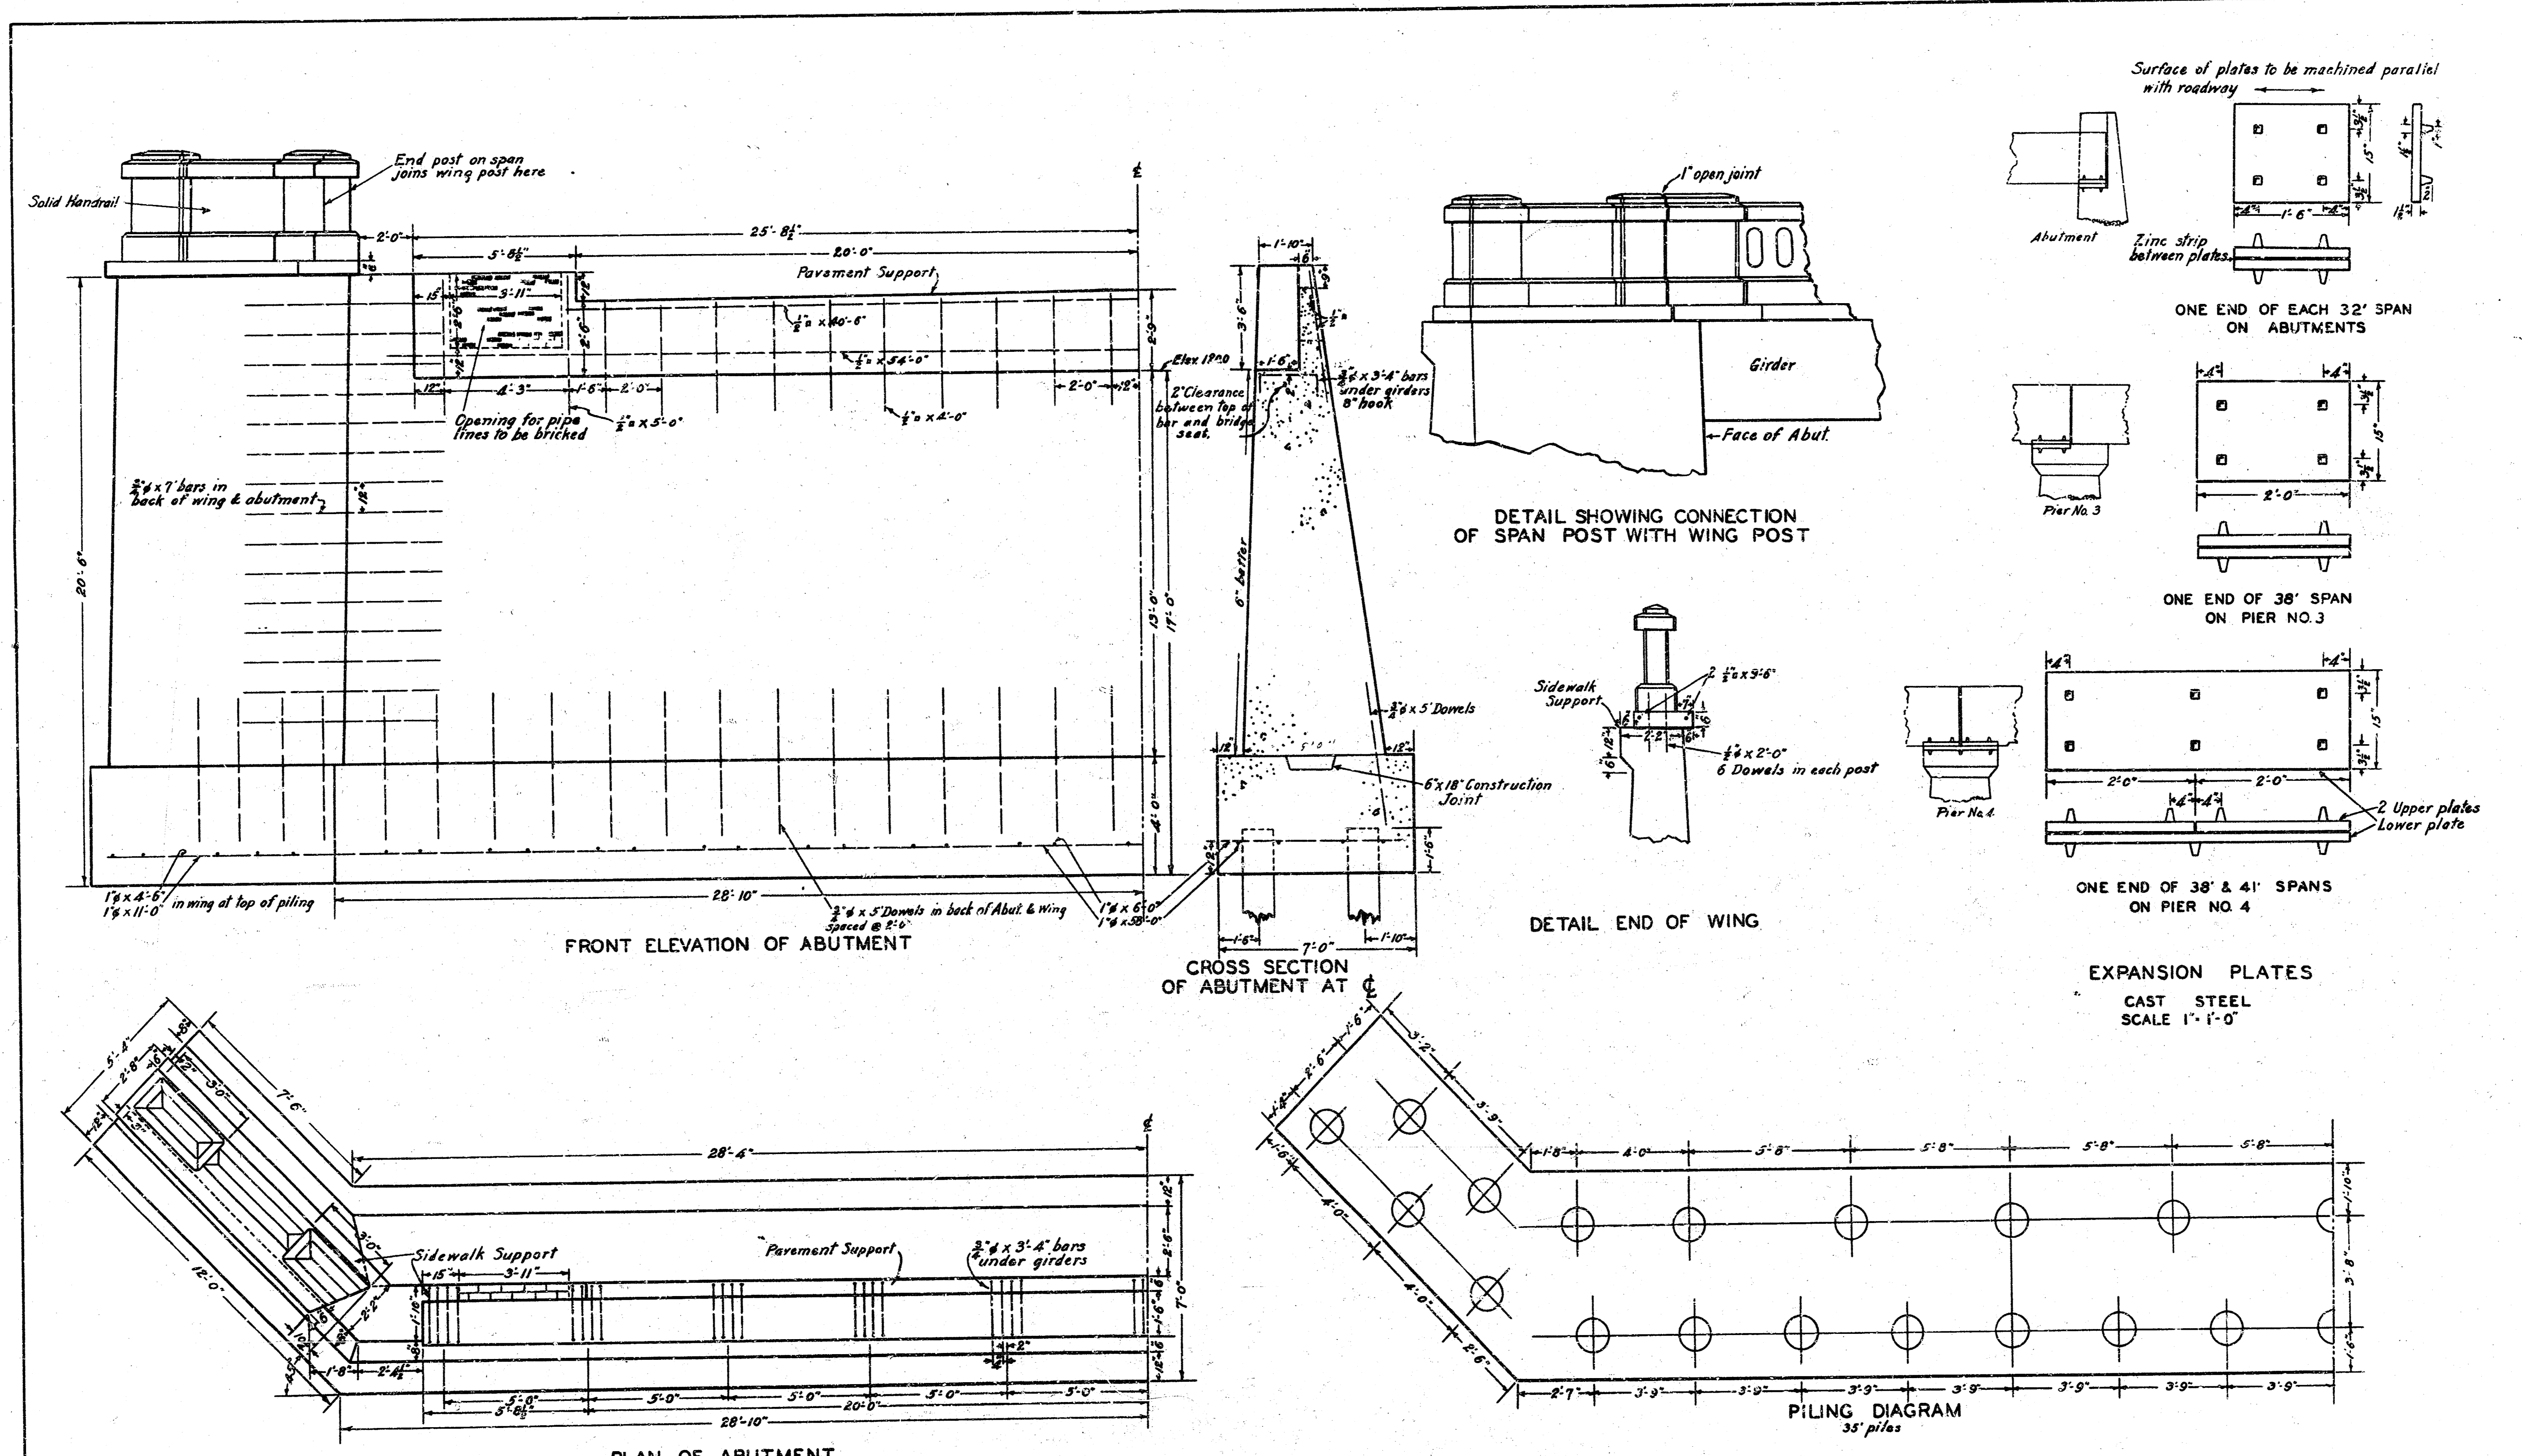


13TH STREET BRIDGE
 ABUTMENTS
 EXPANSION PLATES
 SHEET NO.3 5 SHEETS
 SCALE 1" = 1'-0"
 EXCEPT AS SHOWN

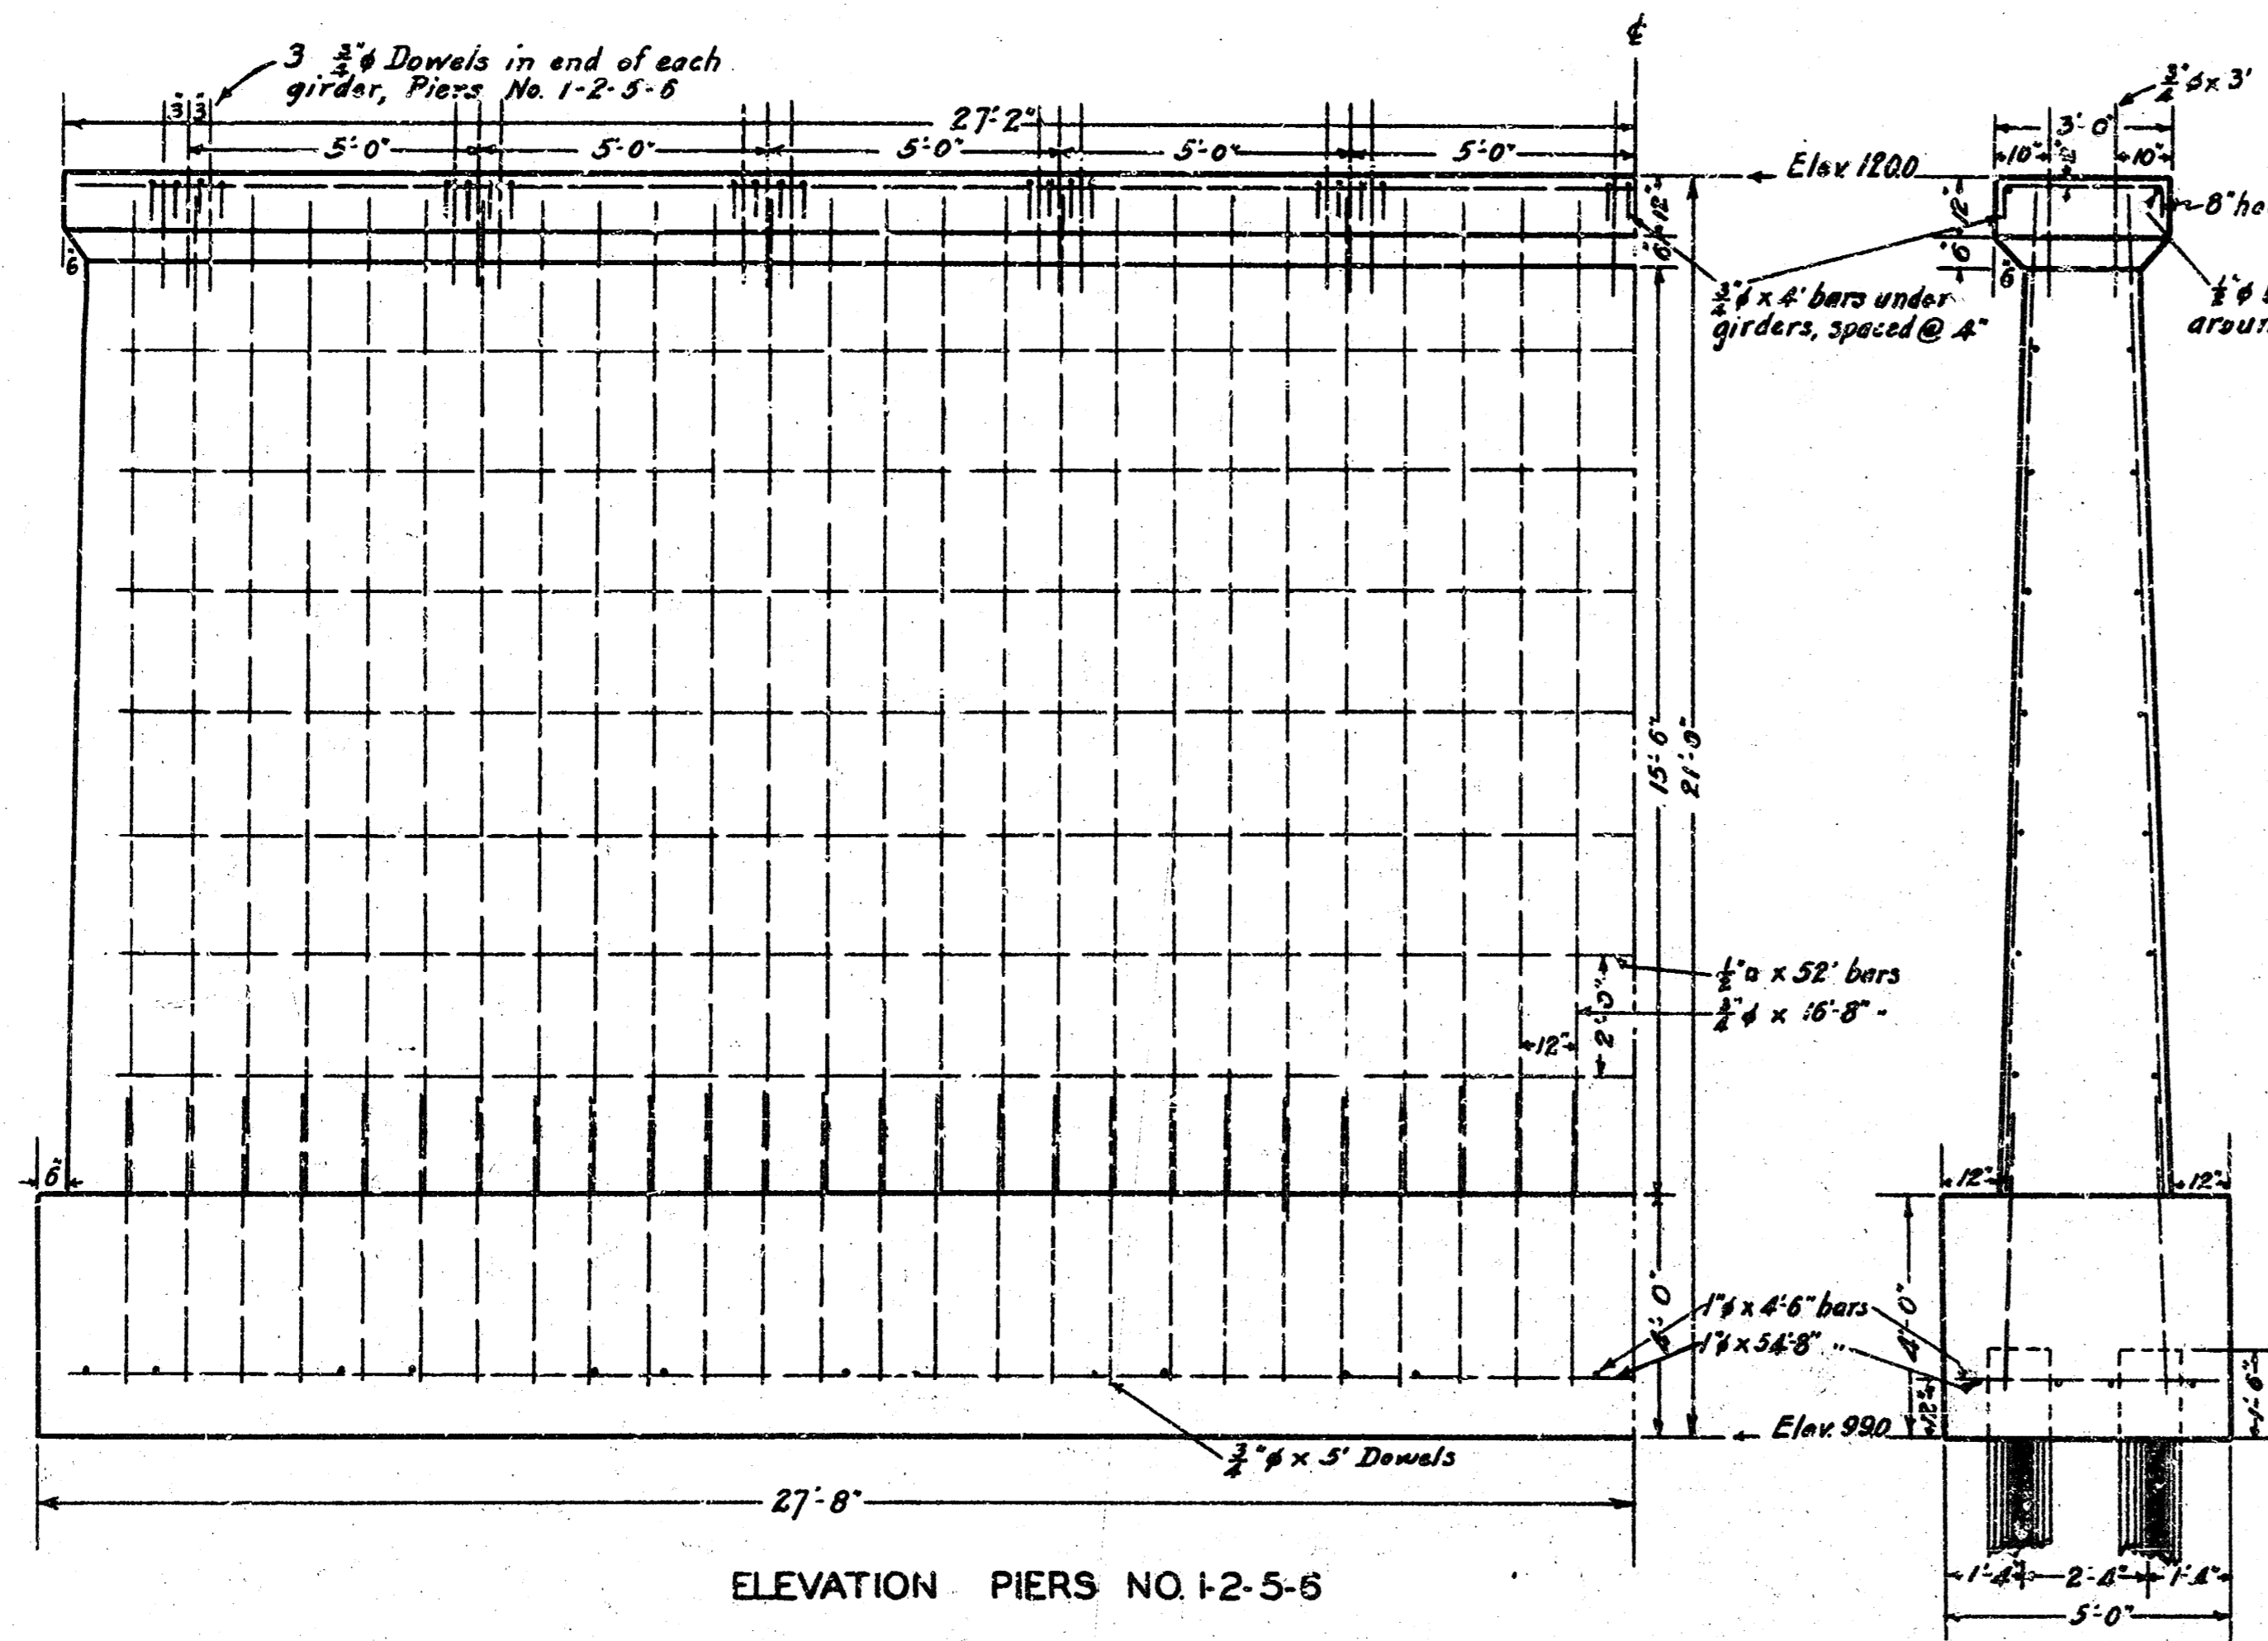


ELEVATION PIERS NO. 1-2-5-6


END VIEW PIERS NO. 1-2-5-6

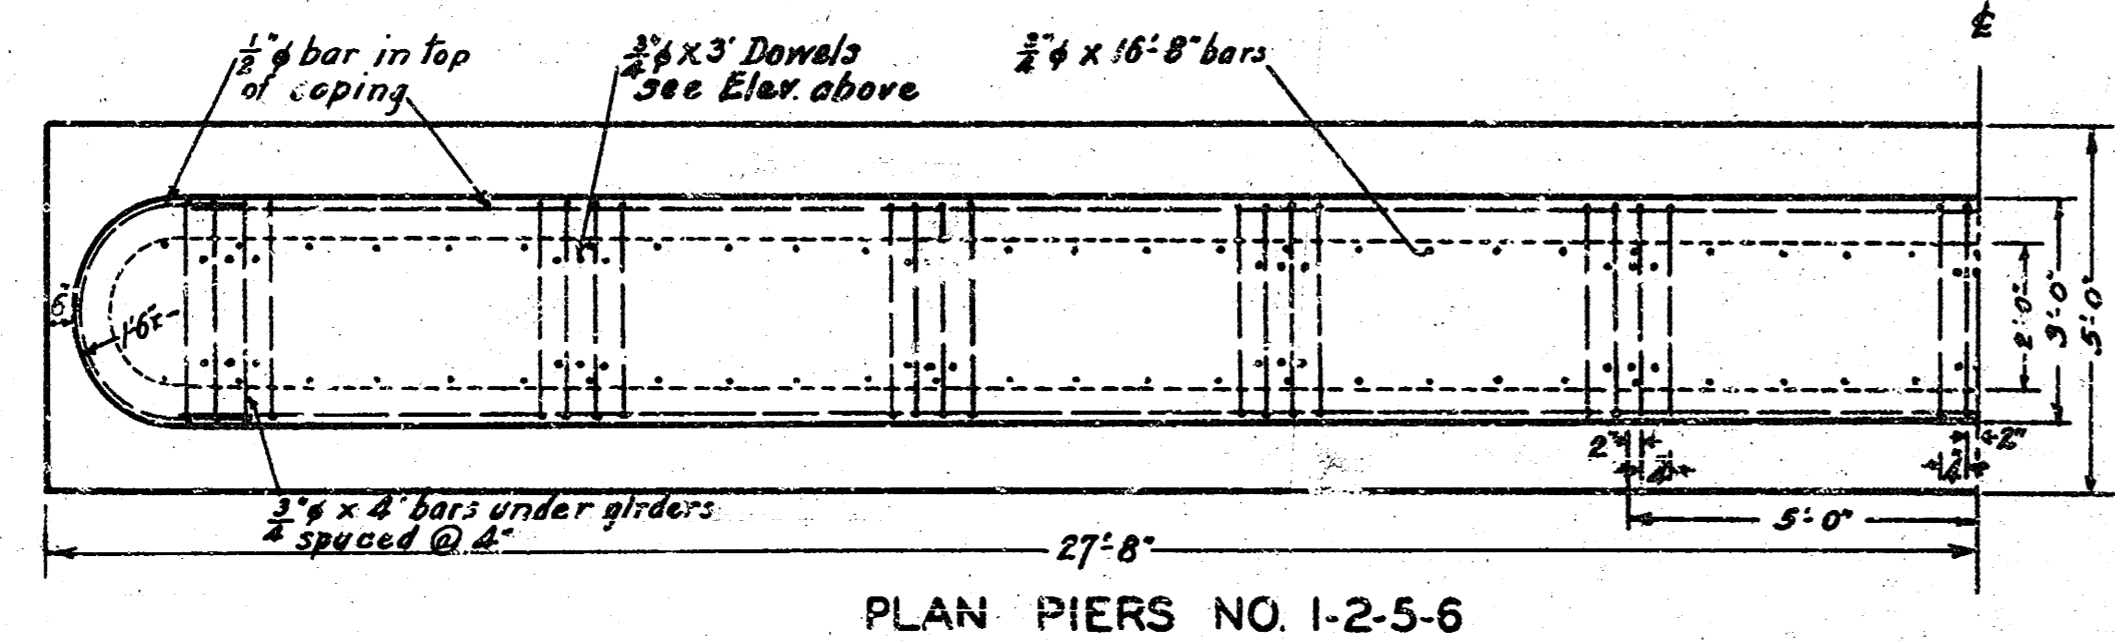


PLAN PIERS NO. 1-2-5-6

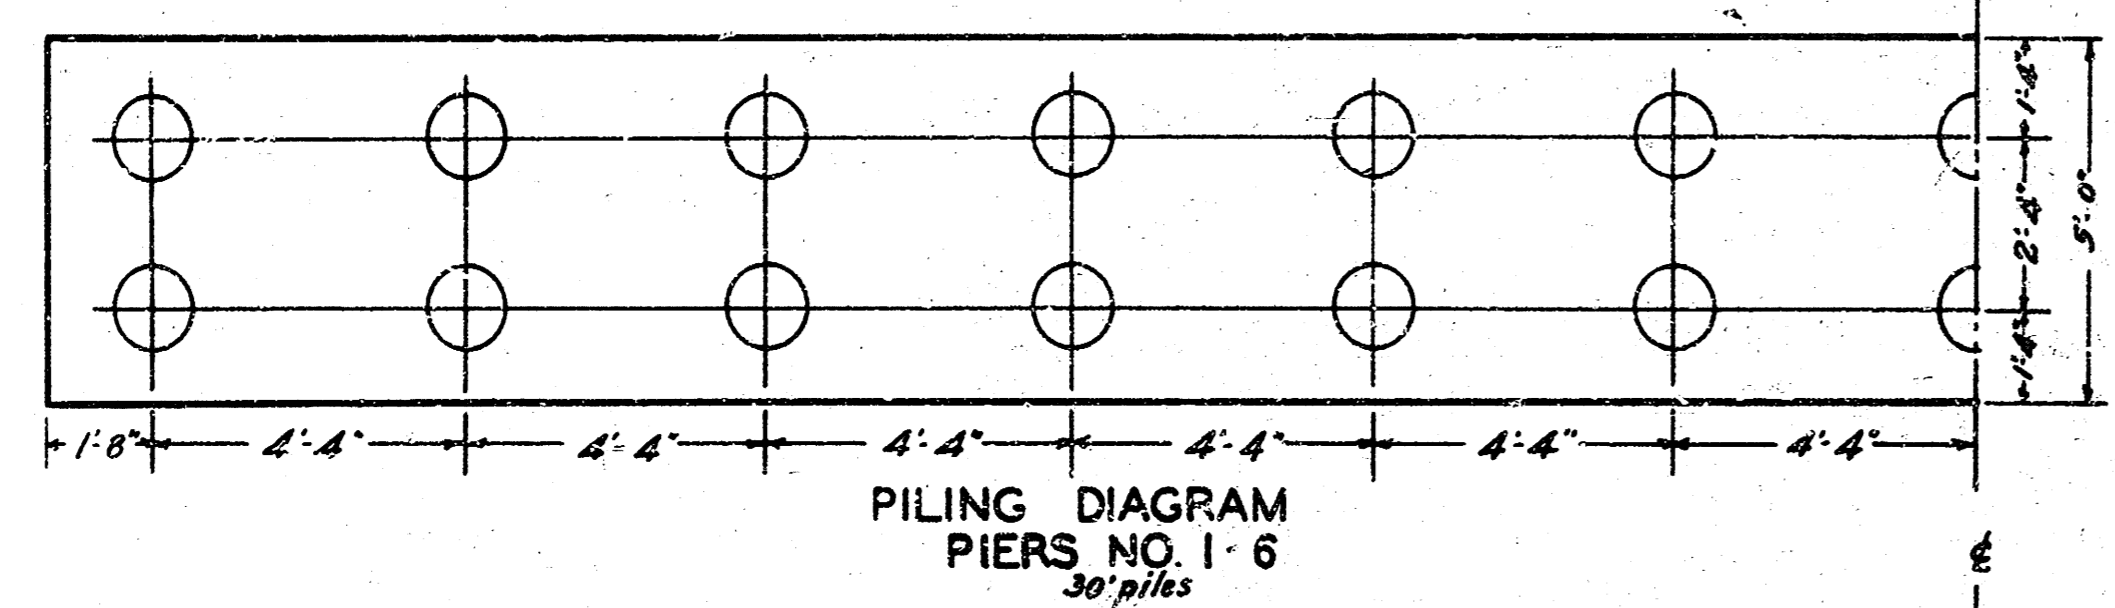


PILING DIAGRAM PIERS NO. 1-6

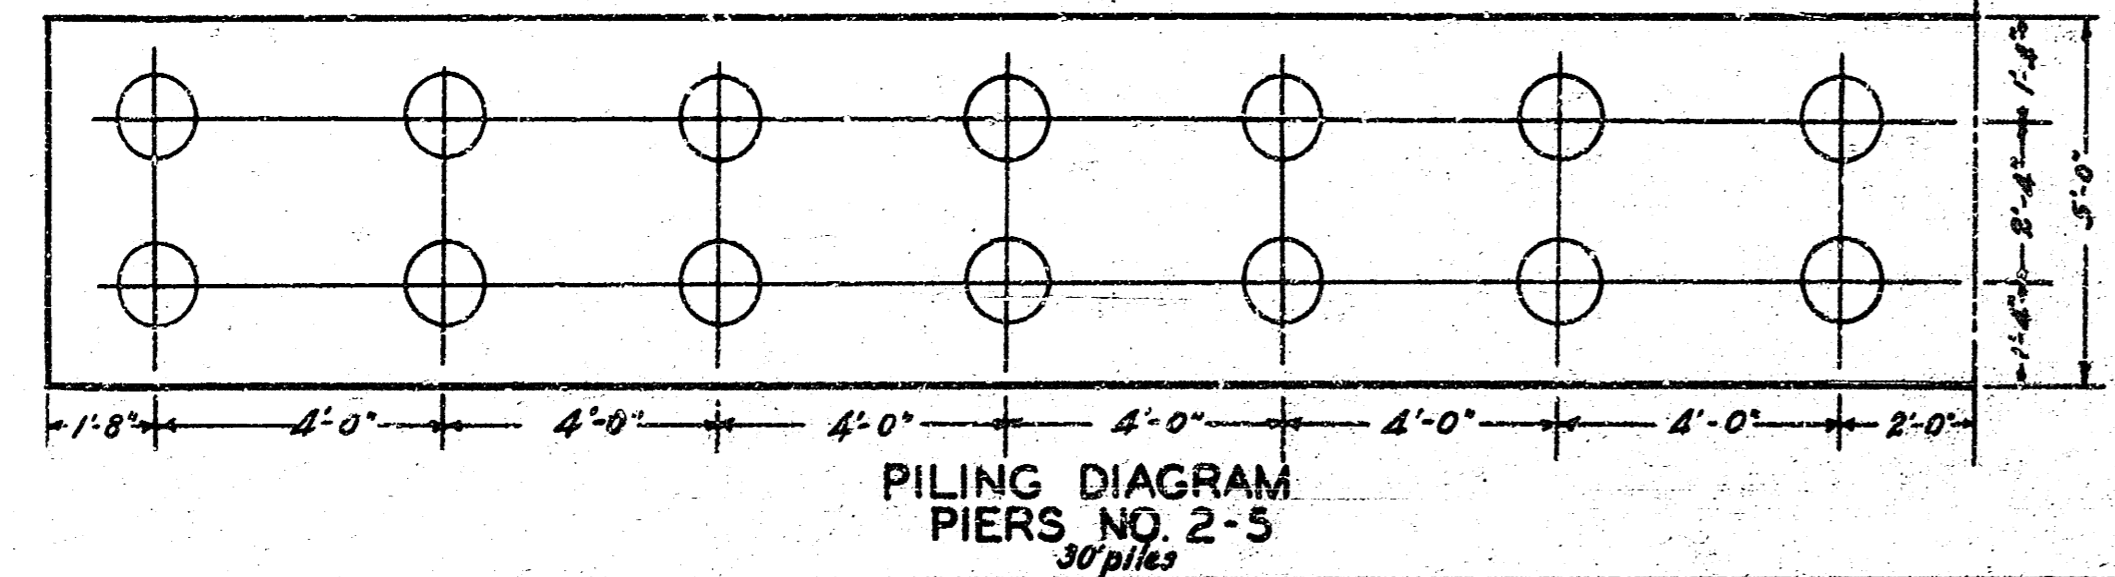

PILING DIAGRAM PIERS NO. 2-5

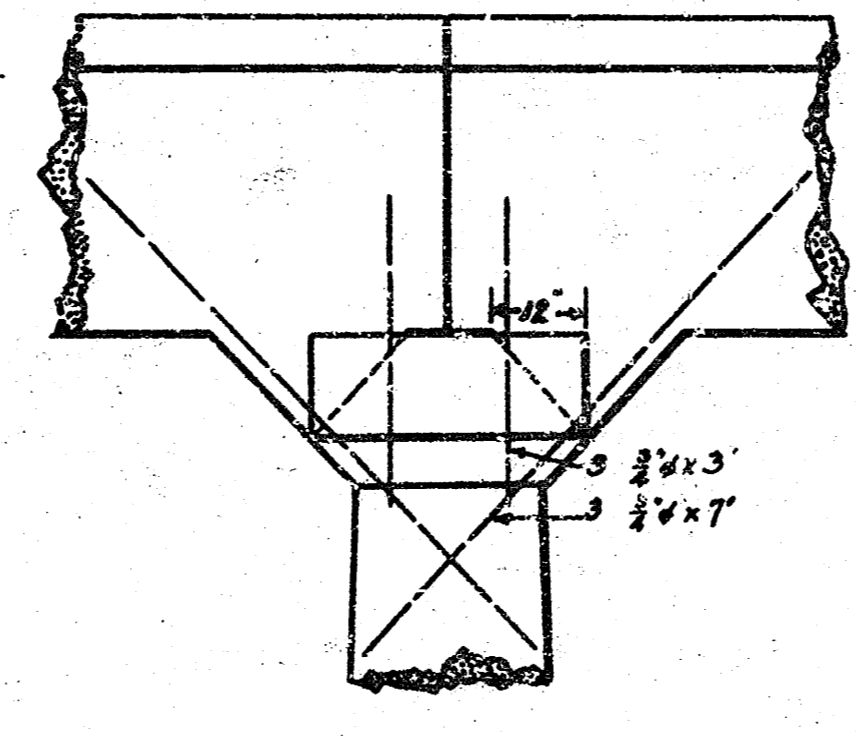


PIER & GIRDER CONNECTION PIERS NO. 1-2-5-6
Openings 15" in width to be left in piers as indicated by dotted lines, into which girders are to be cast in place.
Scale 1/2" = 1'-0"

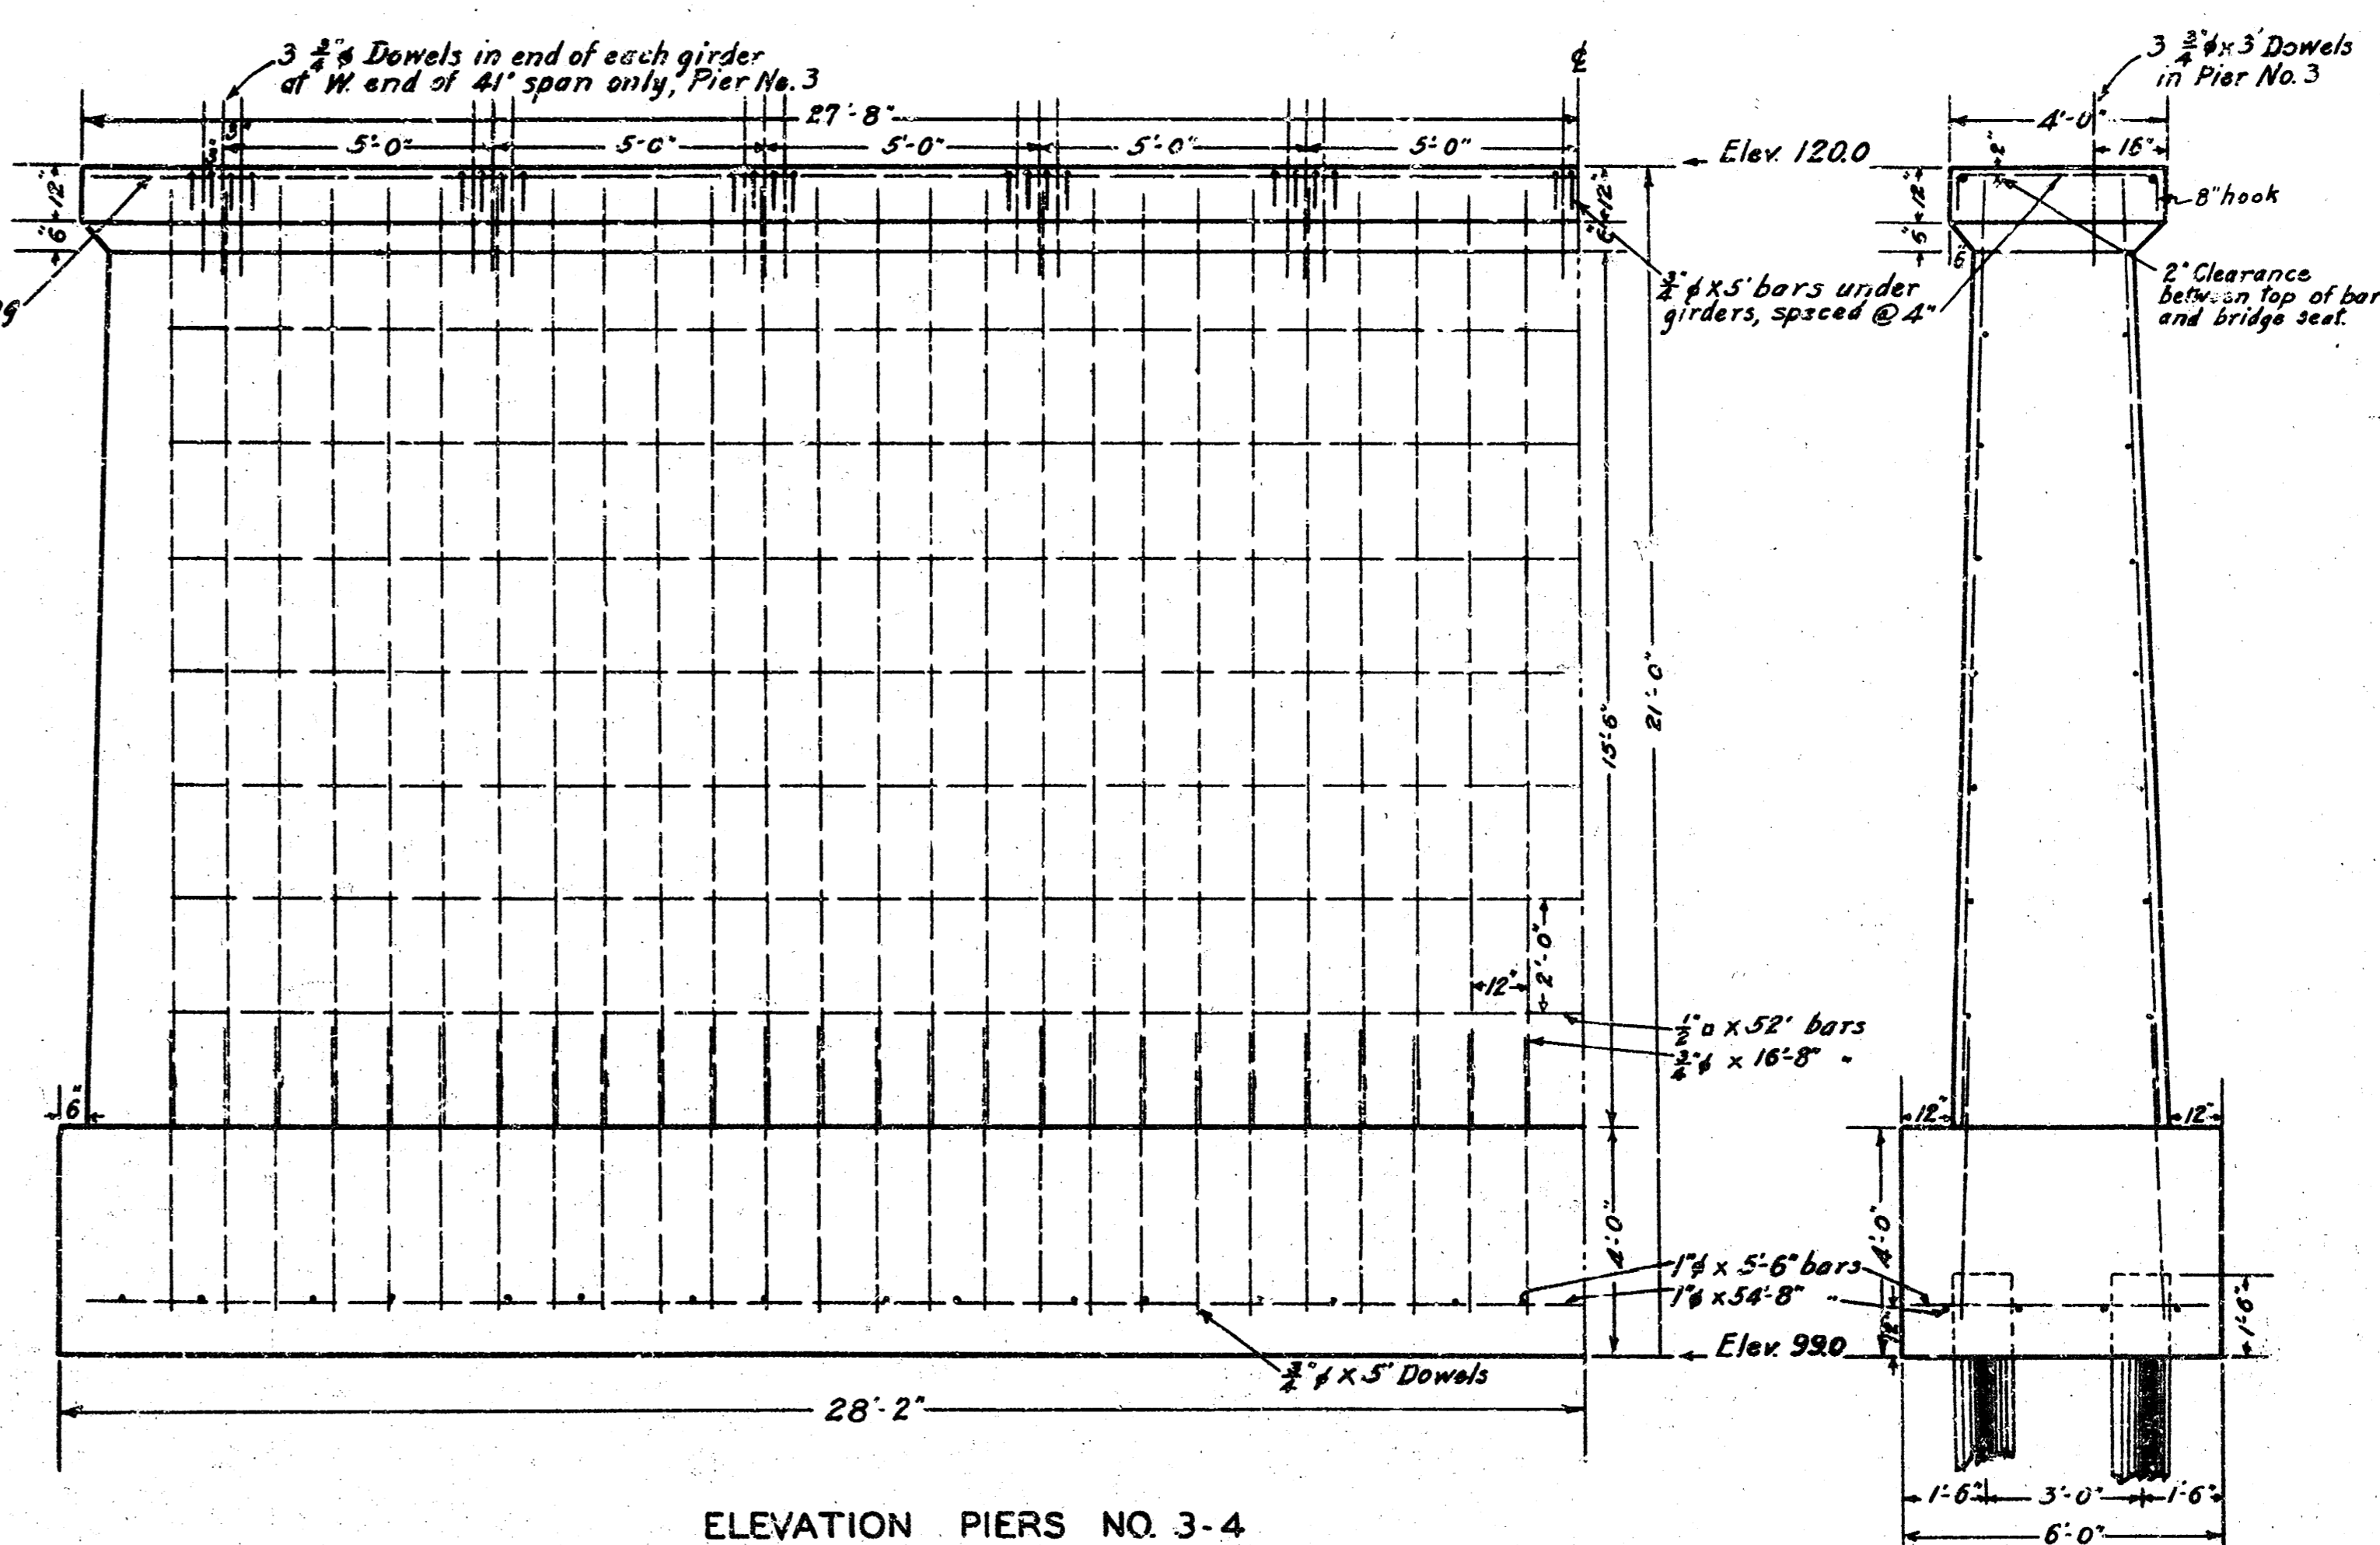


ELEVATION PIERS NO. 3-4


END VIEW PIERS NO. 3-4

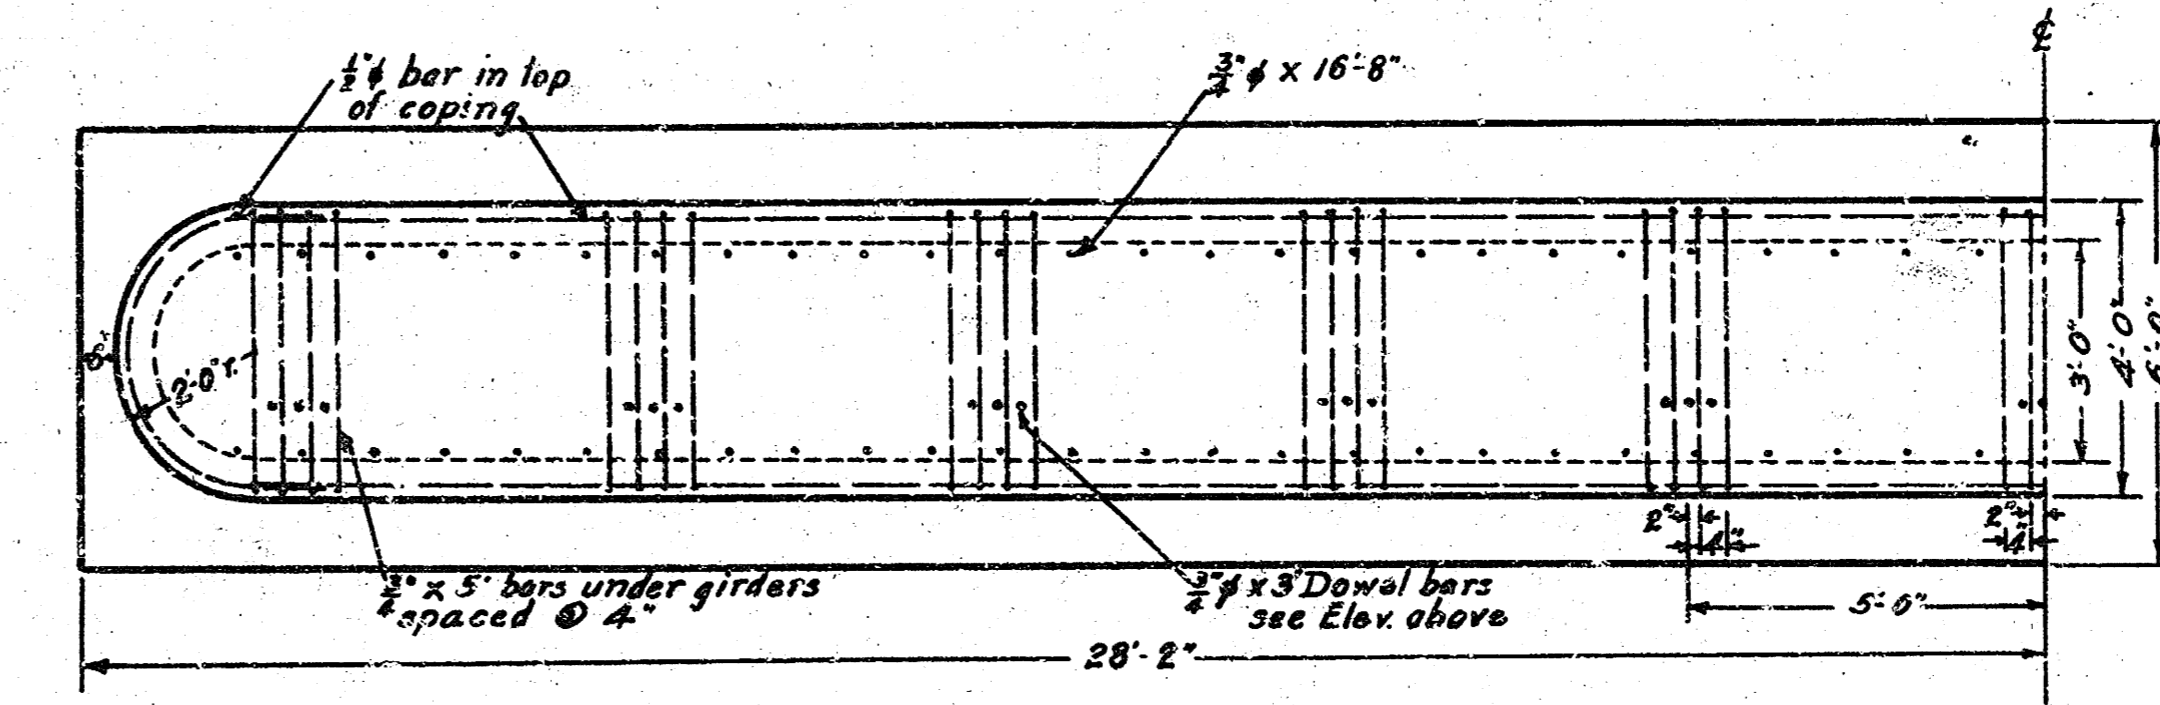

PLAN PIERS NO. 3-4

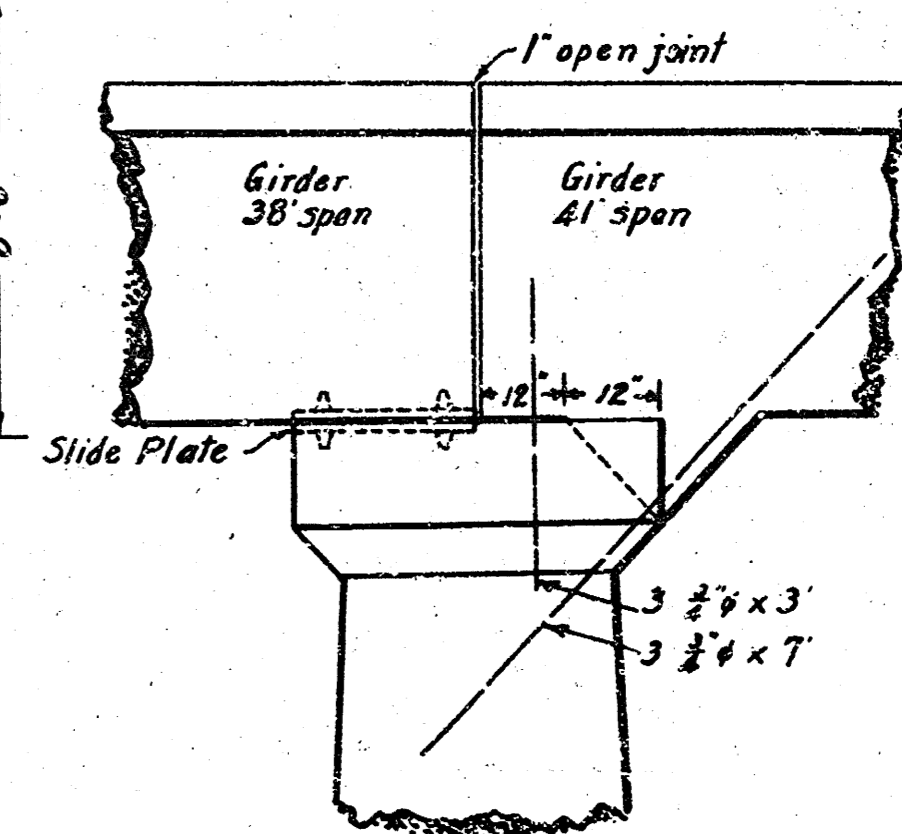

PIER & GIRDER CONNECTION PIER NO. 3
Openings 15" in width to be left in pier as indicated by dotted line, into which girders are to be cast in place.
Scale 1/2" = 1'-0"

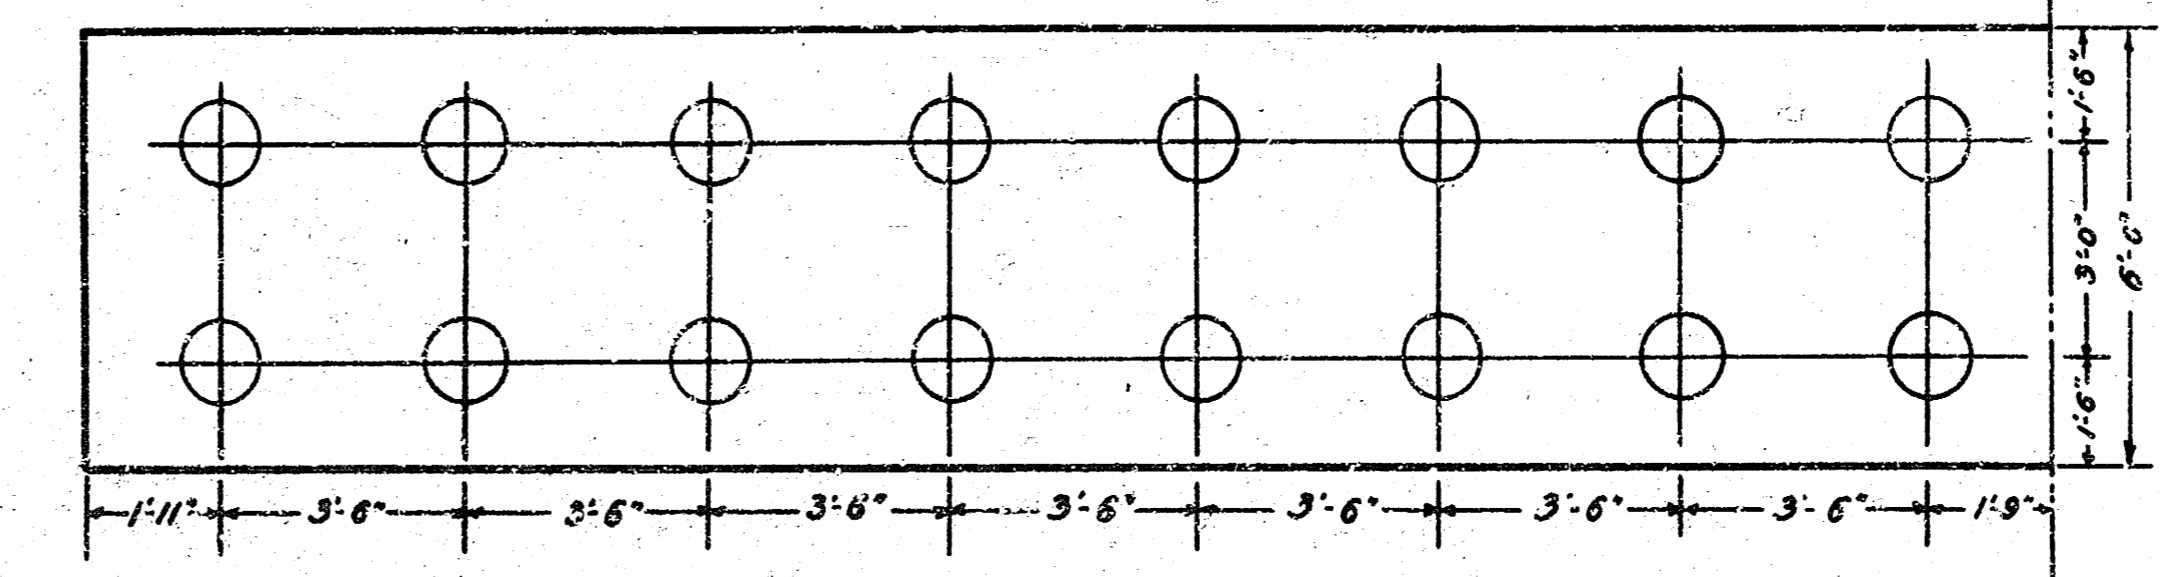

PILING DIAGRAM PIERS NO. 3-4

13TH STREET BRIDGE PIERS
SHEET NO. 2 OF 5 SHEETS
SCALE 1/2" = 1'-0"
(EXCEPT AS NOTED)

