

GRAPHIC SCALE

(IN FEET)
1 inch = 100 ft.


UTILITY LEGEND

= Fire Hydrant	= Flag Pole
= Water Meter	= SS Manhole
= Water Valve	= SWS Manhole
= Gas Meter	= Sign
= Gas Valve	= Misc. Post
= Telephone Riser	= Guy Anchor
= Mailbox	= Power Pole
= Light Pole	
= Deciduous Tree or Shrub	
= Existing Fence	
= Right of Way Line	
= Underground Telephone	
= Underground Electric	
= Overhead Electric	
= Water Line	
= Sanitary Sewer	
= Gas Line	
= Cable TV or Fiber Optic	

- Proposed 5" A.C. Pavement on 5" Crushed Rock Base
- Proposed Concrete Curb & Gutter
- Exist. Road Gravel To Be Removed
- Propose Pavement Removal

- BENCHMARKS:**
- SBM #1 - "T/C N. Side St. Louis ±50' E. & ±15' N. of CL Intersection St. Louis Ave. & Baehr St.
 - SBM #2 - 1/2" Capped Rebar w/Savoy Ruggles & Bohm Cap ± SW Corner Intersection Newell Ave. & Baehr St.
 - SBM #3 - "T/C N. Side Handicap Ramp SW Corner Intersection Central Ave. & Baehr St.

UTILITIES SHOWN REPRESENT THE BEST INFORMATION AVAILABLE FOR DESIGN. ADDITIONAL UTILITIES MAY BE PRESENT ON THIS PROJECT. THE CONTRACTOR SHALL BE RESPONSIBLE FOR DETERMINING THE EXACT LOCATION, DEPTH AND SIZE OF ALL UNDERGROUND UTILITIES PRIOR TO CONSTRUCTION. THE CONTRACTOR SHALL BE LIABLE FOR ANY DAMAGE CAUSED BY THE FAILURE TO DO SO.

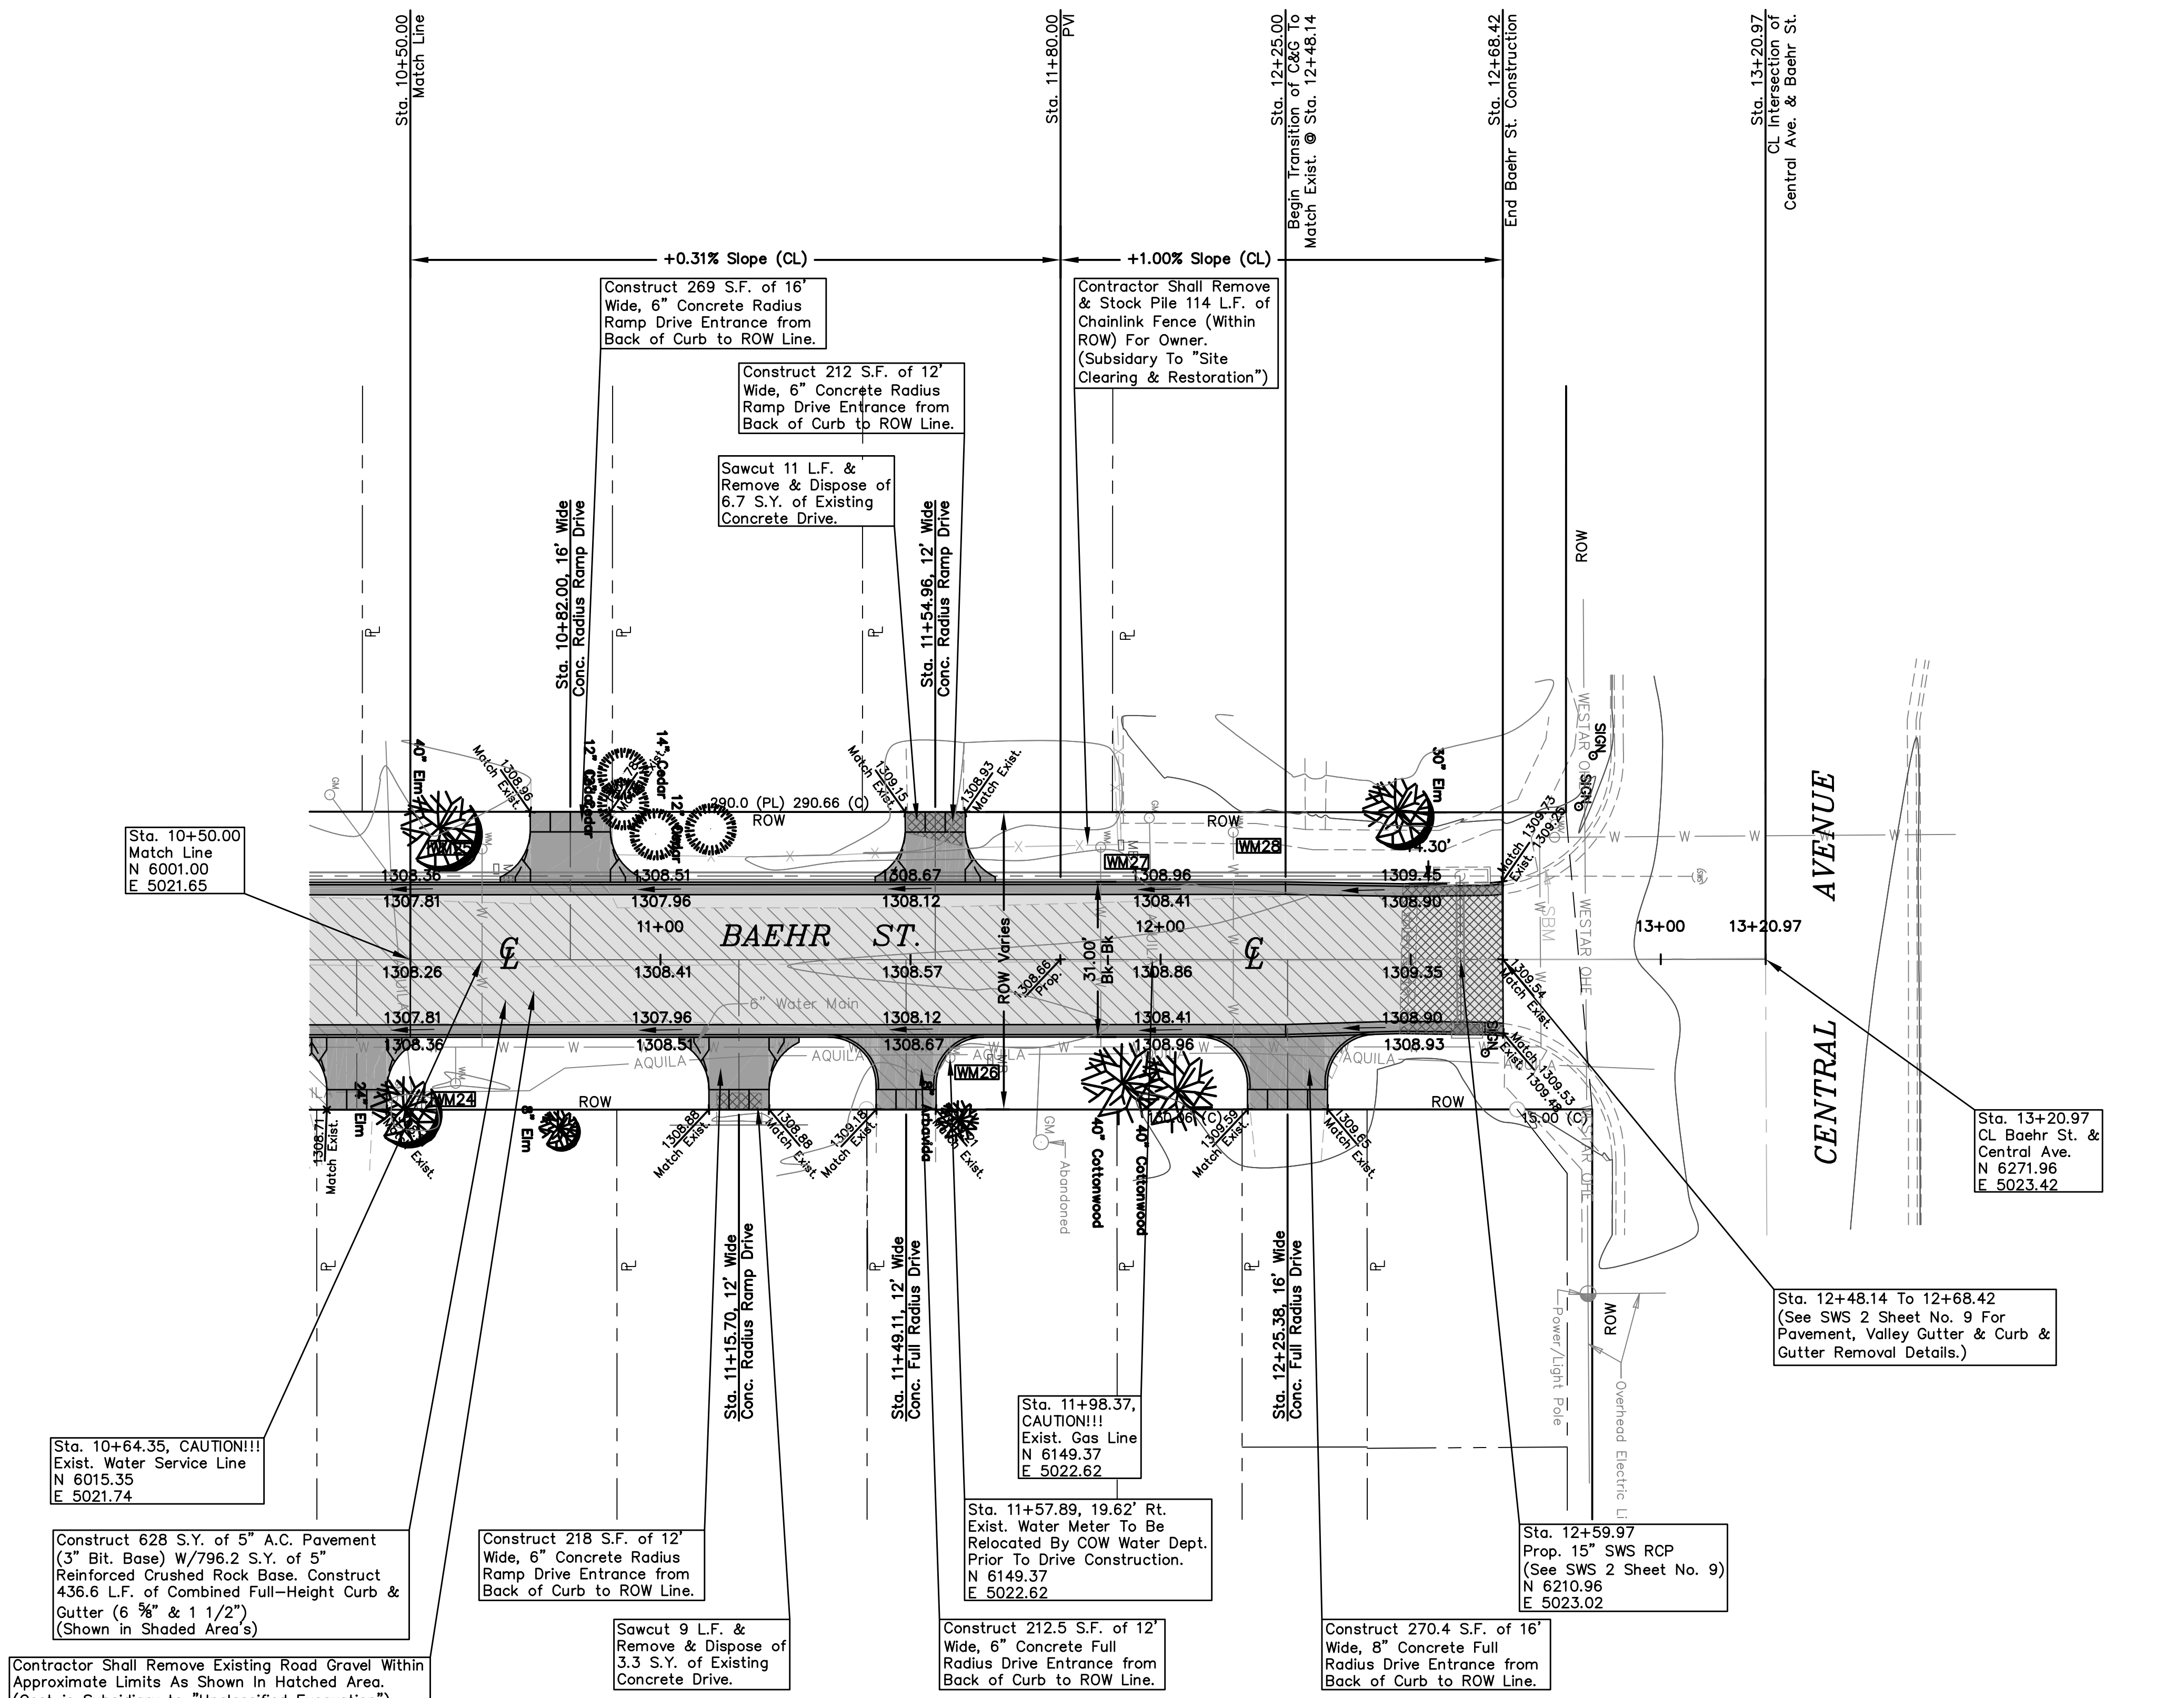

WM1 - Water Meter

Water Meter Box Adjustment Table

WM #	BL Station (CL Baehr Street)	Feet Rt./Lt.	Existing Elevation	Proposed Elevation
24	10+59.04	24.70 Rt.	1309.04	1308.58
25	10+64.35	22.15 Lt.	1308.74	1308.54
26	11+57.89	19.62 Rt.	1309.03	Relocate
27	11+88.04	22.61 Lt.	1309.05	1308.98
28	12+14.54	25.44 Lt.	1309.47	1309.30

SEE GENERAL NOTE 15 ON TITLE SHEET FOR MAILBOX RELOCATIONS.

General Note: The Contractor Shall NOT Remove Any Trees Within Baehr St. ROW Unless Approved By The Engineer. Contractor Shall Exercise Care During Construction of Baehr St. So Not To Damage Any Trees.

PAVING PLAN FOR
BAEHR STREET
WICHITA, SEDGWICK COUNTY, KANSAS
CED PROJ. NO.: 20071583
CERTIFIED ENGINEERING DESIGN, P.A.
810 WEST DOUGLAS, SUITE C
WICHITA, KANSAS 67203
PH.(316)262-8808 FAX.(316)262-1669

DESIGNED: HDF	SCALE: 1"=20'	SHEET
DRAWN: JDT	DATE: 10-07	8
CHECKED: HDF	CED FILE: Baehr St-Base	TOTAL 24