



NOTE: THIS STREET TO BE CONSTRUCTED WITH ROLL-TYPE CURB. TOP OF CURB ELEVATIONS GIVEN ARE FOR FULL HEIGHT CURB.

SCALE: 1"=10'

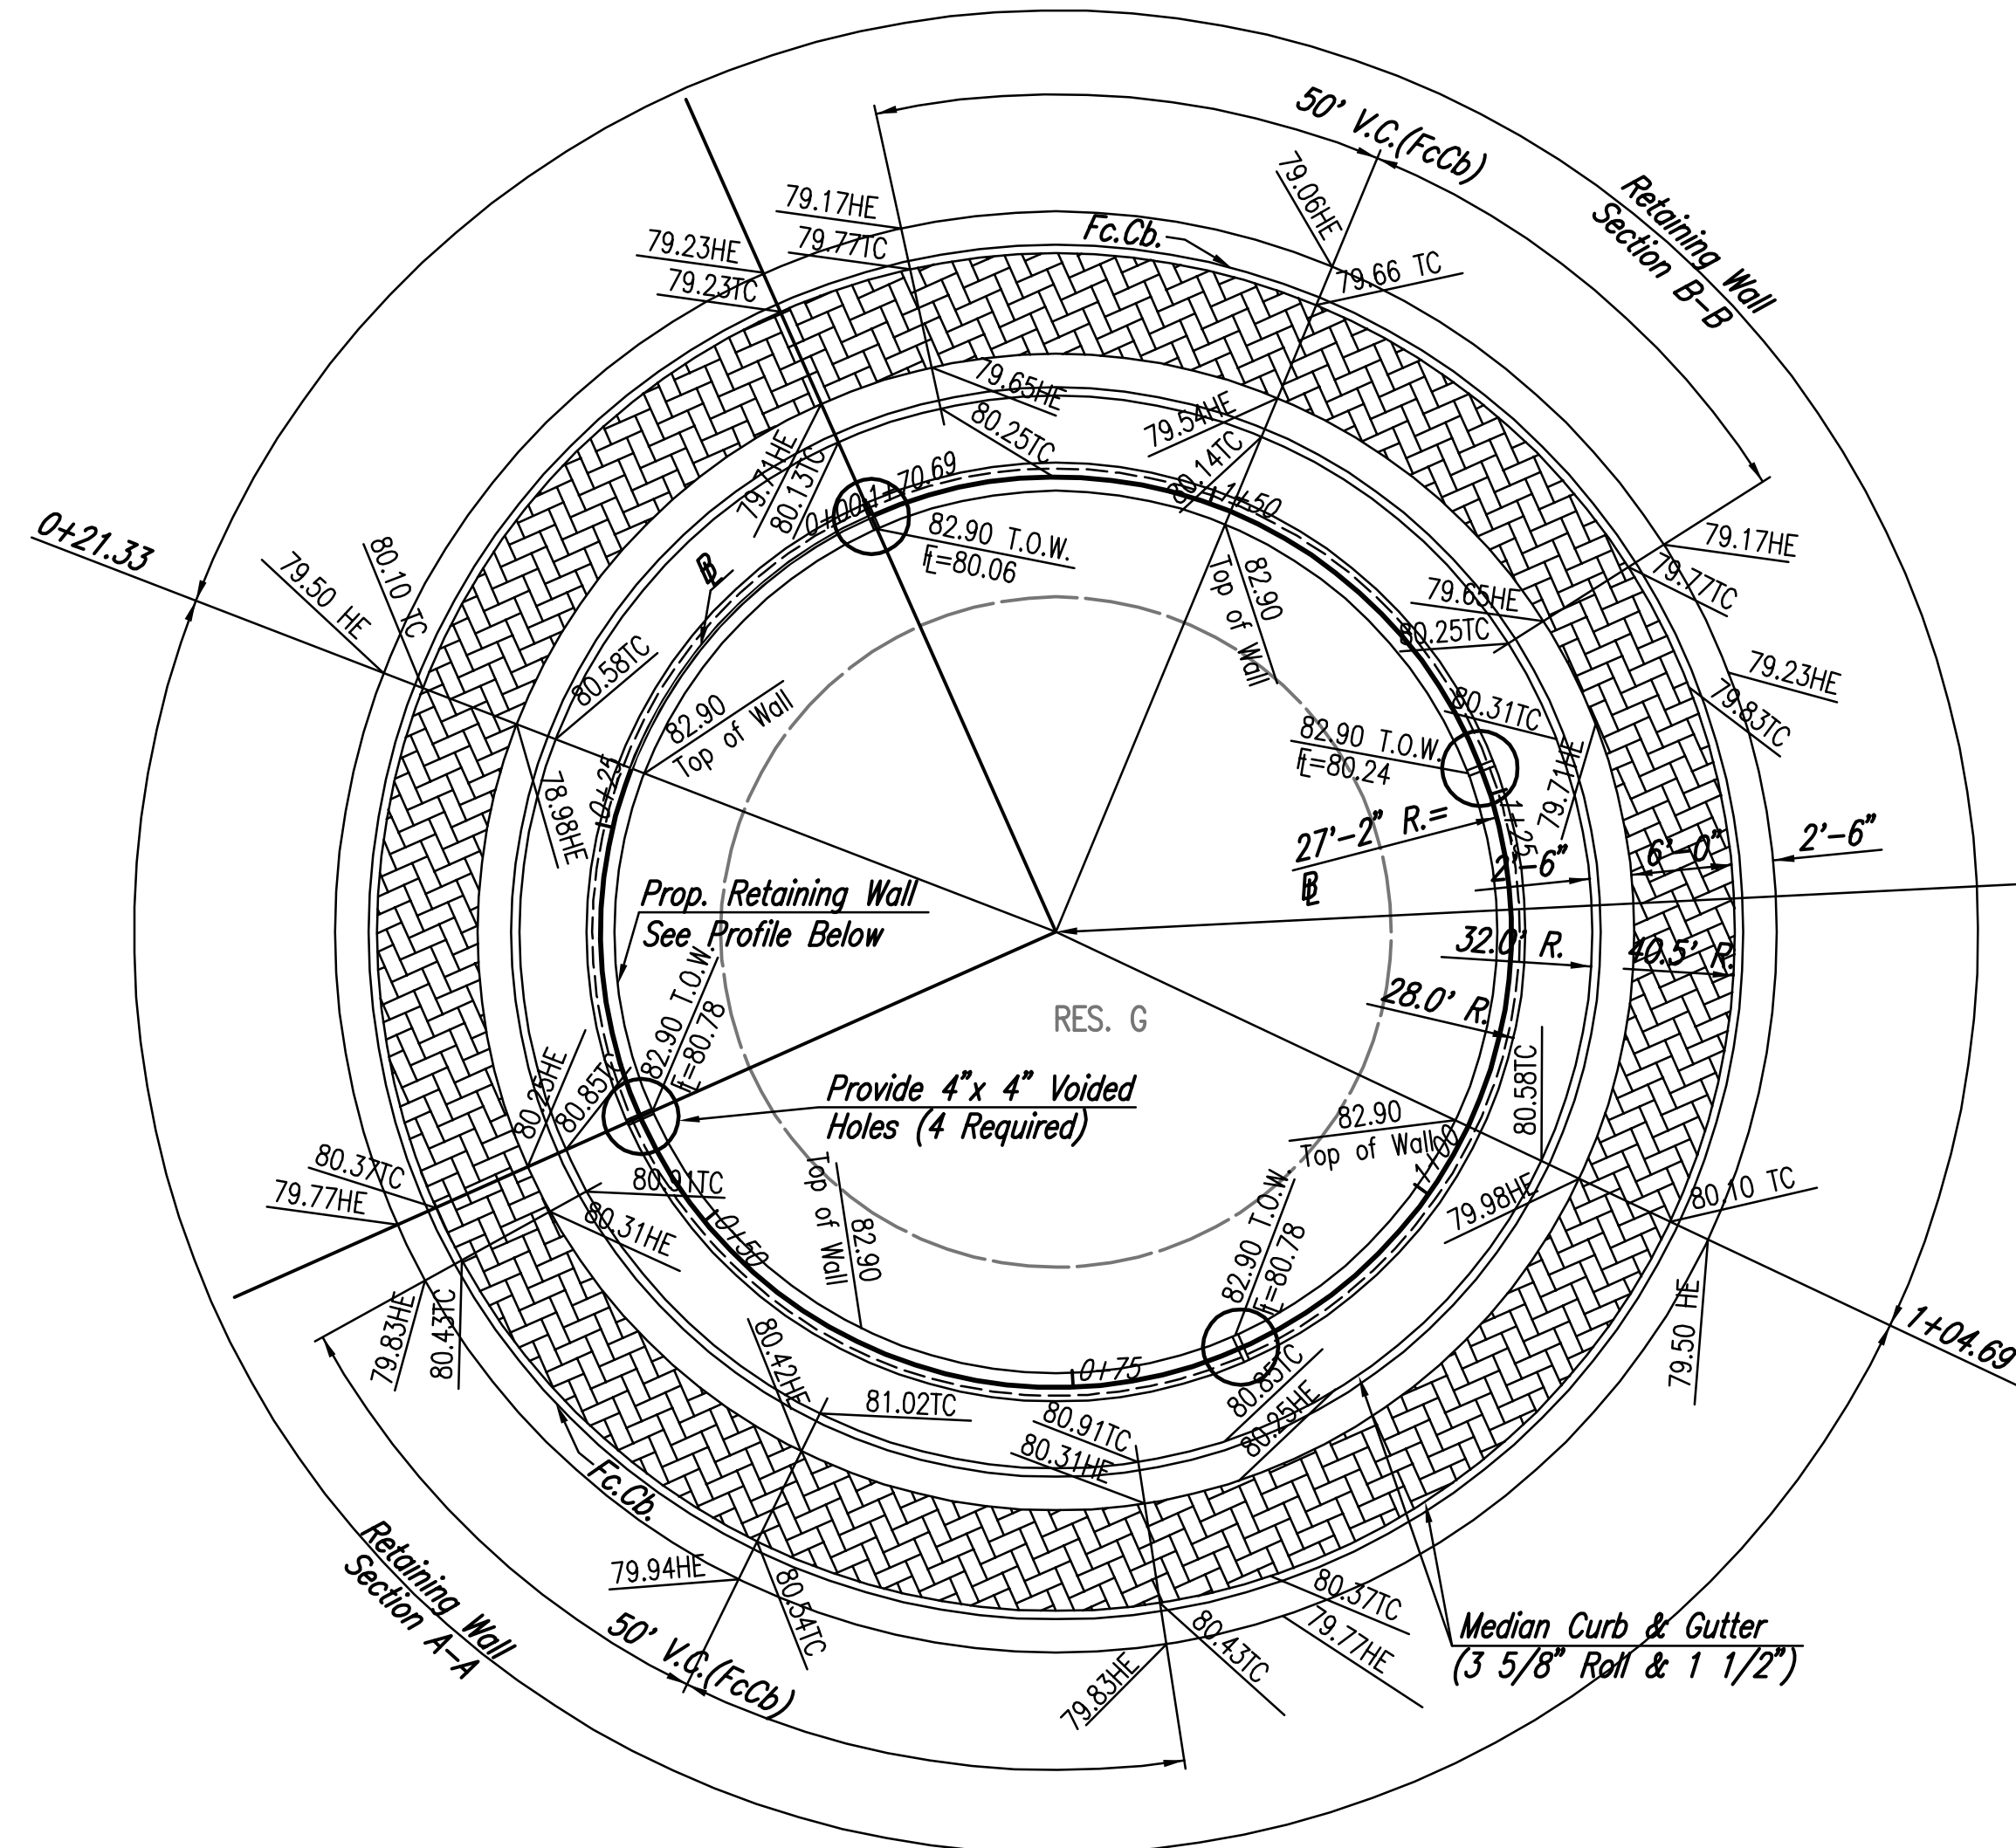

Sta. 19+98.27 @ Chateau Parkway(W)=  
Sta. 20+00.00 @ Chateau Parkway(N)


Proposed 4" x 4" Voids Hole  
Elevation Shall Be 0.10' Above  
Proposed Ground.

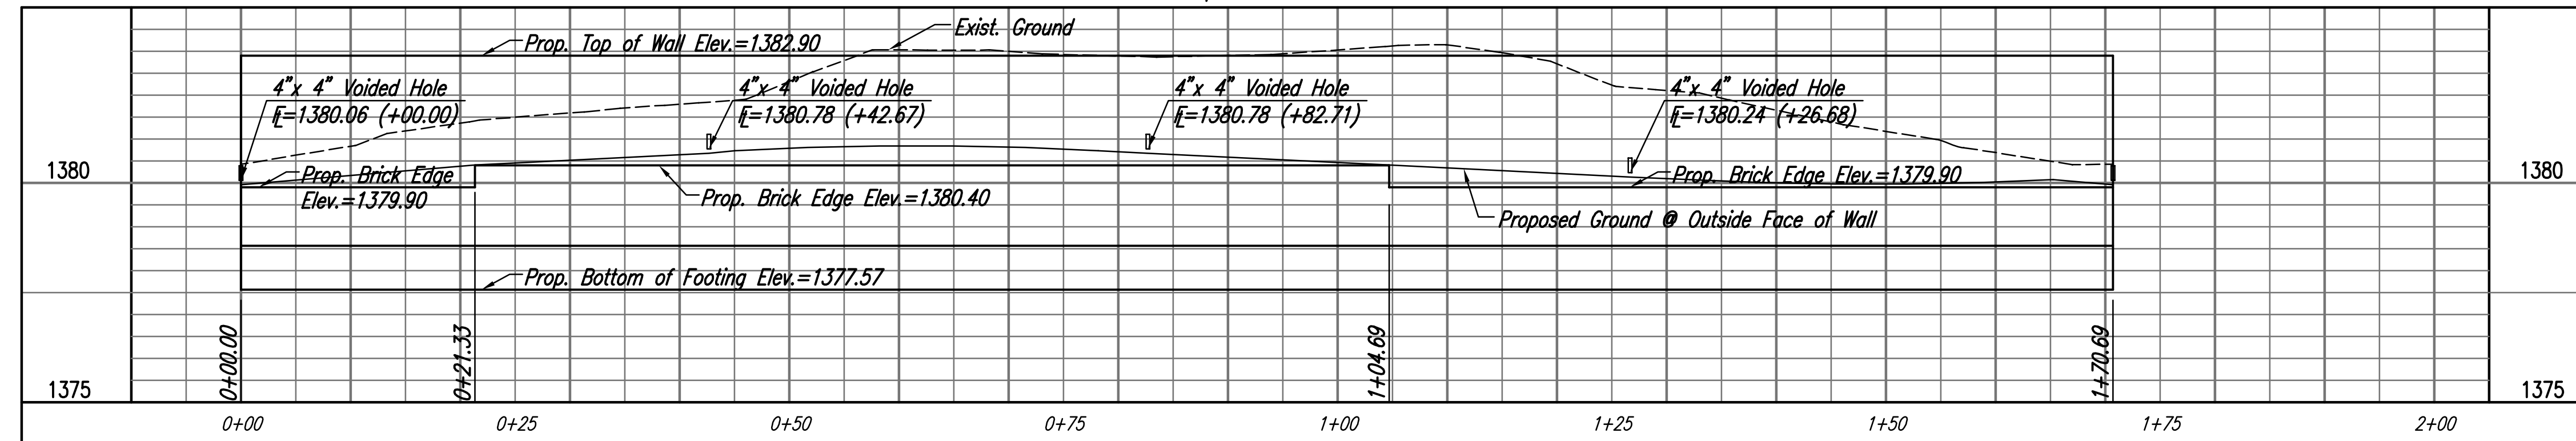

T.O.W. = Top of Wall

Retaining Wall Section A-A, & B-B See Sheet No. 25.

Saved: 11-07-2006 5:47:14 AM by BJS  
 Plot Scale: 1:10 11-07-2006 11:59:24 AM by BEJ  
 J:\SENTOUT\2005\05731\003\2006-11-07 to City DMV\24-ROUNDABOUT-RETAIN WALL

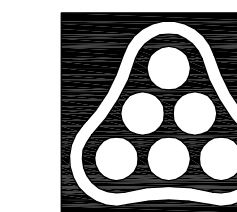

No.	Revision	By	Date
OAK CREEK 2ND - PHASE 2			
<b>ROUNDABOUT RETAINING WALL LAYOUT</b>			
STA. 19+98.27			
JAMES L. ARMOUR, P.E. - CITY ENGINEER			
CITY OF WICHITA PROJECT NO. 472-84449			
<b>Professional Engineering Consultants, P.A.</b>			
303 S. TOPEKA • WICHITA, KANSAS 67202			
316-262-2691 • FAX 316-262-3003			
Designed by	BDB, BMM	Job No.	35-05731-003
Drawn by	BJS, TAT	Date	February 2006
			Sheet 24 of 84