



PLAN
Dimensional Control

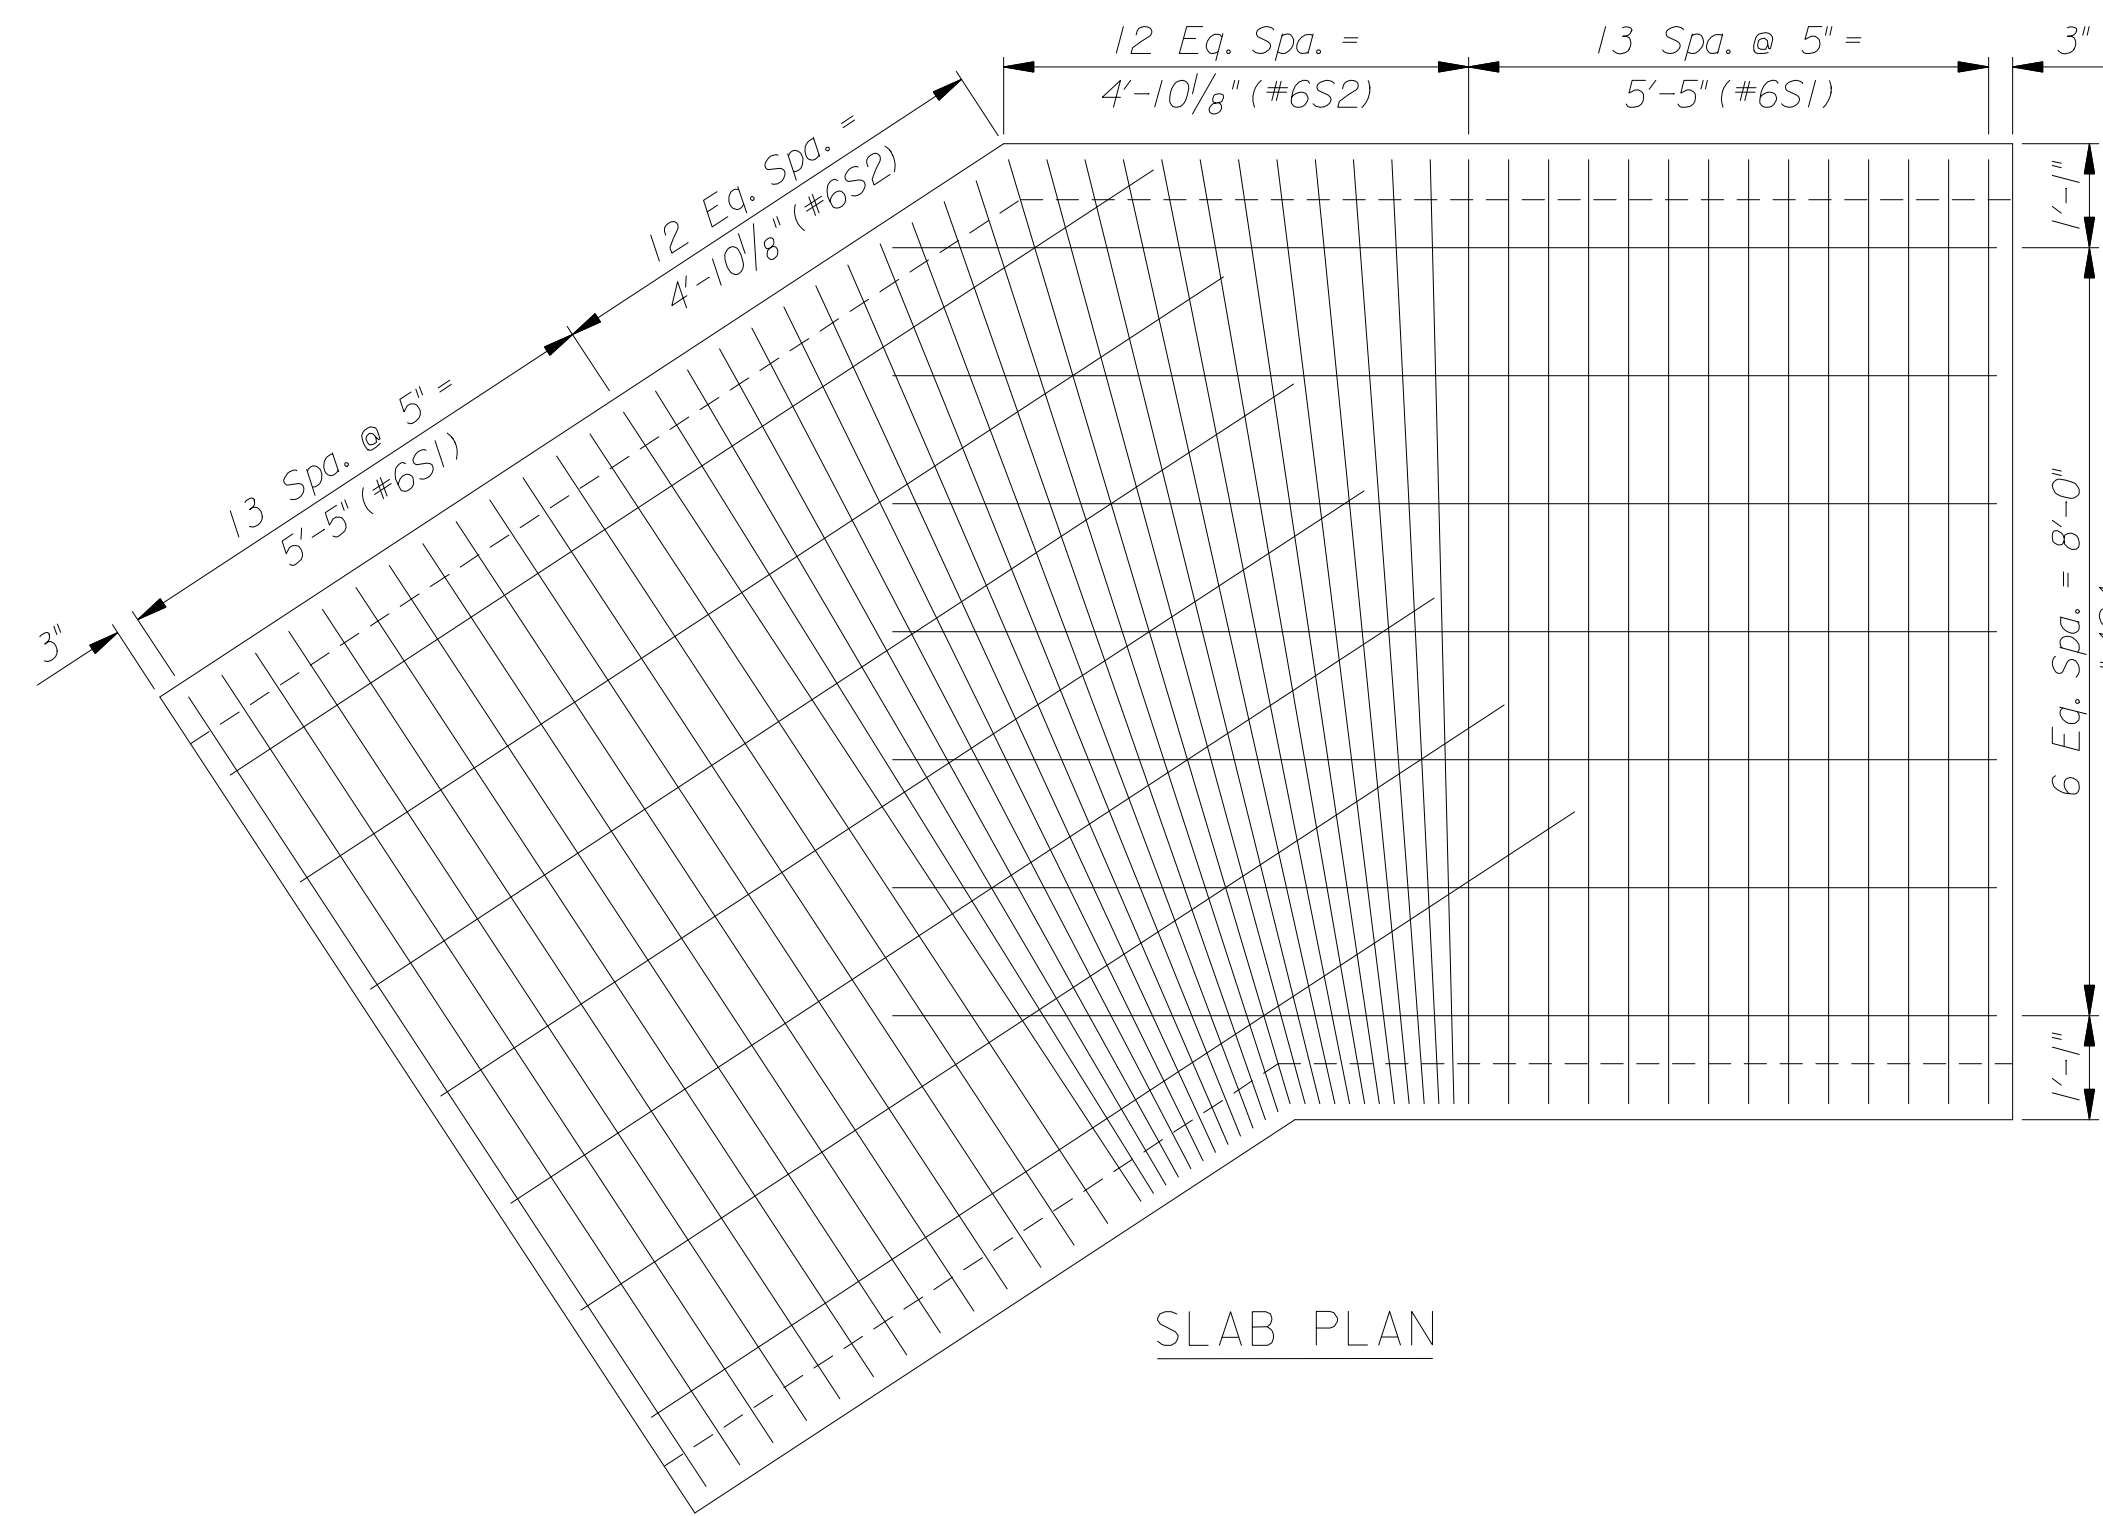


SLAB PLAN

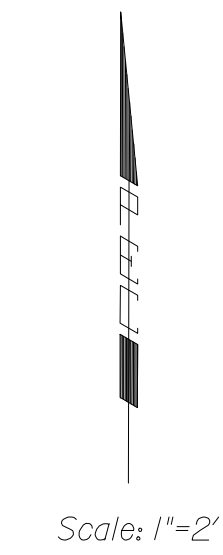


REINFORCING STEEL							
Straight Bars				Bent Bars			
Mark	No.	Size	Length	Mark	No.	Size	Length
F1	28	#6	9'-10"	W2	6	#4	2'-8"
F2	23	#6	Varies				
F4	16	#4	10'-8"				
S1	28	#6	9'-10"				
S2	23	#6	Varies				
S4	14	#4	11'-6"				
W1	60	#4	6'-4"				
W3	6	#4	7'-7"				
W4	6	#4	10'-5"				

BILL OF MATERIALS			
Item	Quantity	Unit	
Concrete	14.9	C.Y.	
Reinforcing Steel (Grade 60)	2079	Lbs.	

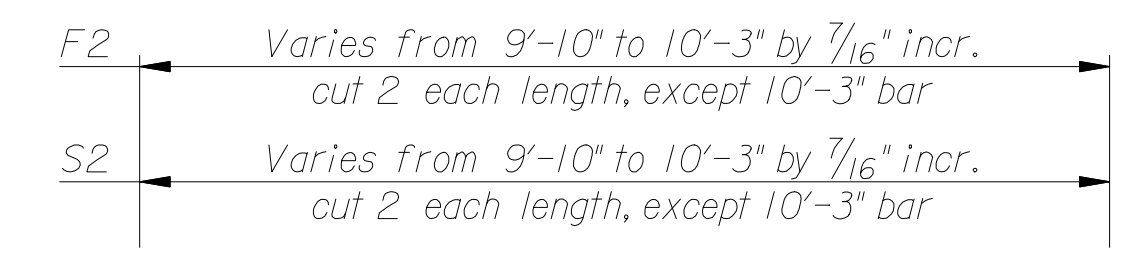


F2, S2

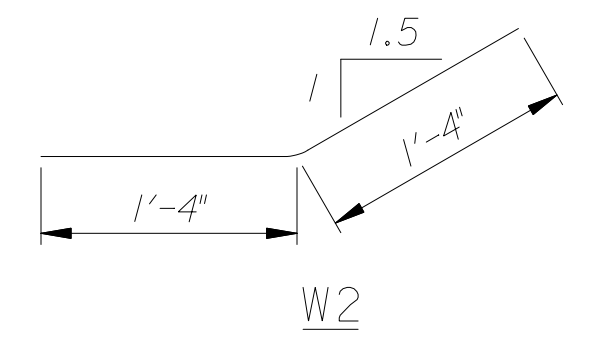


W2

BENDING DIAGRAMS
Dimensions are out to out of bars

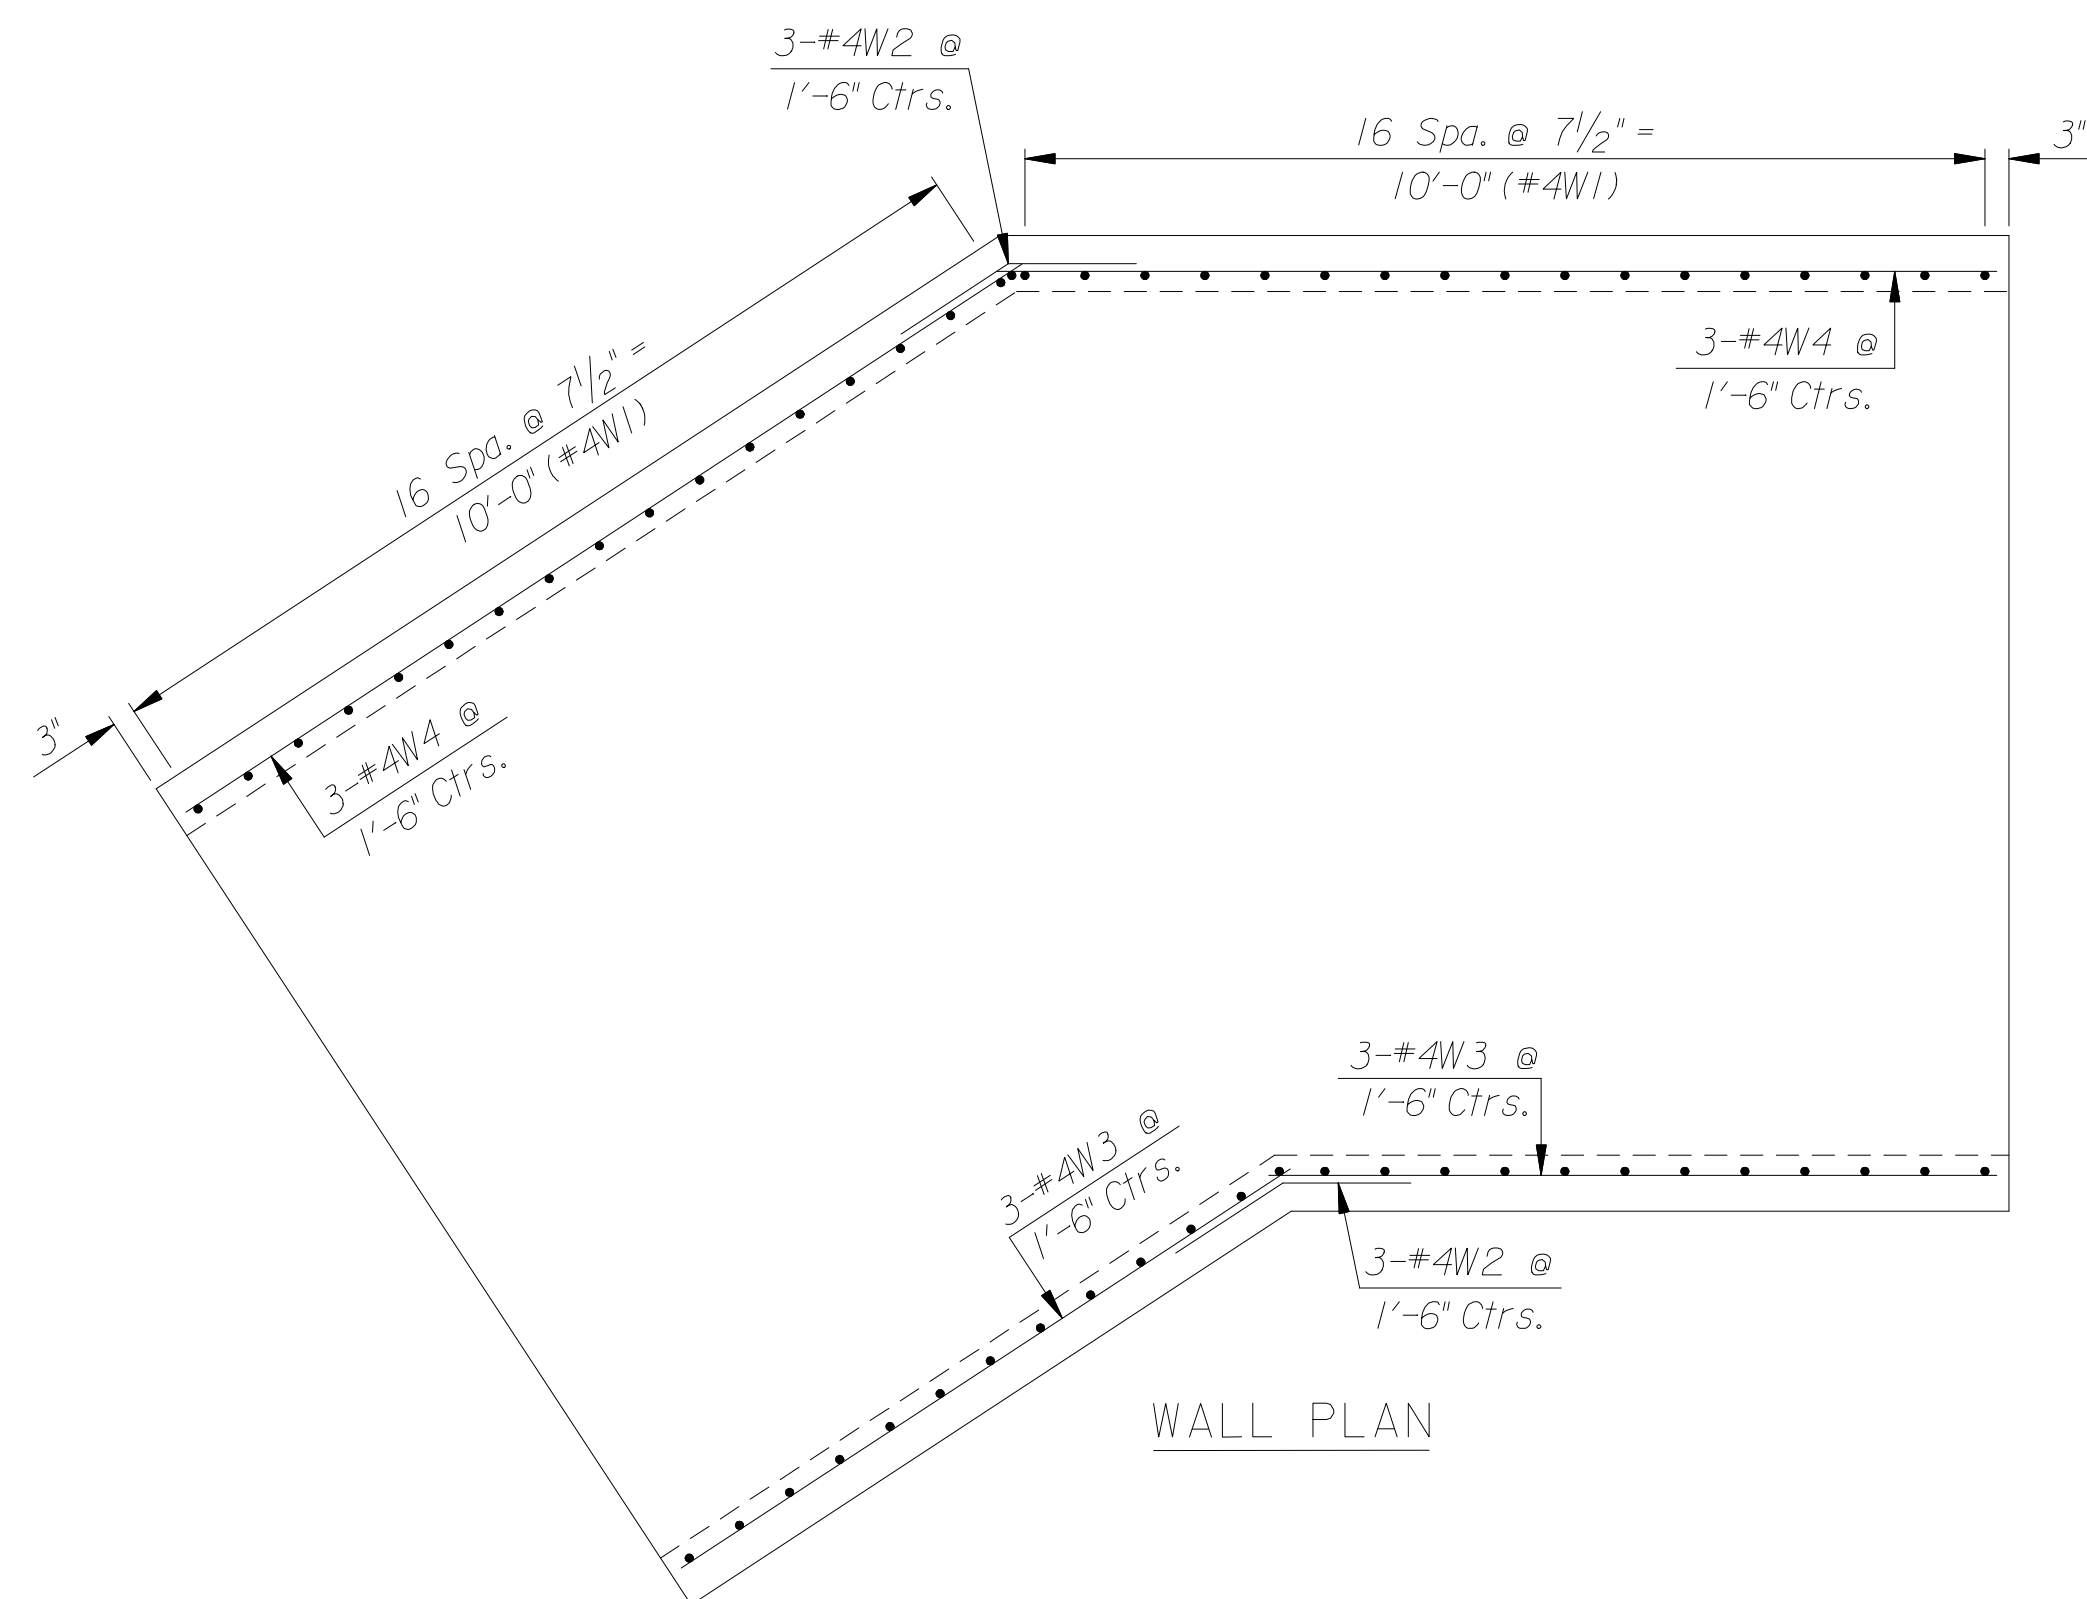

WALL PLAN

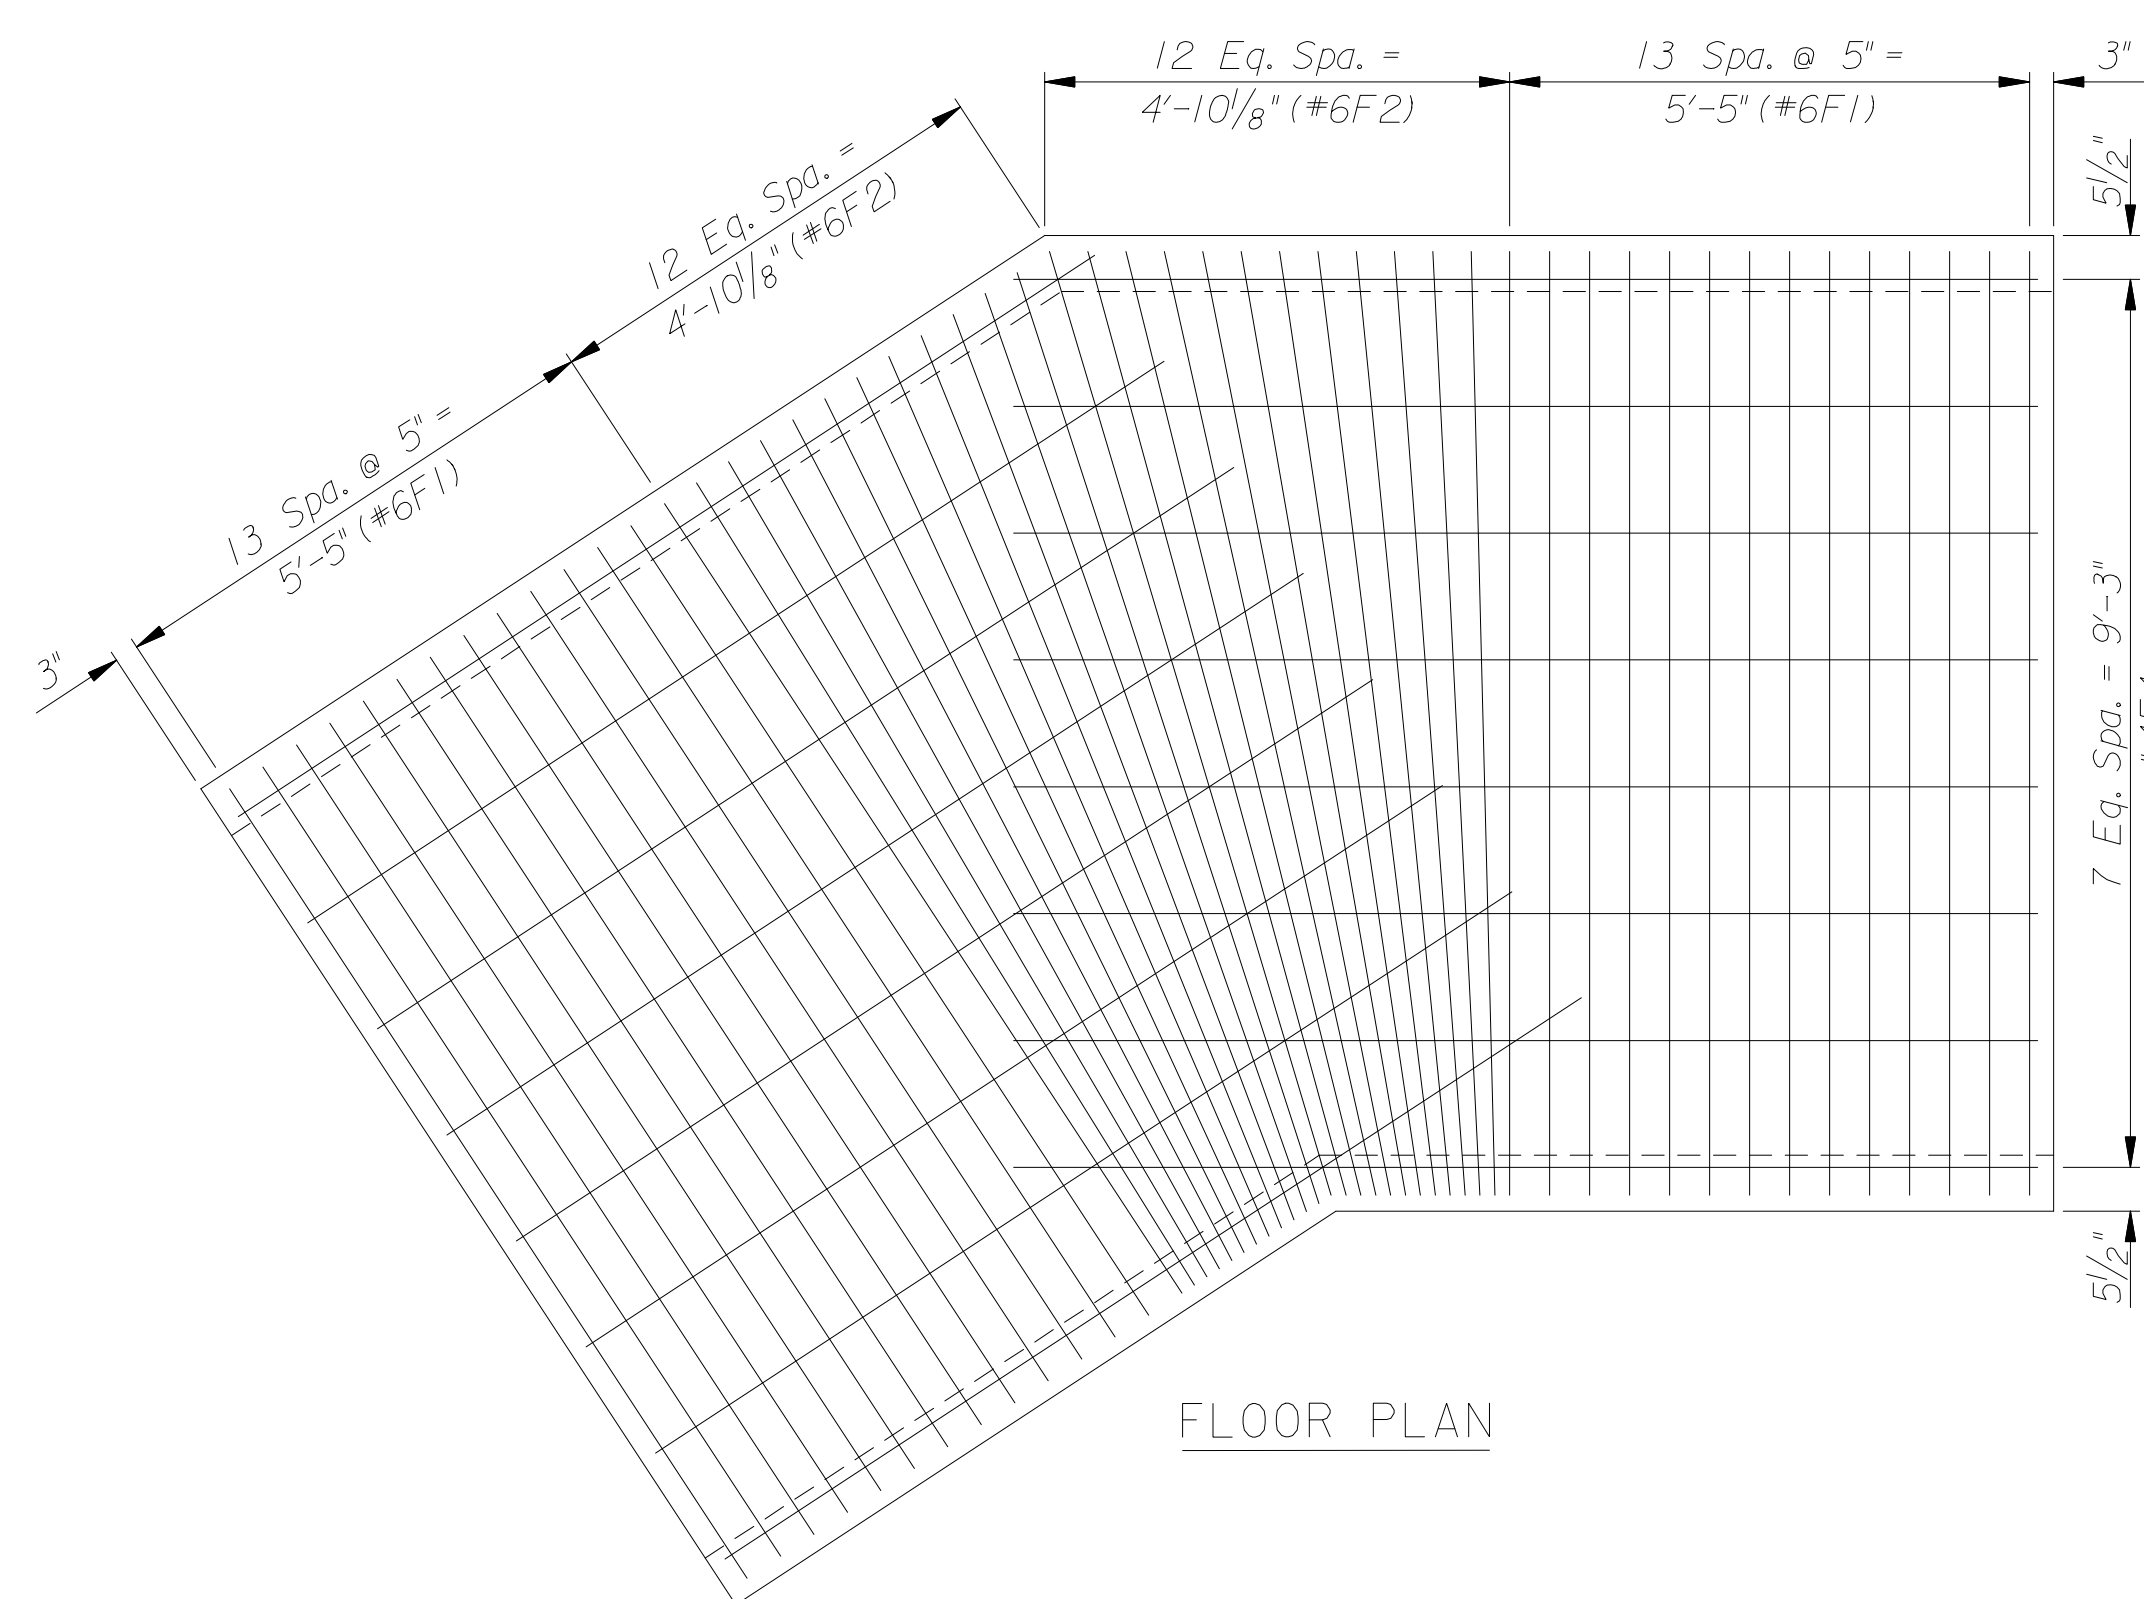

FLOOR PLAN

Sheet 4 of 10 - 2006 11:05:55 PM by msn
 Plot Scale: 1" = 2' 5-25-2006
 P:\2005\05493-2\05493-002-PlanSection-5.dgn

No.	Revision	By	Date
DOWNTOWN ARENA SWD OUTFALL PHASE 1 - WATERWALK PORTION			
P.I. SECTION #5			
JAMES L. ARMOUR, P.E. - CITY ENGINEER CITY OF WICHITA PROJECT NO. 468-84167 Professional Engineering Consultants, P.A. 303 S. TOPEKA • WICHITA, KANSAS 67202 316-262-2691 • FAX 316-262-3003			
Designed by	MSN	Job No.	32-05493-2-42
Drawn by	RAS	Date	April 2006
			Sht. 19 of 47

