


STATE	PROJECT NO.	YEAR	SHEET NO.	TOTAL SHEETS
KANSAS	472-84071	2005	B2.2	

NOTES:
 Top of Rail to Top of Girder Assumptions:
 Rail + Tie to Top of Girder Thickness, 8.125"
 Tie Thickness, 7.000"
 Ballast Below Tie Thickness, 8.000"
 Waterproofing Thickness, 1.060"
 Deck Thickness, 10.000"


INDEX OF BRIDGE DRAWINGS

SHEET NO.	DRAWING TITLE
B2.1	GENERAL PLAN AND ELEVATION
B2.2	TYPICAL SECTION
B2.3	SUMMARY OF QUANTITIES AND GENERAL NOTES
B2.4	FOUNDATION LAYOUT
B2.5	ANCHOR BOLT LAYOUT
B2.6	ABUTMENT NO. 1 PLAN
B2.7	ABUTMENT NO. 1 ELEVATION & DETAILS
B2.8	ABUTMENT NO. 1 FOOTING & DETAILS
B2.9	ABUTMENT NO. 2 PLAN
B2.10	ABUTMENT NO. 2 ELEVATION & DETAILS
B2.11	ABUTMENT NO. 2 FOOTING & DETAILS
B2.12	ABUTMENT NO. 1 WINGWALL ELEVATIONS & DETAILS
B2.13	ABUTMENT NO. 2 WINGWALL ELEVATIONS & DETAILS
B2.14	ABUTMENT DETAILS
B2.15	TYPICAL FRAMING PLAN AND GIRDER ELEVATION
B2.16	TYPICAL SUPERSTRUCTURE DETAILS
B2.17	EXPANSION BEARING DEVICE DETAILS
B2.18	FIXED BEARING DEVICE DETAILS
B2.19	DECK PLAN
B2.20	DECK SECTION & DETAILS
B2.21	BRIDGE-HANDBRAIL-TYPE-11-HA-
B2.22	BRIDGE HANDBRAIL TYPE 2, 2A)
B2.23	WATERPROOFING & DRAINAGE DETAILS
B2.24	PLANTER-BRIDGE-DETAILS-I-
B2.25	PLANTER-BRIDGE-DETAILS-II-
B2.26	COLLISION BEAM DETAILS
B2.27	ABUTMENT NO. 1 REINFORCING DETAILS
B2.28	ABUTMENT NO. 2 REINFORCING DETAILS
B2.29	DECK REINFORCING DETAILS

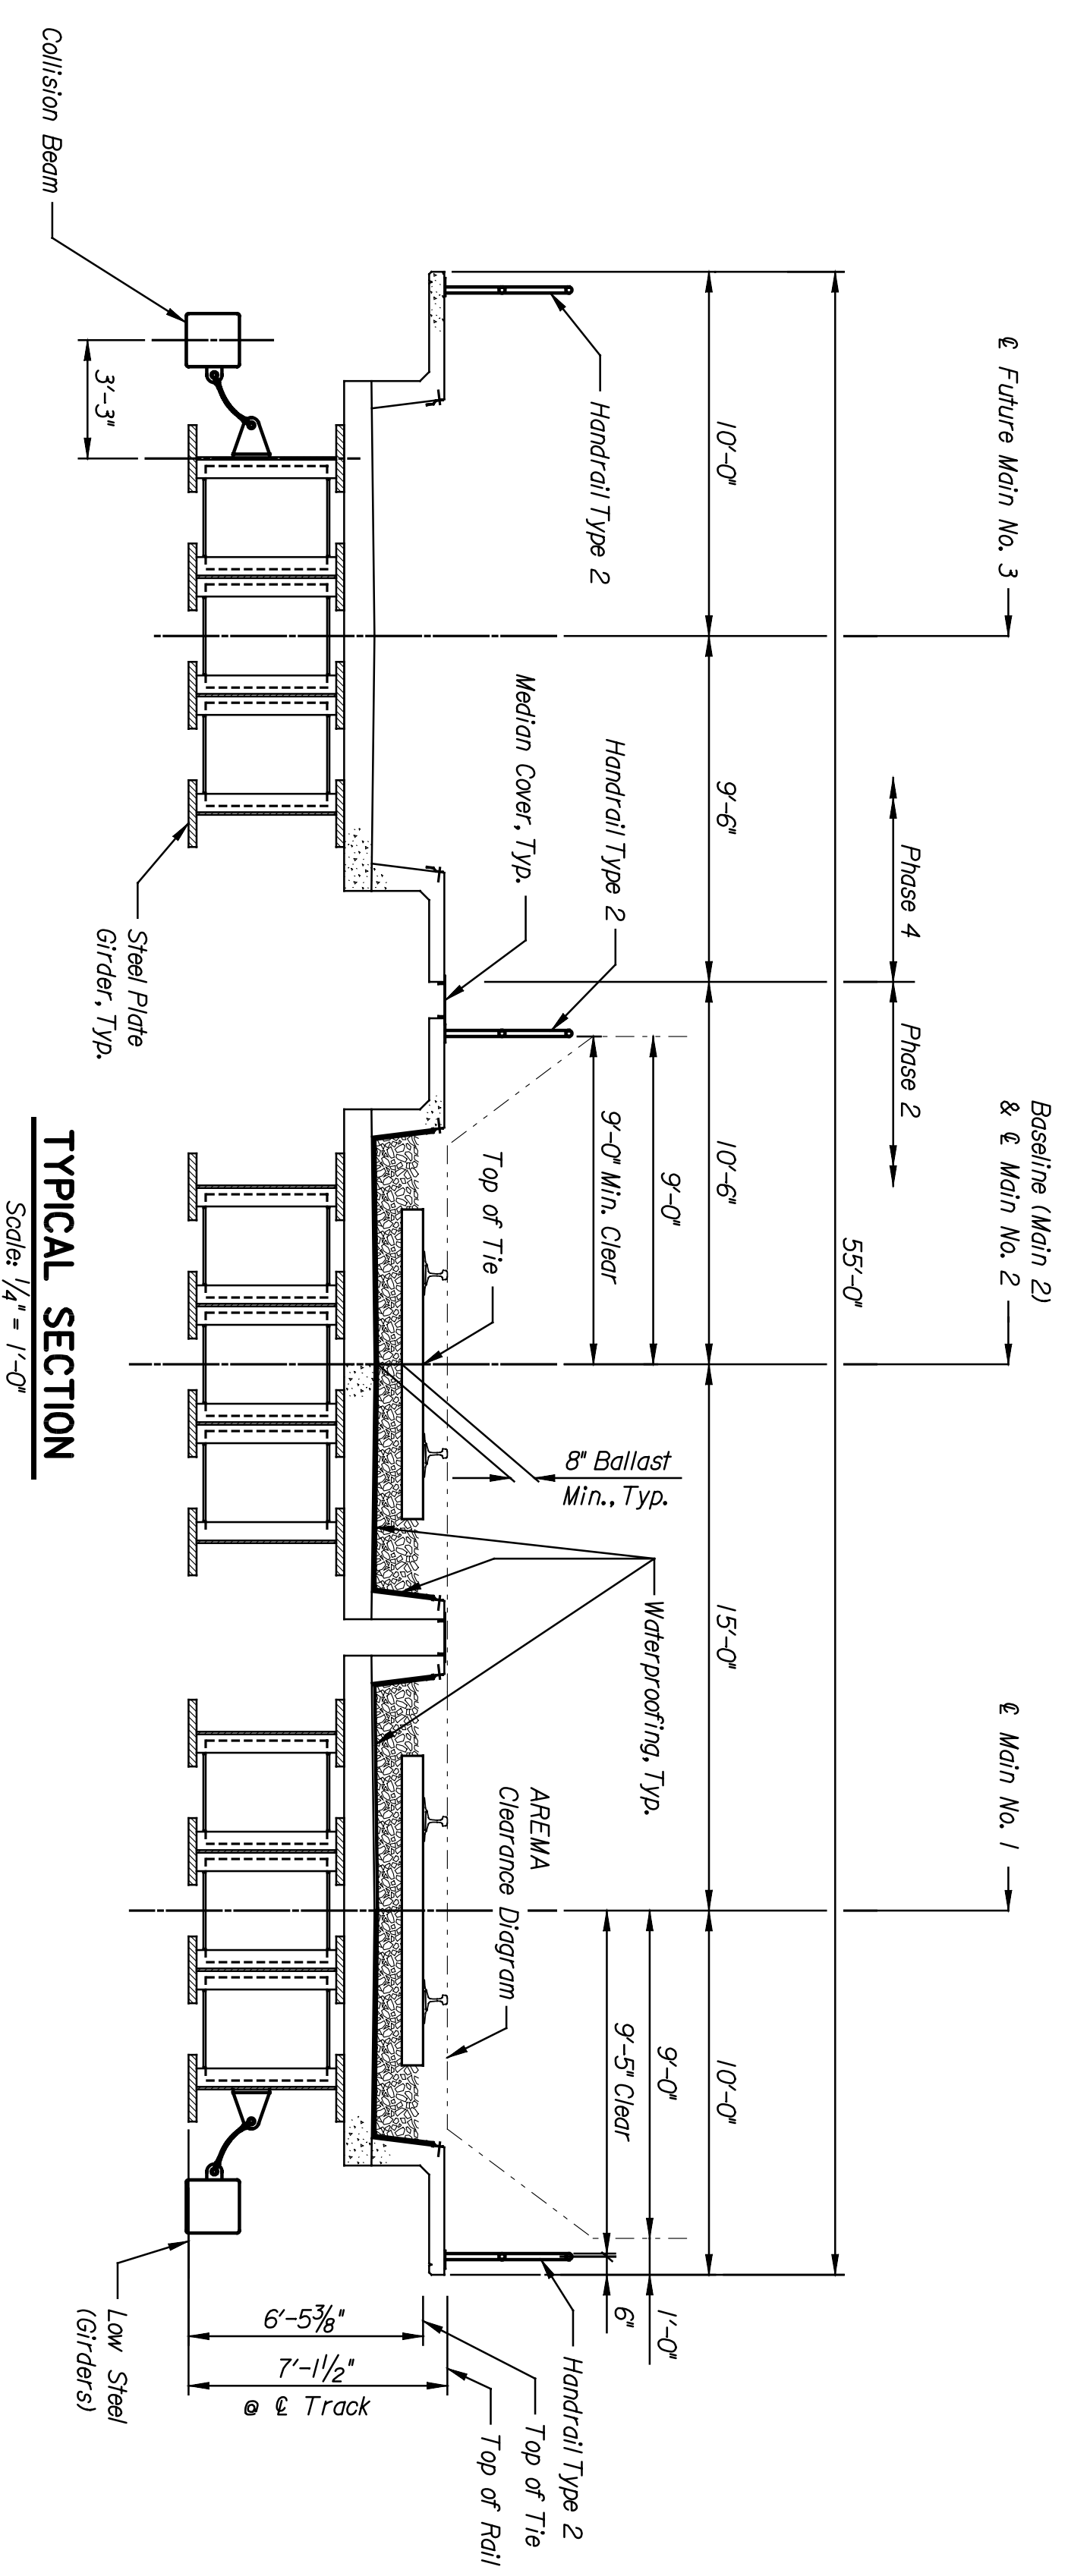

TYPICAL SECTION

Scale: 1/4" = 1'-0"

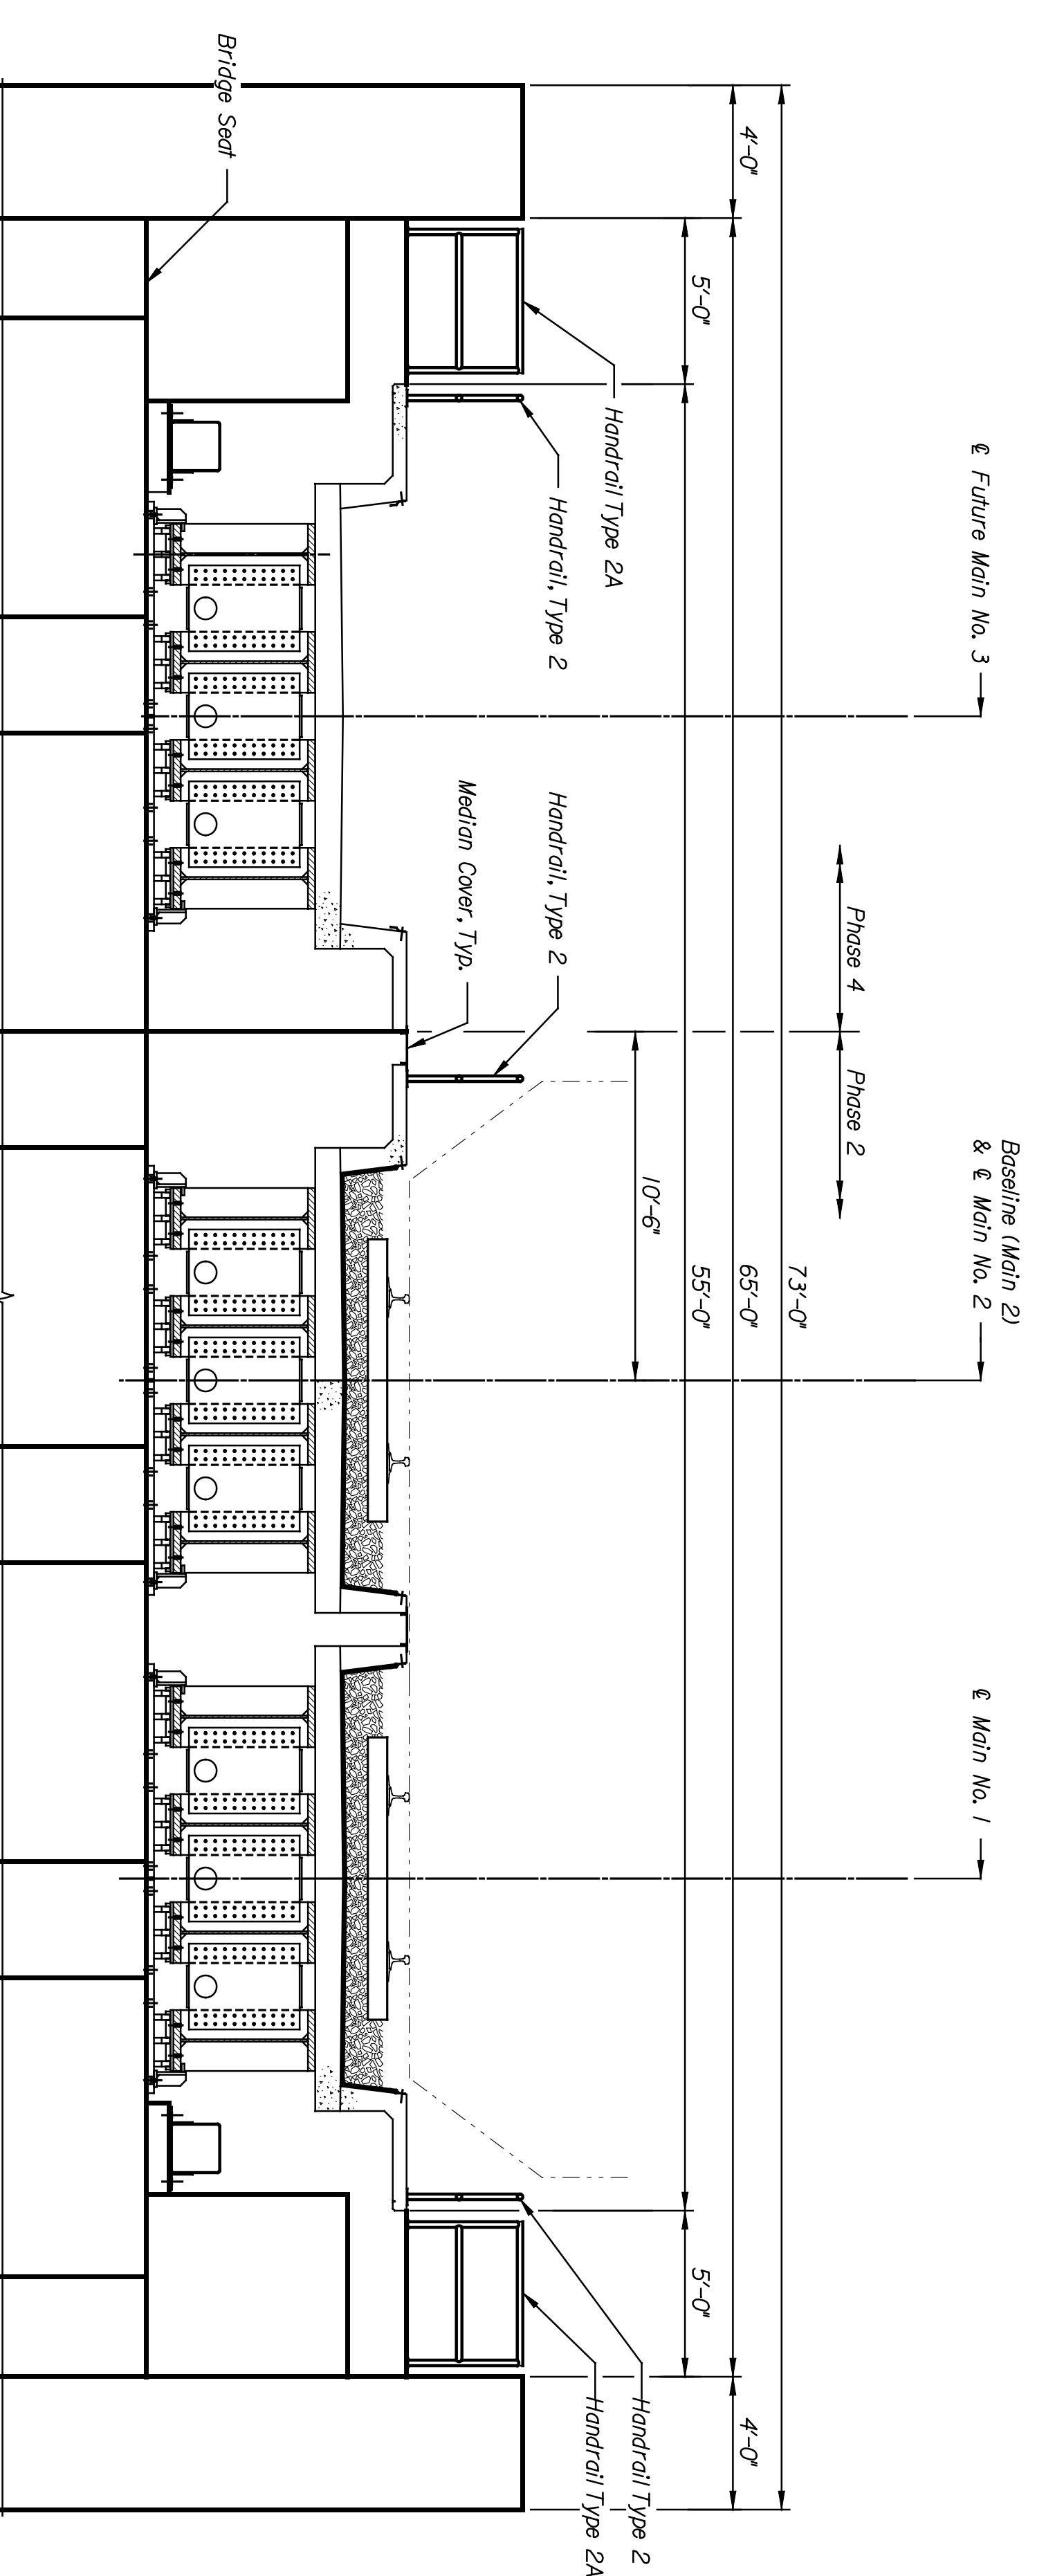

TYPICAL SECTION

Scale: 1/4" = 1'-0"

DATE	BY

This sheet designed by:



ARCHITECTS ENGINEERS PLANNERS

LOCATION: RMSF BR. 201A	WICHITA, KS	LINE SEGMENT 7400		
SHEET NO. 05	SCALE AS NOTED	APP'D.		
DESIGNED: EKD	DETAILS: DAL	QUANTITIES: DJL		
DESIGN GR.: BWH	DETAIL GR.: JWH	QUANT. GR.: DMH		
CITY OF WICHITA WICHITA CENTRAL CORRIDOR 13TH STREET TYPICAL SECTION				
NO.	DATE	REVISIONS	BY	APP'D.
3				
2				
1				