


STATE	PROJECT NO.	YEAR	SHEET NO.	TOTAL SHEETS
KANSAS	472-84071	2005	B6.2	

NOTES:
 Top of Rail to Top of Girder Assumptions:
 Rail + Tie Plate Thickness, 8.125"
 Tie Thickness, 7.000"
 Ballast Below Tie Thickness, 8.000"
 Waterproofing Thickness,* 1.060"
 Deck Thickness,* 10.000"


INDEX OF BRIDGE DRAWINGS

SHEET NO.	DRAWING TITLE
B6.1	GENERAL PLAN AND ELEVATION
B6.2	TYPICAL SECTION
B6.3	SUMMARY OF QUANTITIES AND GENERAL NOTES
B6.4	FOUNDATION LAYOUT
B6.5	ANCHOR BOLT LAYOUT
B6.6	ABUTMENT NO. 1 PLAN
B6.7	ABUTMENT NO. 1 ELEVATION & DETAILS
B6.8	ABUTMENT NO. 1 FOOTING & DETAILS
B6.9	ABUTMENT NO. 2 PLAN
B6.10	ABUTMENT NO. 2 ELEVATION & DETAILS
B6.11	ABUTMENT NO. 2 FOOTING & DETAILS
B6.12	WINGWALL ELEVATION & DETAILS
B6.13	ABUTMENT DETAILS
B6.14	TYPICAL FRAMING PLAN AND GIRDER ELEVATION
B6.15	TYPICAL SUPERSTRUCTURE DETAILS
B6.16	EXPANSION BEARING DEVICE DETAILS
B6.17	FIXED BEARING DEVICE DETAILS
B6.18	DECK PLAN
B6.19	DECK SECTION & DETAILS
B6.20	BRIDGE HANDBRAKE (TYPE 1)-1A1-
B6.21	BRIDGE HANDRAIL (TYPE 2, 2A)
B6.22	WATERPROOFING & DRAINAGE DETAILS
B6.23	PLANTER-BRIDGE-DETAILS-1-
B6.24	PLANTER-BRIDGE-DETAILS-1-
B.25	COLLISION BEAM DETAILS
B6.26	ABUTMENT NO. 1 REINFORCING DETAILS
B6.27	ABUTMENT NO. 2 REINFORCING DETAILS
B6.28	DECK REINFORCING DETAILS
B6.29	EXISTING 1ST STREET BRIDGE REMOVAL LIMITS

BY	DATE

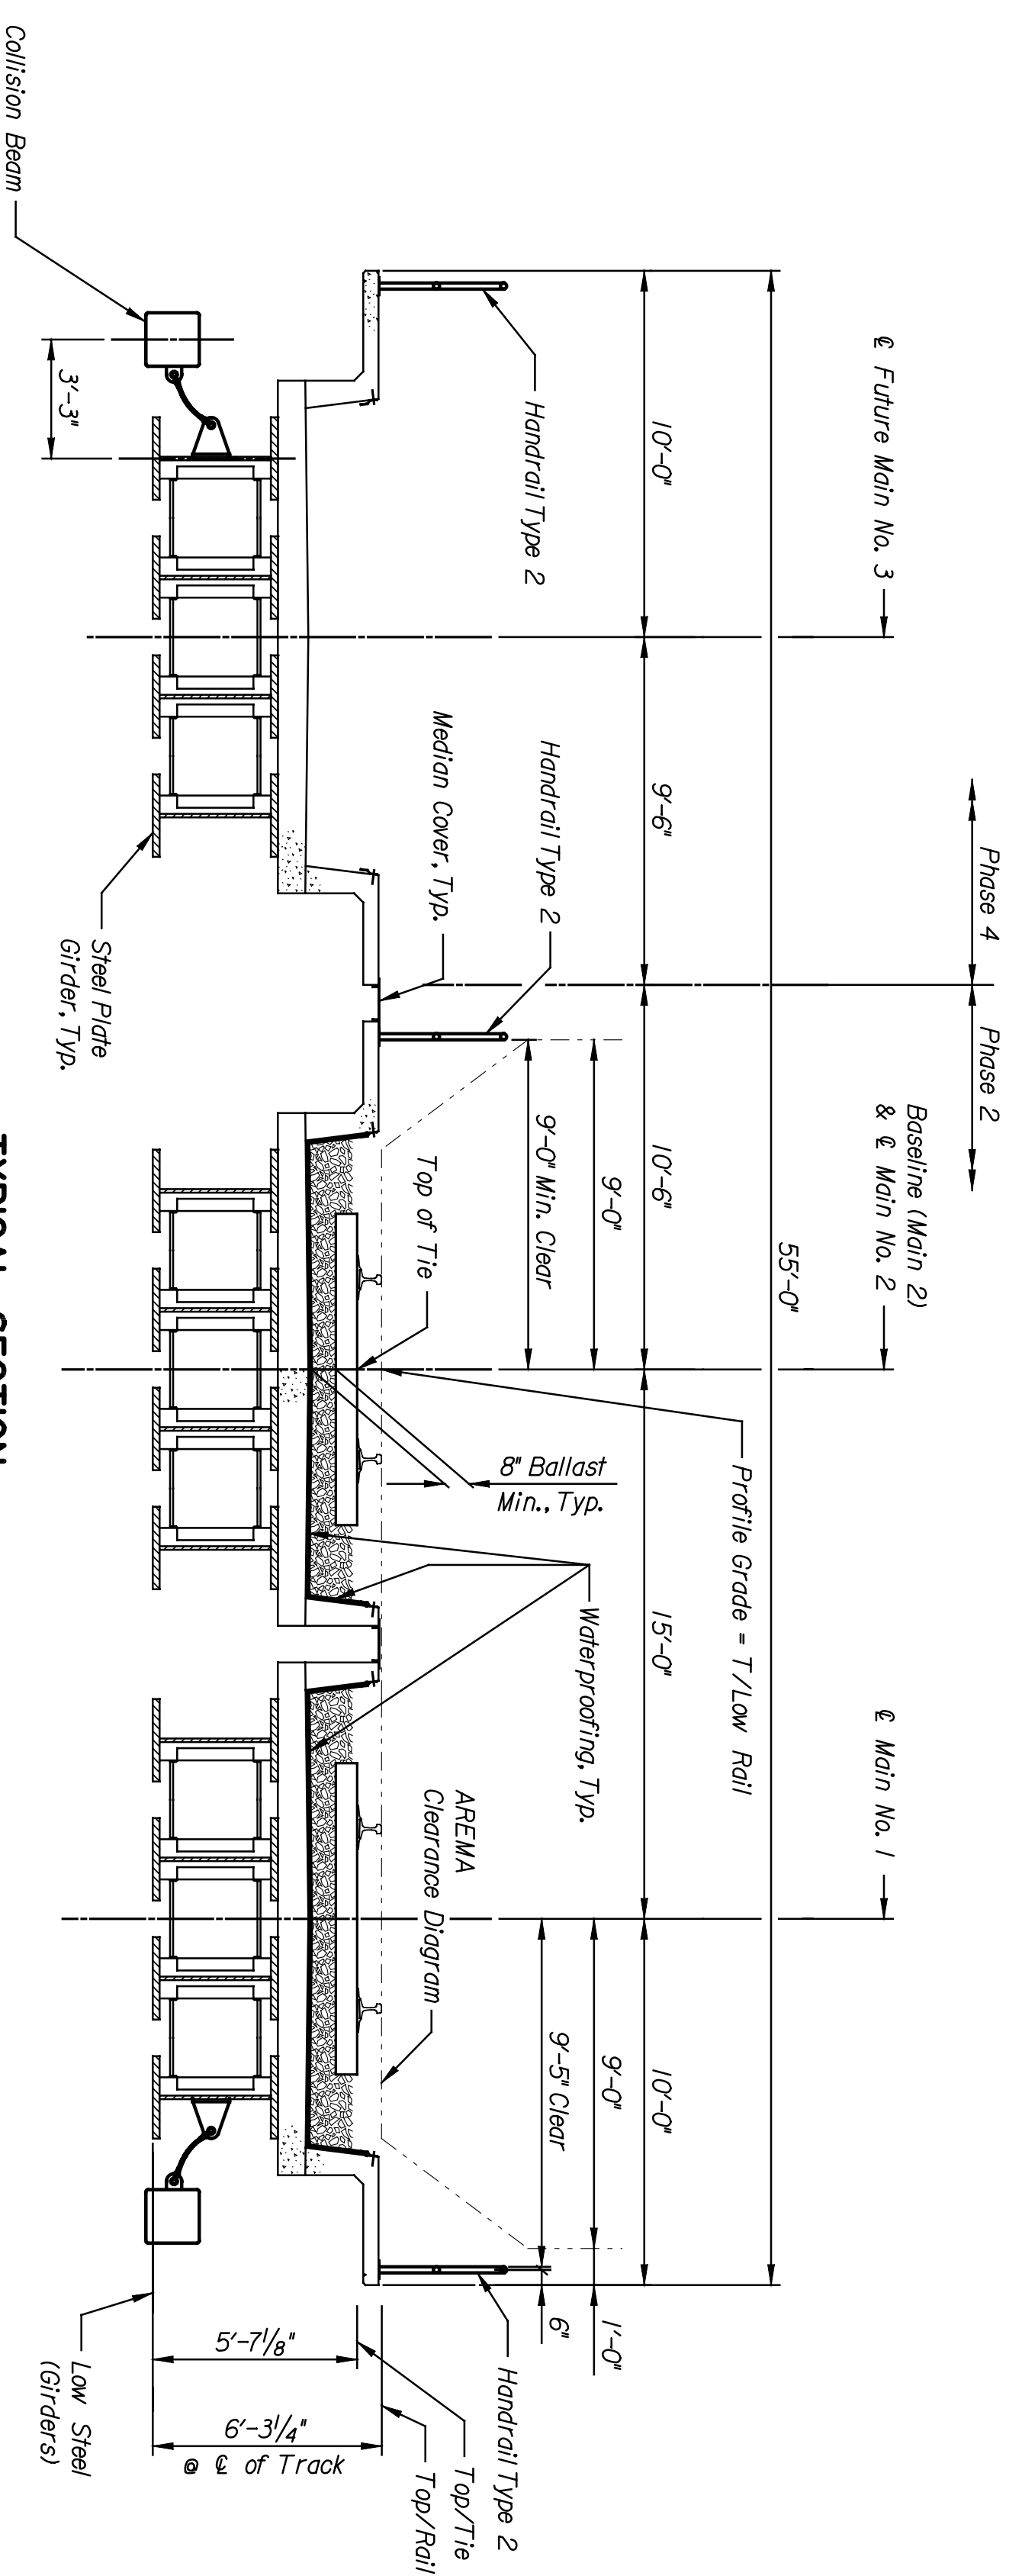

TYPICAL SECTION
 Scale: 1/4" = 1'-0"

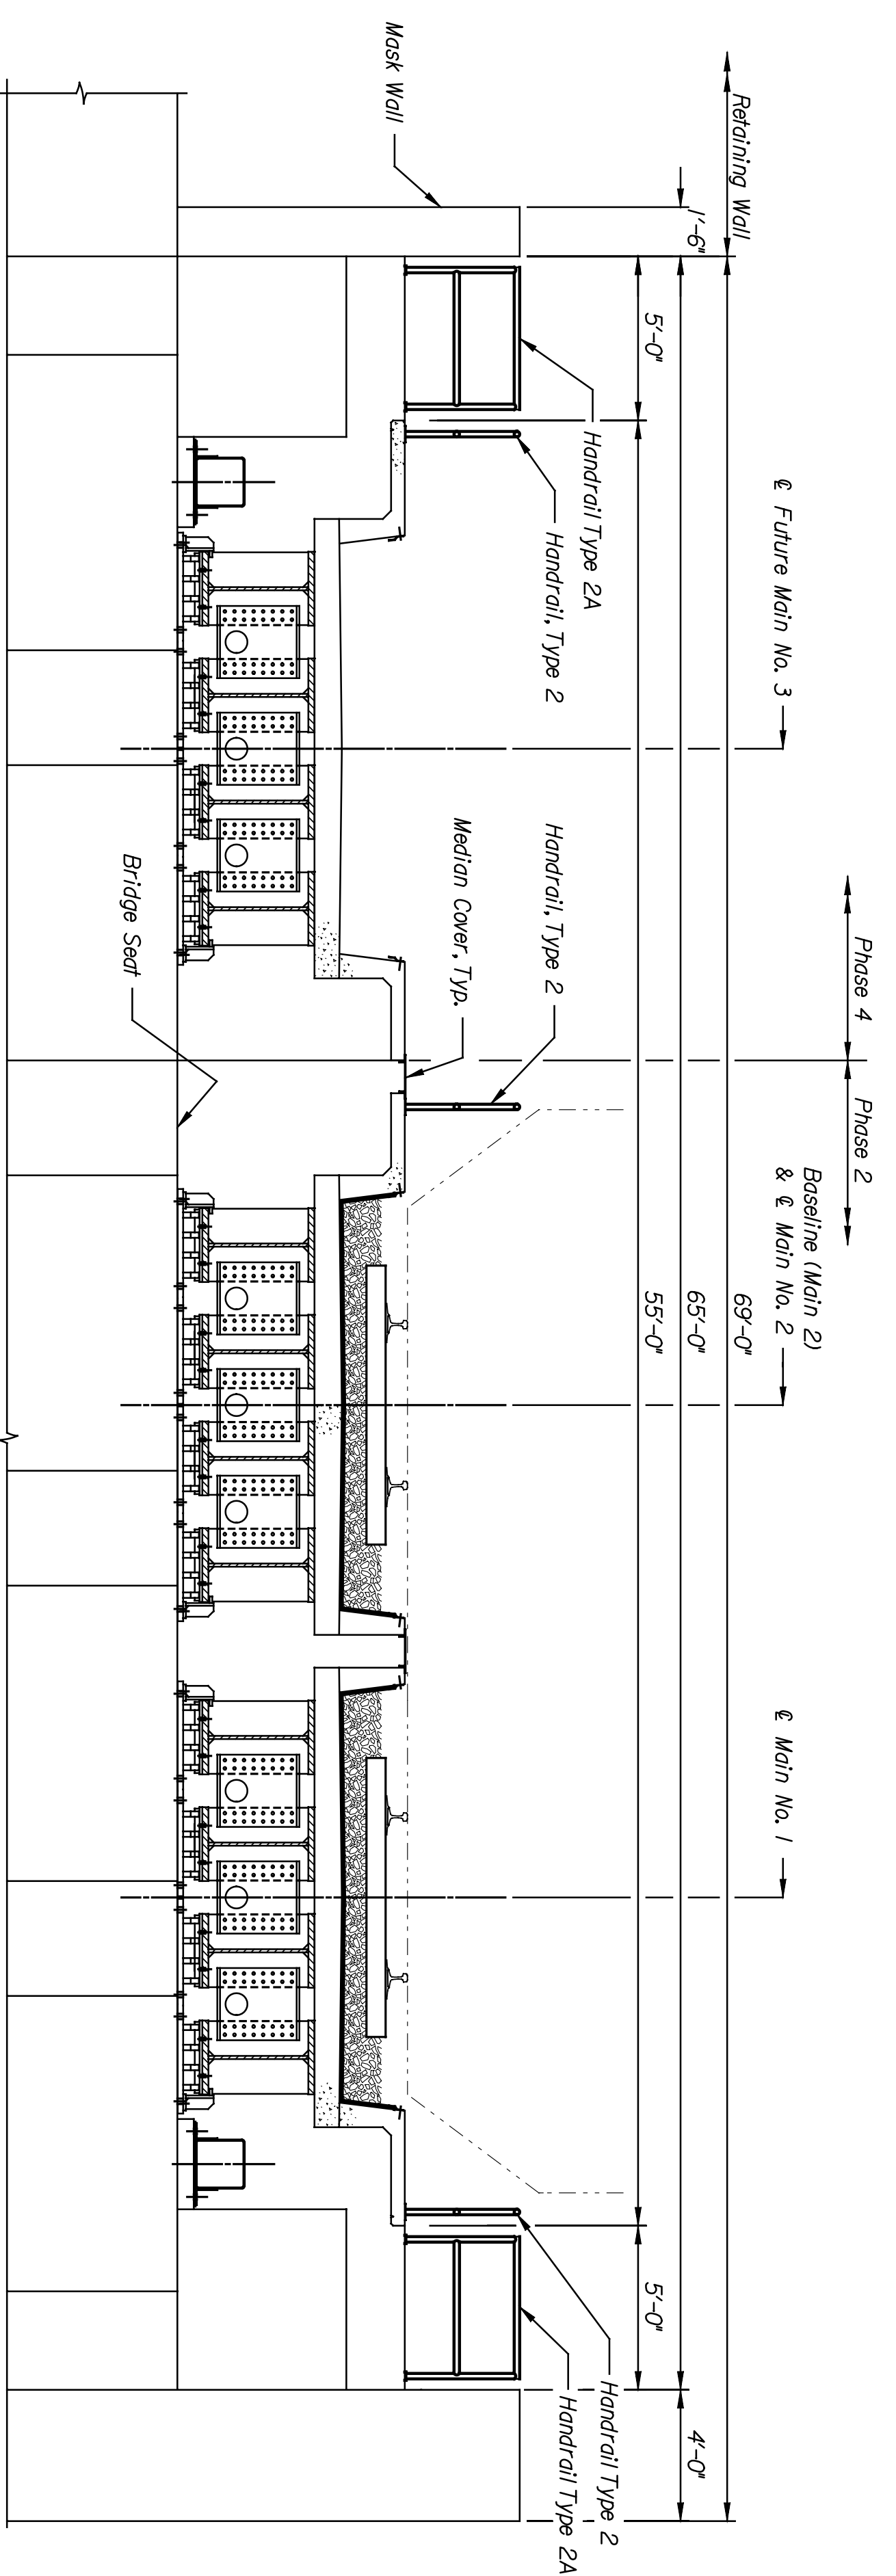

TYPICAL SECTION
 Scale: 1/4" = 1'-0"
 Looking South of Abutment

This sheet designed by:



ARCHITECTS ENGINEERS PLANNERS

LOCATION: RMSF BR. 20.2	LINE SEGMENT: 7400	WICHITA, KS
SHEET NO. 06	SCALE AS NOTED	APP'D.
DESIGNED BY: BWH	DETAILED BY: JWH	QUANTITIES BY: DMH
DESIGN CK: BWH	CHECKED BY: JWH	TRACED BY: DMH
NO.	DATE	REVISIONS
1		
2		
3		
CITY OF WICHITA WICHITA CENTRAL CORRIDOR 1ST STREET TYPICAL SECTION		