


	BY	DATE

Plotted on: Tuesday, January 04, 2005 09:00
 dlutz Plot Queue: \\cbsw100\KC029049-PS
 Plot Scale: 8,000000\h.000000 Pen Table: J:\29049\Library\Plotpen\1fg-fullsize.pen
 Design Filename: \\kcow30\elec\29049\DWG\cads Plan C Base\13th street lighting0.dgn

This sheet designed by:
HNTEB
 ARCHITECTS ENGINEERS PLANNERS

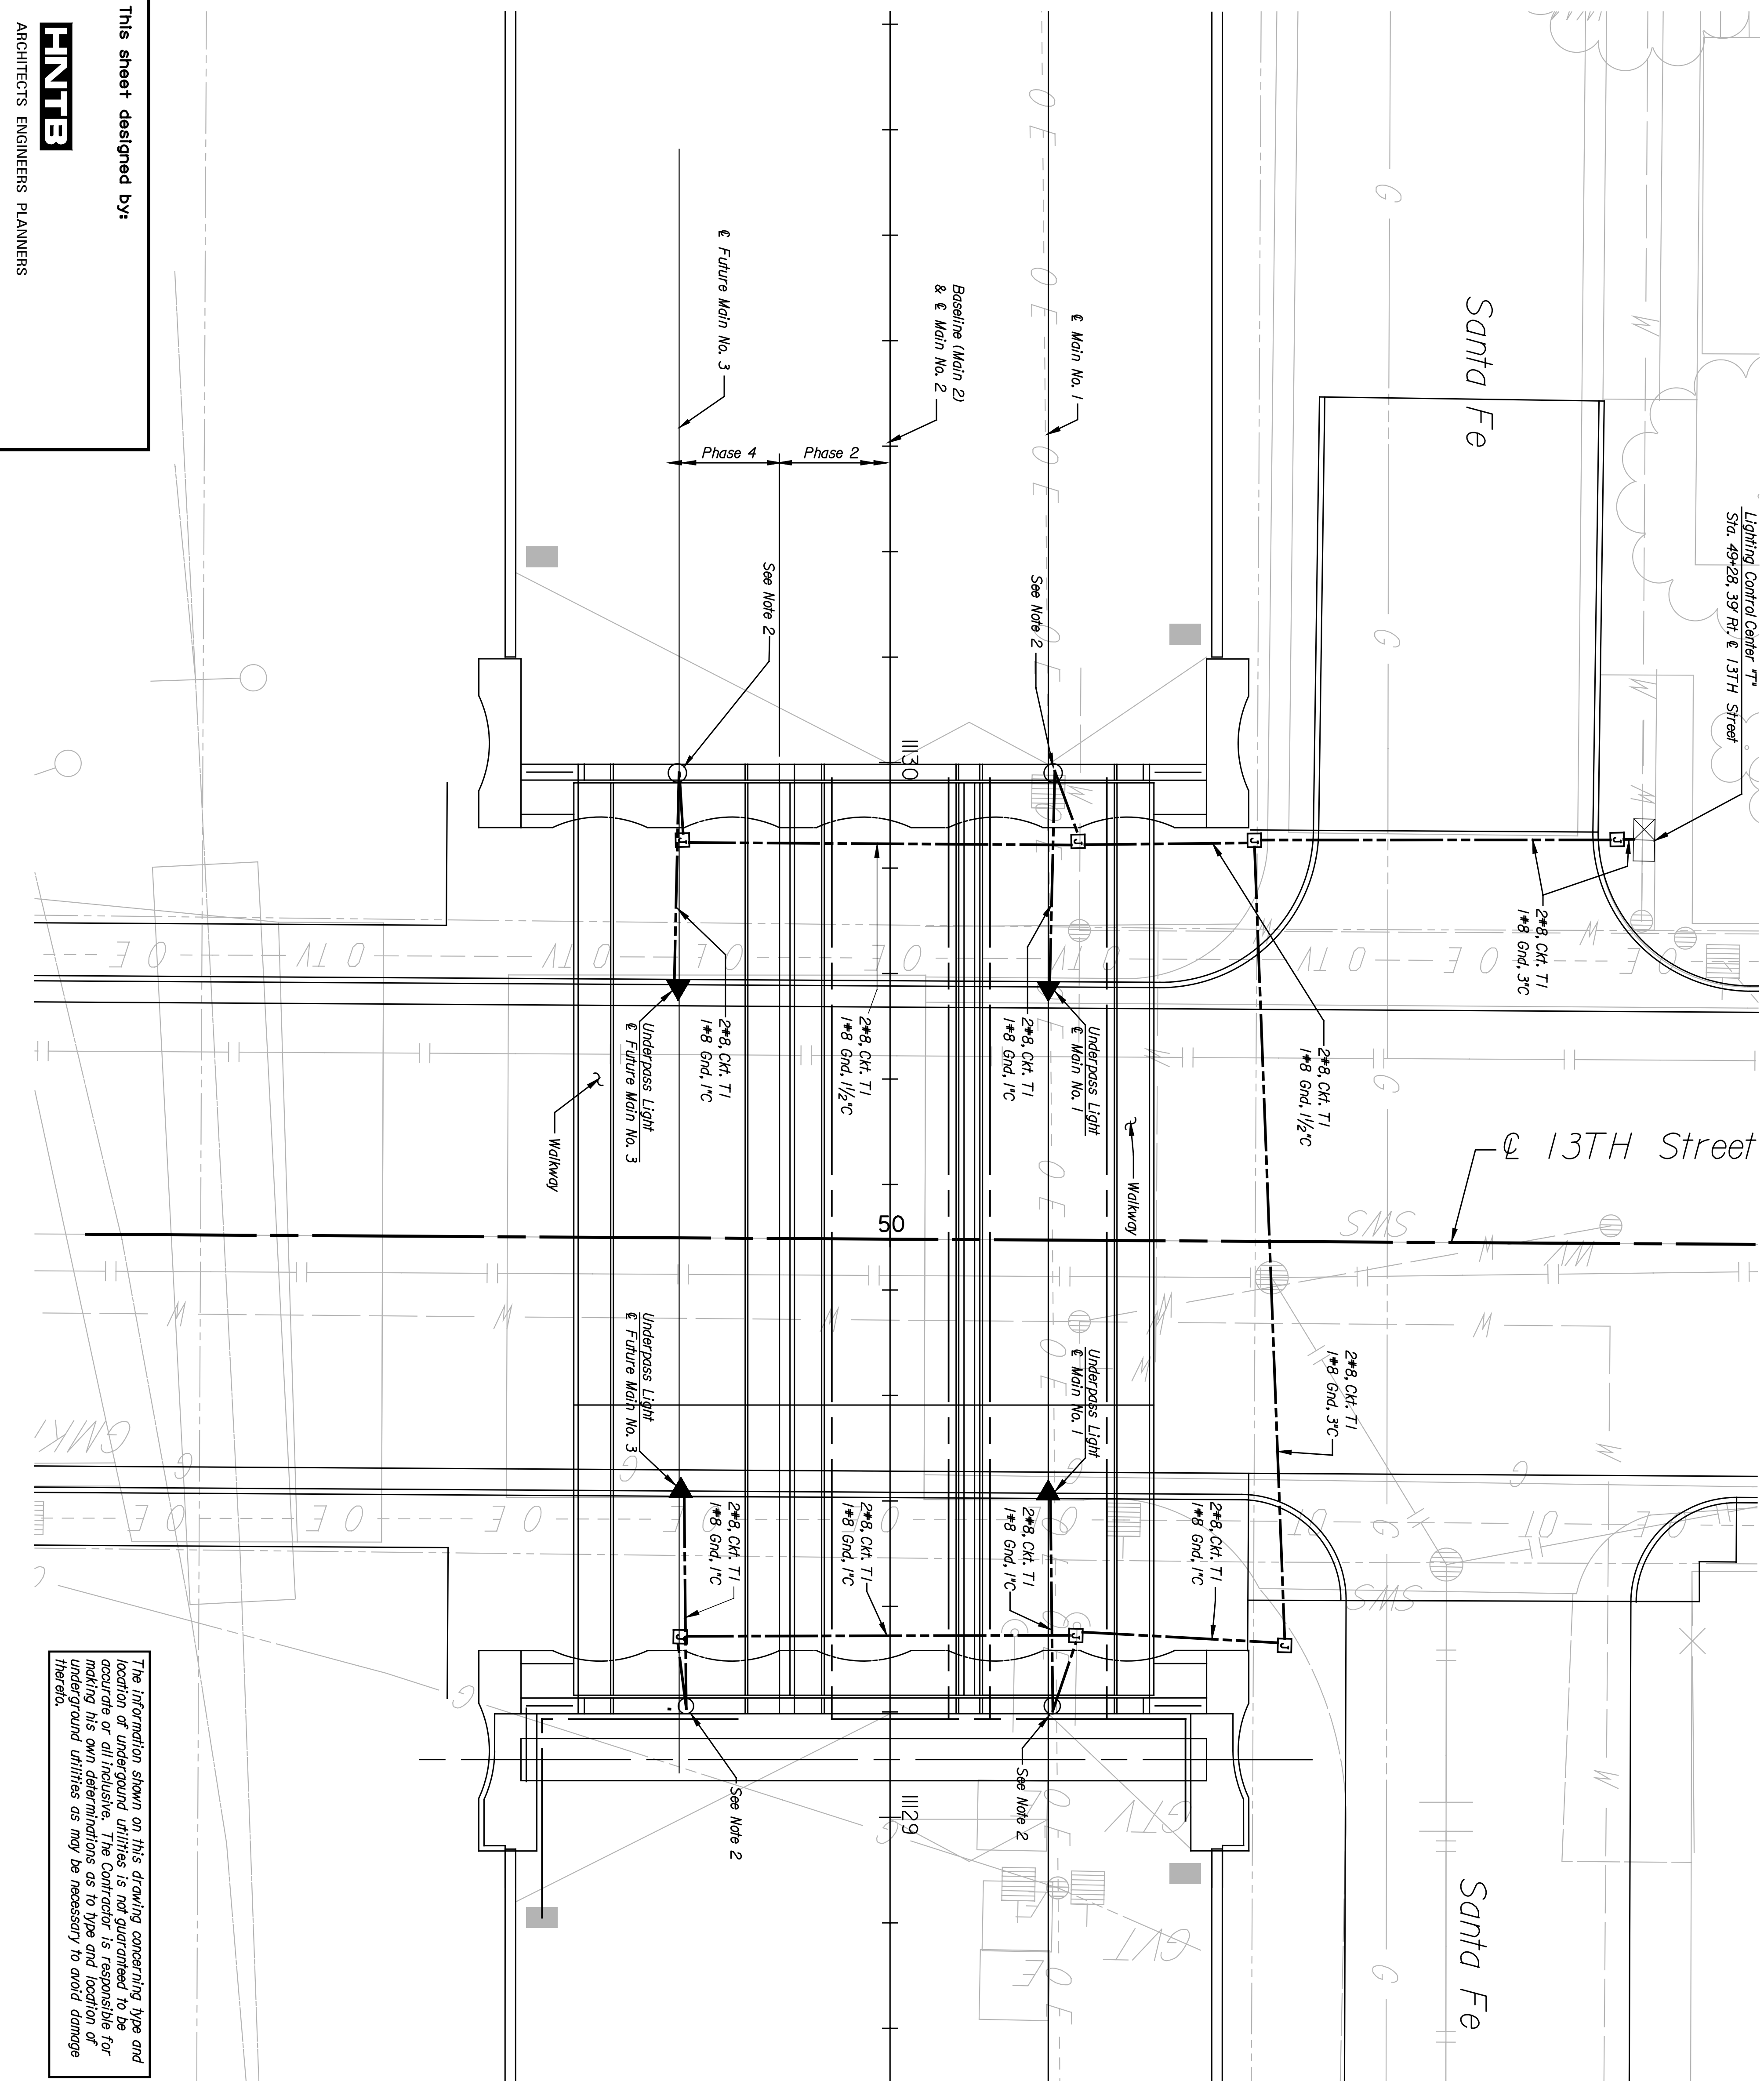


STATE	PROJECT NO.	YEAR	SHEET NO.	TOTAL SHEETS
KANSAS	472-94071	2005	14.01	

- LIGHTING LEGEND**
- ☒ Pad Mounted Lighting Control Center Enclosure
 - ▲ Wall or Horizontal Mounted Underpass Luminaire
 - Ground Mounted Junction Box, 11" x 18" x 12"
 - Conductor in Rigid Metal Conduit. Size and Quantity as Per Plans.

- PLAN NOTES**
- The contractor shall coordinate the installation of all conduit with road and bridge construction and other improvements.
 - See structural drawings B2.7 and B2.10 for conduit routed in abutment wall. Install liquid tight flexible metal conduit from abutment wall to conduit mounted to the bridge deck. Install pull box to bridge deck as necessary to pull circuit. See detail on sheet L4.10.

CIRCUIT SCHEDULE
 CONTROL CENTER 7" MAIN BKR 125A
 120/240 VOLT

CIRCUIT NO.	CIRCUIT VOLTAGE	CONNECTED LOAD	BREAKER SIZE	CONDUCTOR SIZE	WIRE SIZE	GND SIZE
T1	240	480 W	30A	30A	#8	#8
SPARE			30A	30A		
SPARE			30A	30A		
SPARE			30A	30A		

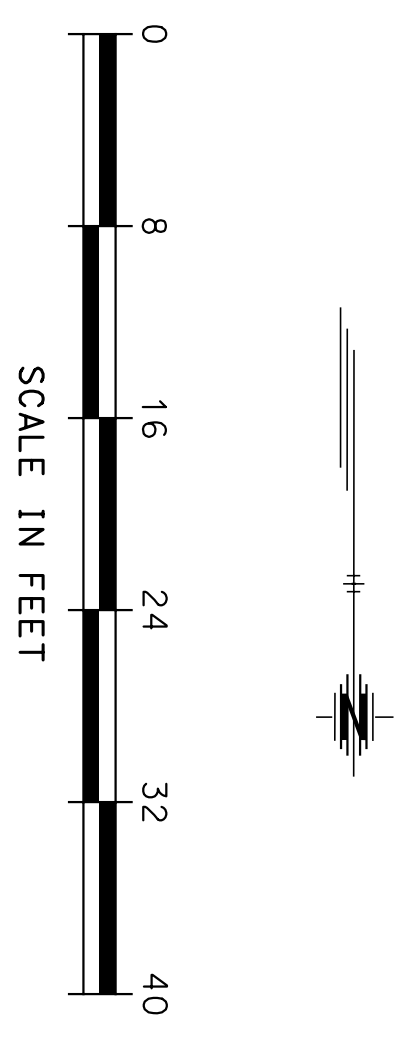

The information shown on this drawing concerning type and location of underground utilities is not guaranteed to be accurate or all inclusive. The Contractor is responsible for making his own determinations as to type and location of underground utilities as may be necessary to avoid damage thereto.

CITY OF WICHITA
WICHITA CENTRAL CORRIDOR
13TH STREET
LIGHTING PLAN

SHEET NO.	OF	SCALE	V.A.	1"=1'-0"	APP'D.	TRACED
DESIGNED	UGS	DETAILS	SMS	QUANTITIES		
DESIGN CR.	DBL	DETAIL CR.	DBL	QUANT. CR.		

NO.	DATE	REVISIONS	BY	APP'D.
3				
2				
1				