


BY	DATE


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 Plot Scale: \$scale\$ Pen Table: \$pentables\$
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STATE	PROJECT NO.	YEAR	SHEET NO.	TOTAL SHEETS
KANSAS	472-84071	2005	BL2.2	

NOTES:
 Top of Rail to Top of Girder Assumptions:
 Rail + Tie to Top of Girder Thickness, 8.125"
 Tie Thickness, 7.000"
 Ballast Below Tie Thickness, 8.000"
 Waterproofing Thickness, 1.060"
 Deck Thickness, 10.000"

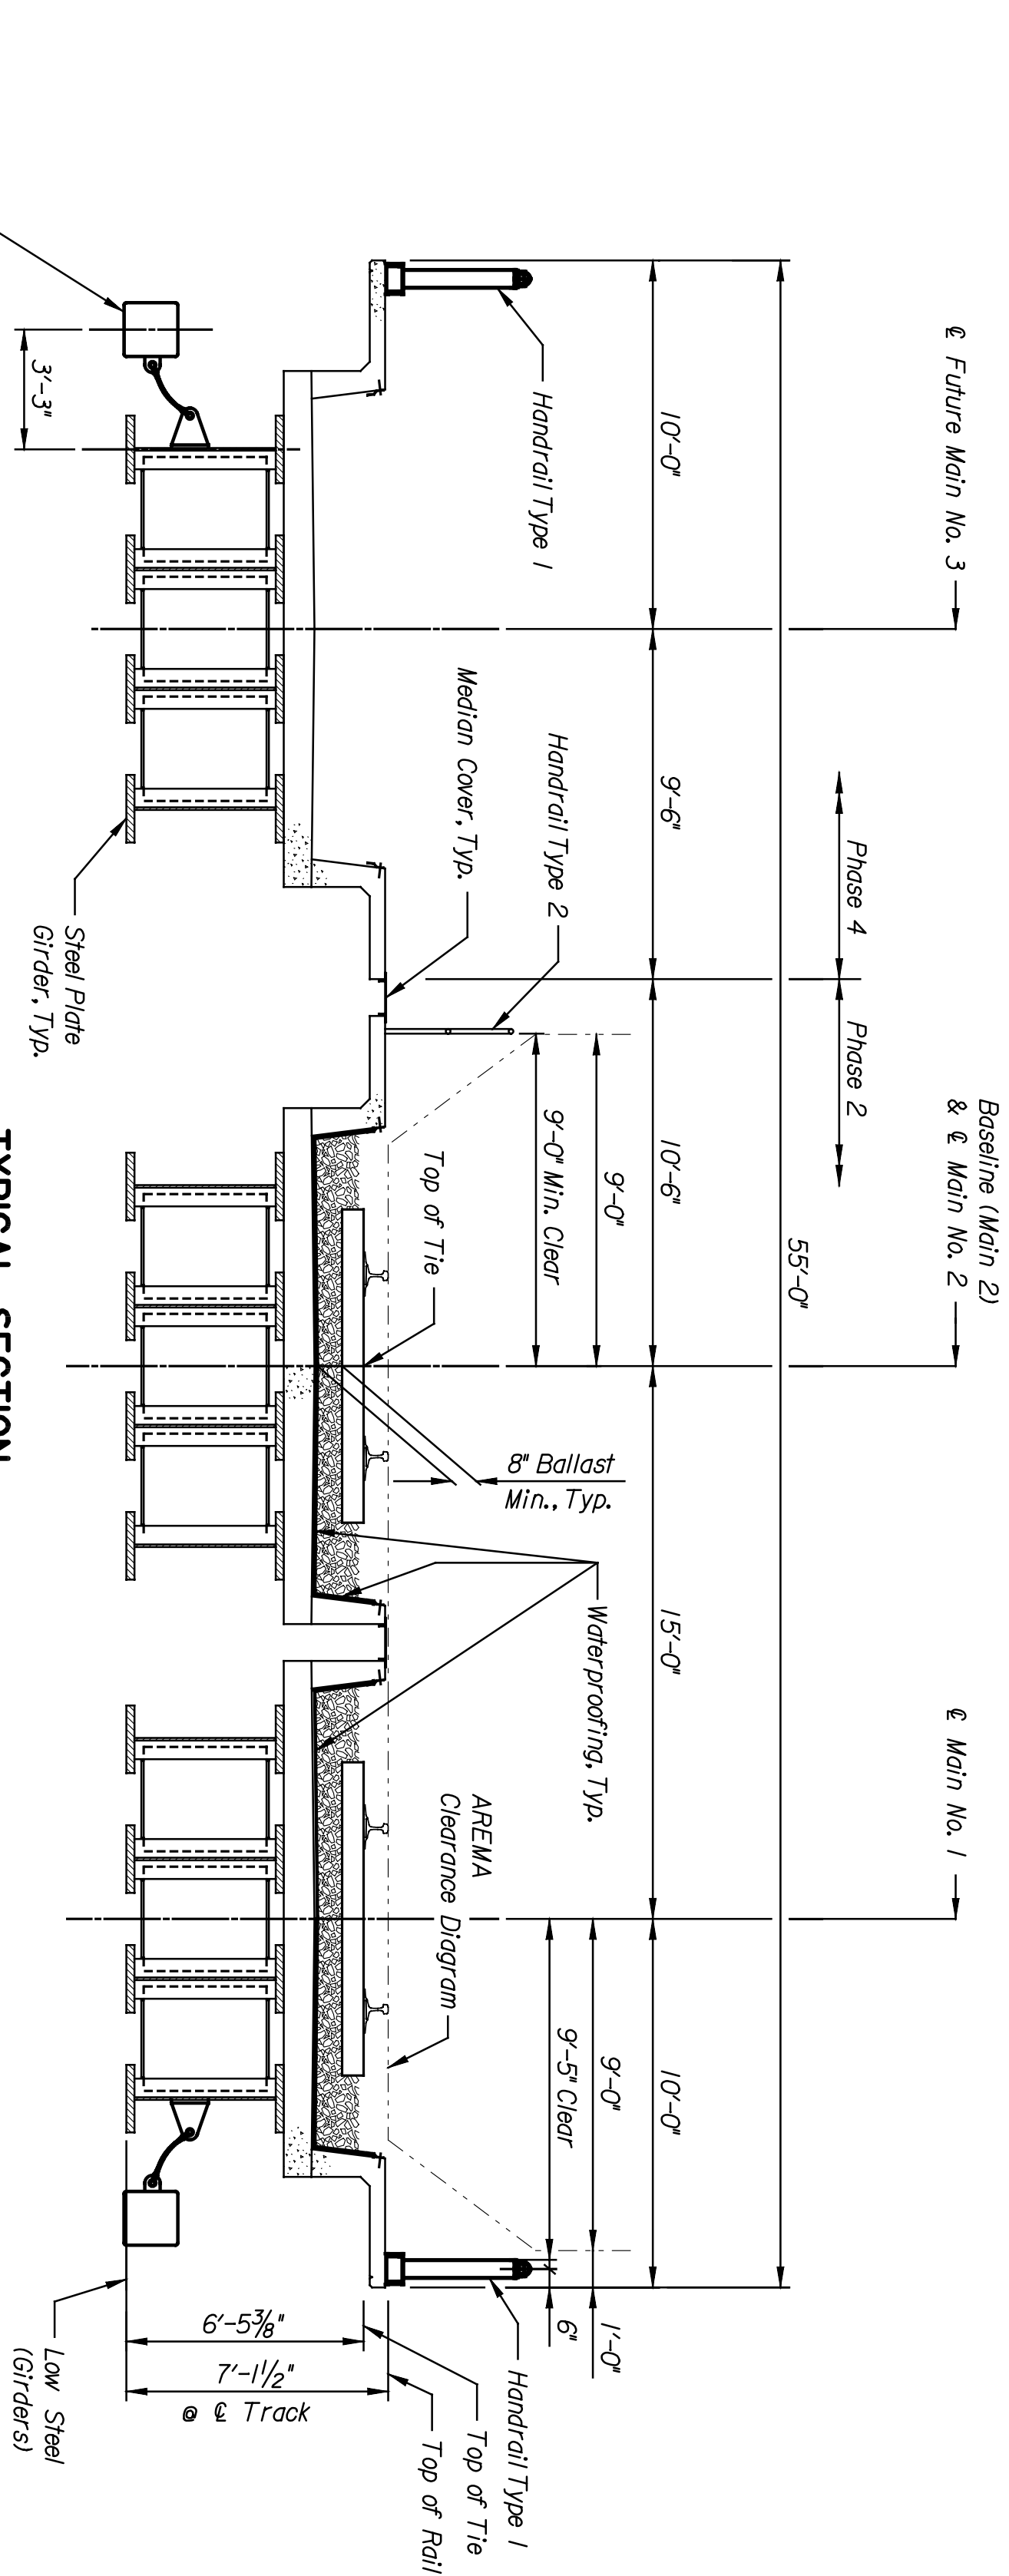

TYPICAL SECTION
 Scale: 1/4" = 1'-0"

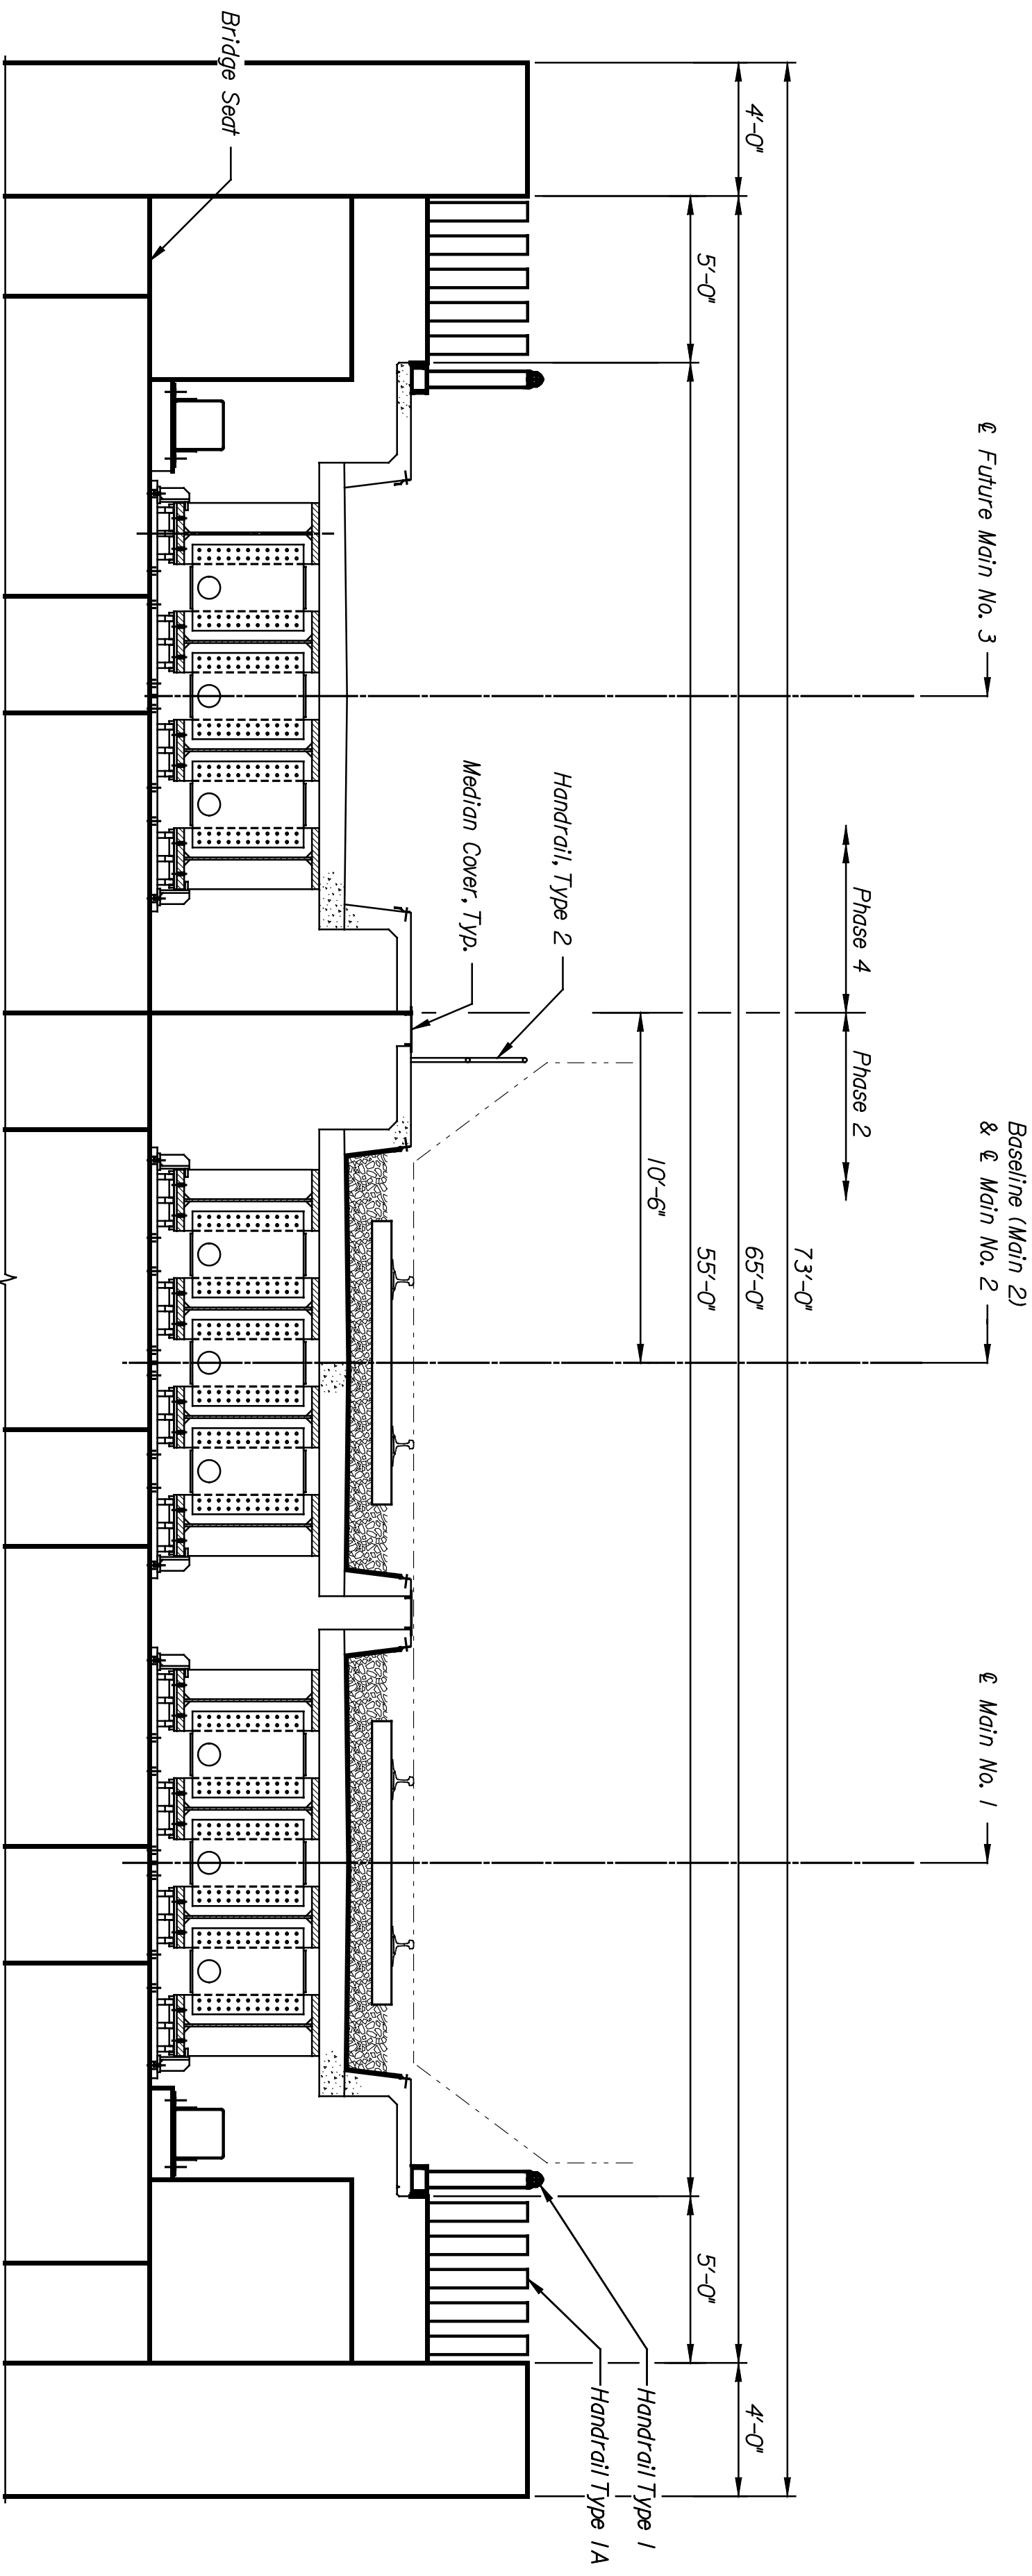

TYPICAL SECTION
 Scale: 1/4" = 1'-0"

INDEX OF BRIDGE DRAWINGS

SHEET NO.	DRAWING TITLE
BL2.1	GENERAL PLAN AND ELEVATION
BL2.2	TYPICAL SECTION
BL2.3	SUMMARY OF QUANTITIES AND GENERAL NOTES
BL2.4	FOUNDATION LAYOUT
BL2.5	ANCHOR BOLT LAYOUT
BL2.6	ABUTMENT NO. 1 PLAN
BL2.7	ABUTMENT NO. 1 ELEVATION & DETAILS
BL2.8	ABUTMENT NO. 1 FOOTING & DETAILS
BL2.9	ABUTMENT NO. 2 PLAN
BL2.10	ABUTMENT NO. 2 ELEVATION & DETAILS
BL2.11	ABUTMENT NO. 2 FOOTING & DETAILS
BL2.12	ABUTMENT NO. 1 WINGWALL ELEVATIONS & DETAILS
BL2.13	ABUTMENT NO. 2 WINGWALL ELEVATIONS & DETAILS
BL2.14	ABUTMENT DETAILS
BL2.15	TYPICAL FRAMING PLAN AND GIRDER ELEVATION
BL2.16	TYPICAL SUPERSTRUCTURE DETAILS
BL2.17	EXPANSION BEARING DEVICE DETAILS
BL2.18	FIXED BEARING DEVICE DETAILS
BL2.19	DECK PLAN
BL2.20	DECK SECTION & DETAILS
BL2.21	BRIDGE HANDRAIL (TYPE 1 / 1A)
BL2.22	BRIDGE HANDRAIL (TYPE 2)
BL2.23	WATERPROOFING & DRAINAGE DETAILS
BL2.24	PLANTER BRIDGE DETAILS I
BL2.25	PLANTER BRIDGE DETAILS II
BL2.26	COLLISION BEAM DETAILS
BL2.27	ABUTMENT NO. 1 REINFORCING DETAILS
BL2.28	ABUTMENT NO. 2 REINFORCING DETAILS
BL2.29	DECK REINFORCING DETAILS

NO.	DATE	REVISIONS	BY	APP'D.
3				
2				
1				

CITY OF WICHITA
WICHITA CENTRAL CORRIDOR
 ALTERNATE 5
 13TH STREET
 TYPICAL SECTION

DESIGNED: EKD	SCALE: AS NOTED	APP'D.	DRAWN: DMH	QUANTITIES: DJL	TRACED: DJL
CHECKED: DMH	Detailed: DMH	DATE: 01/04/05	DESIGN: DMH	QUANTITIES: DMH	TRACED: DMH

PNTEB
 ARCHITECTS ENGINEERS PLANNERS

This sheet designed by: