
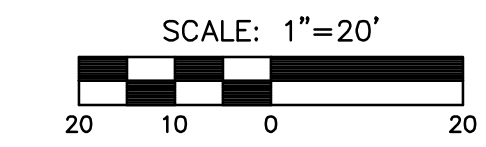


STATE	PROJECT NO.	YEAR	SHEET NO.	TOTAL SHEETS
KANSAS	87 N-0519-01	2012	145	212


**MKEC**  
ENGINEERING  
CONSULTANTS, INC.

411 N. WEBB ROAD  
WICHITA, K.S. 67206  
316-684-9600

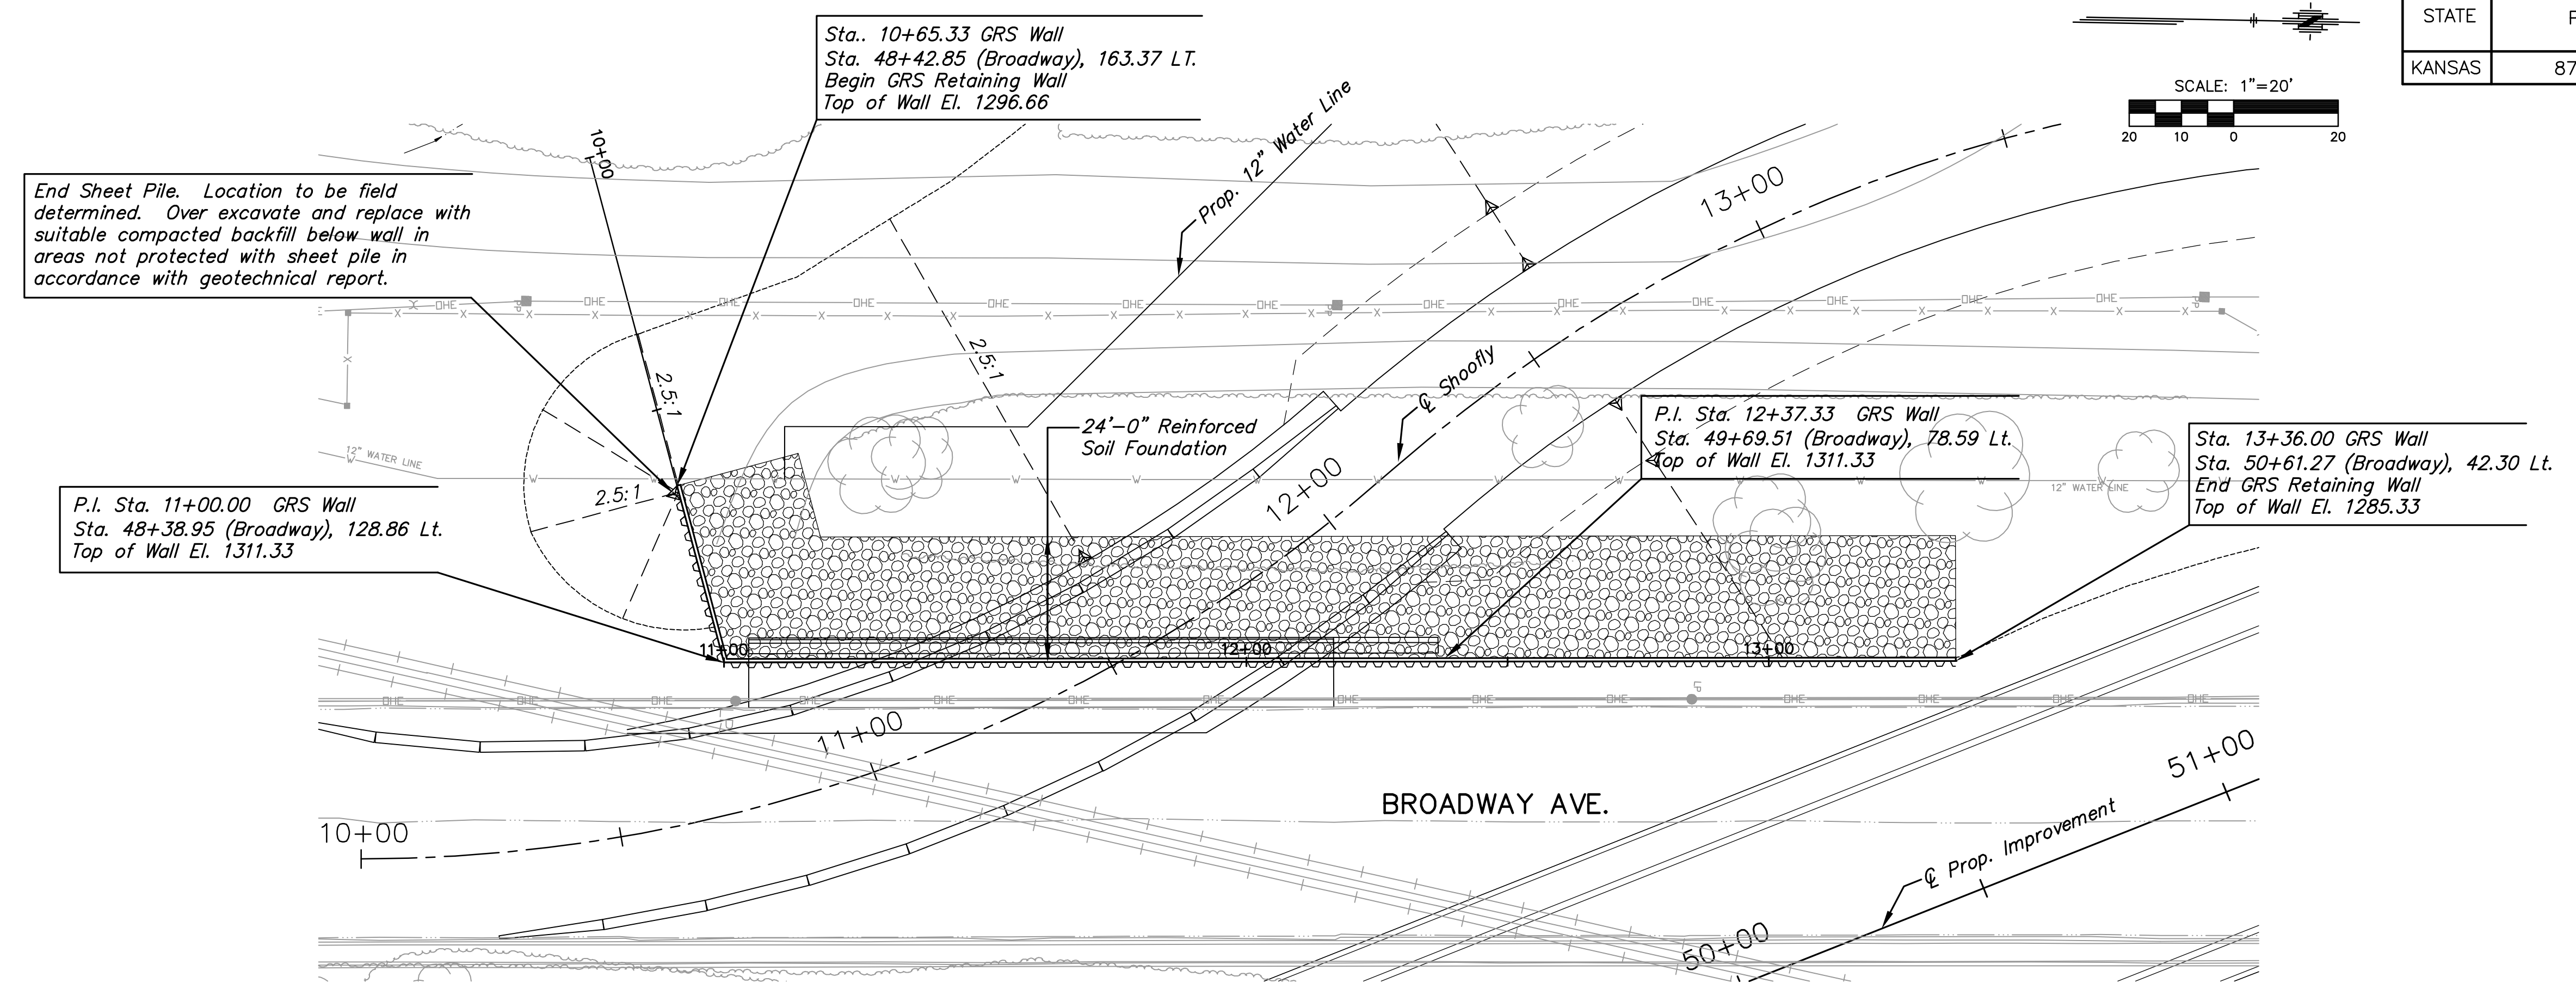

End Sheet Pile. Location to be field determined. Over excavate and replace with suitable compacted backfill below wall in areas not protected with sheet pile in accordance with geotechnical report.

GRS QUANTITIES	
Fabric	
Layer	Length
1	24'-0"
2	24'-0"
3	24'-0"
4	24'-0"
5	24'-0"
6	24'-0"
7	24'-0"
8	24'-0"
9	24'-0"
10	24'-0"
11	24'-0"
12	24'-0"
13	24'-0"
14	24'-0"
15	24'-0"
16	24'-0"
17	24'-8"
18	25'-4"
19	26'-0"
20	26'-8"
21	27'-4"
22	28'-0"
23	28'-8"
24	29'-4"
25	30'-0"
26	30'-8"
27	31'-4"
28	32'-0"
29	32'-8"
30	33'-4"
31	34'-0"
32	34'-8"
33	35'-4"
34	36'-0"
35	36'-8"
36	37'-4"
37	38'-0"
38	38'-8"
39	39'-4"
40	40'-0"
41	40'-8"
42	41'-4"

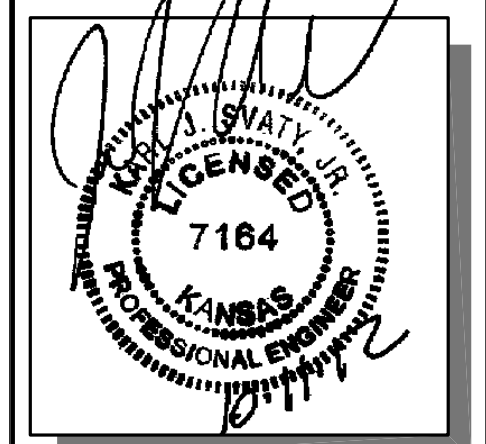

# BROADWAY BRIDGE AT 34TH STREET SOUTH

## WALL PLAN AND PROFILE GRS WALL

SHEET TITLE  
472-84830  
PROJECT NUMBER


DESIGN BY: JRA  
DRAWN BY: WNU  
CHECKED BY: JRA

ISSUED  
October 9, 2012  
REVISED

SHEET NO.  
145 of 212

PLAN - GRS WALL

PROFILE - GRS WALL  
HORIZONTAL SCALE: 1" = 20'  
VERTICAL SCALE: 1" = 5'

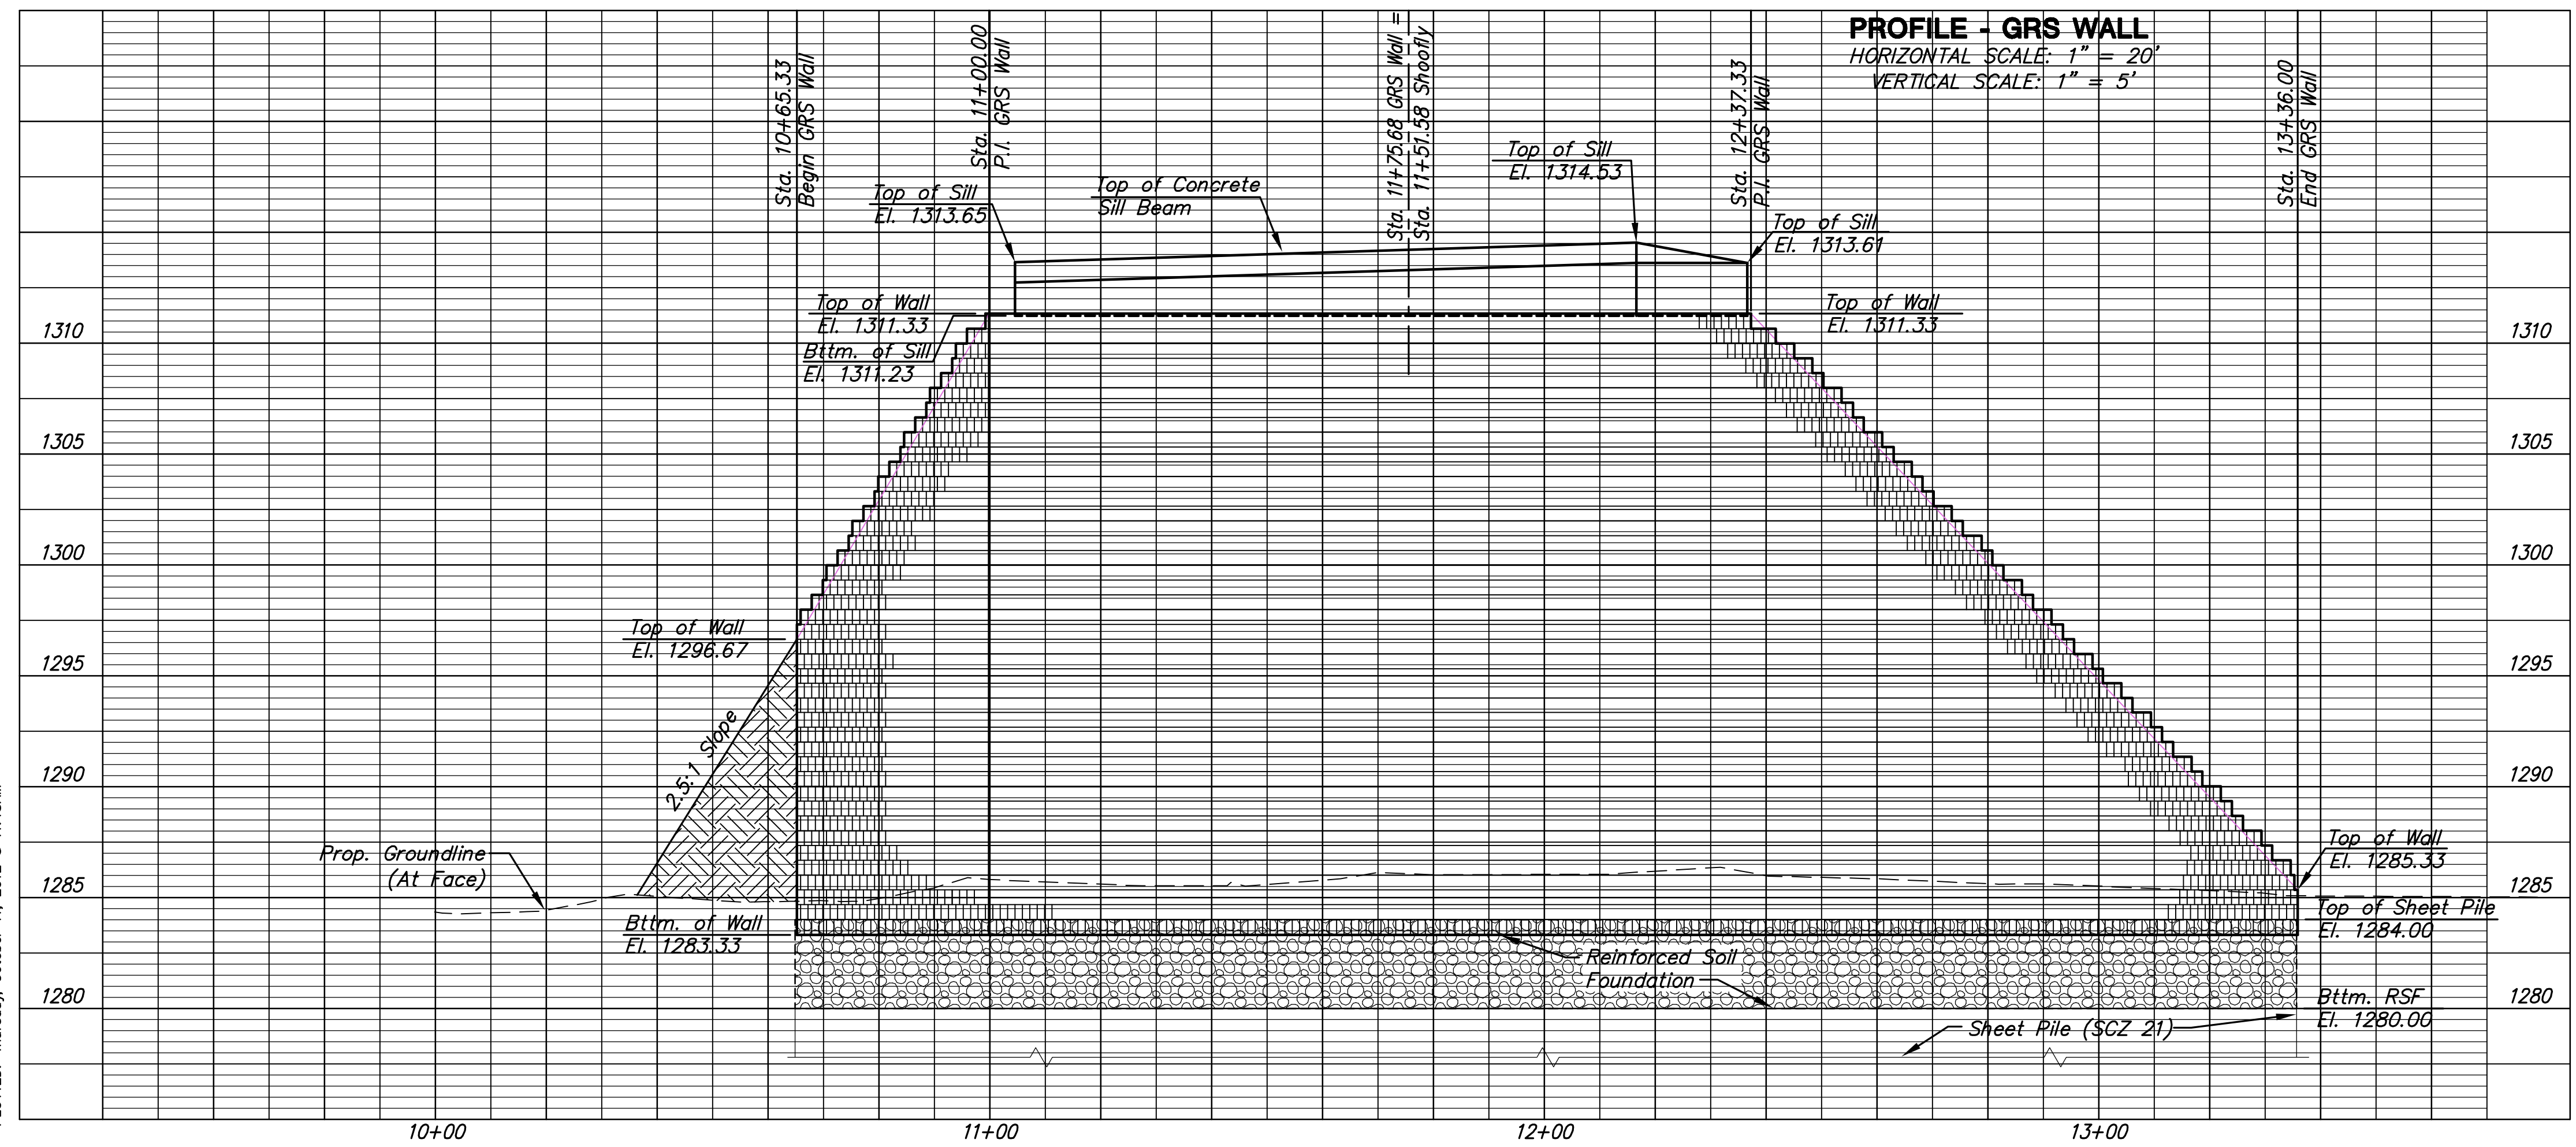

NOTE: See Bridge Construction Layout Sheet 78 for boring logs

PLOTED: Thursday, October 11, 2012 @ 11:18AM

J:\Civil\09081.dwg\09081-GRS Wall