


PLOT: Monday, March 17, 2014 @ 01:38PM

CURVE TABLE - C7					
△ = 102°31'46" R = 90.00' T = 112.20' L = 161.05' LC = 140.41'					
CURVE DATA BASED ON CENTERLINE Δ/2 = 51°15'53"					
STATION	ARC	CHORD LENGTH		DEFLECTION	TOTAL DEFLECTION
		8' Off LICb	8' Off RICb		
17+65.85	-	-	-	00°00'00"	00°00'00"
17+74.09	8.24'	6.22'	10.25'	02°37'22"	02°37'22"
17+75.00	0.91'	0.69'	1.13'	00°17'23"	02°54'45"
17+79.65	4.65'	3.51'	5.79'	01°28'49"	04°23'34"
18+00.00	20.35'	15.34'	25.27'	06°28'39"	10°52'13"
18+23.15	23.15'	17.44'	28.73'	07°22'08"	18°14'21"
18+23.87	0.72'	0.54'	0.90'	00°13'45"	18°28'06"
18+25.00	1.13'	0.85'	1.41'	00°21'35"	18°49'41"
18+28.71	3.71'	2.80'	4.62'	01°10'51"	20°00'32"
18+46.38	17.67'	13.33'	21.95'	05°37'28"	25°38'01"
18+50.00	3.62'	2.73'	4.50'	01°09'08"	26°47'09"
18+72.50	22.50'	16.96'	27.93'	07°09'43"	33°56'52"
18+75.00	2.50'	1.89'	3.11'	00°47'45"	34°44'37"
18+80.37	5.37'	4.06'	6.68'	01°42'34"	36°27'10"
19+00.00	19.63'	14.80'	24.38'	06°14'54"	42°42'05"
19+20.00	20.00'	15.08'	24.84'	06°21'58"	49°04'03"
19+25.00	5.00'	3.78'	6.22'	01°35'30"	50°39'32"
19+26.90	1.90'	1.44'	2.37'	00°36'21"	51°15'53"

Def/Ft = 19.09859 Min.

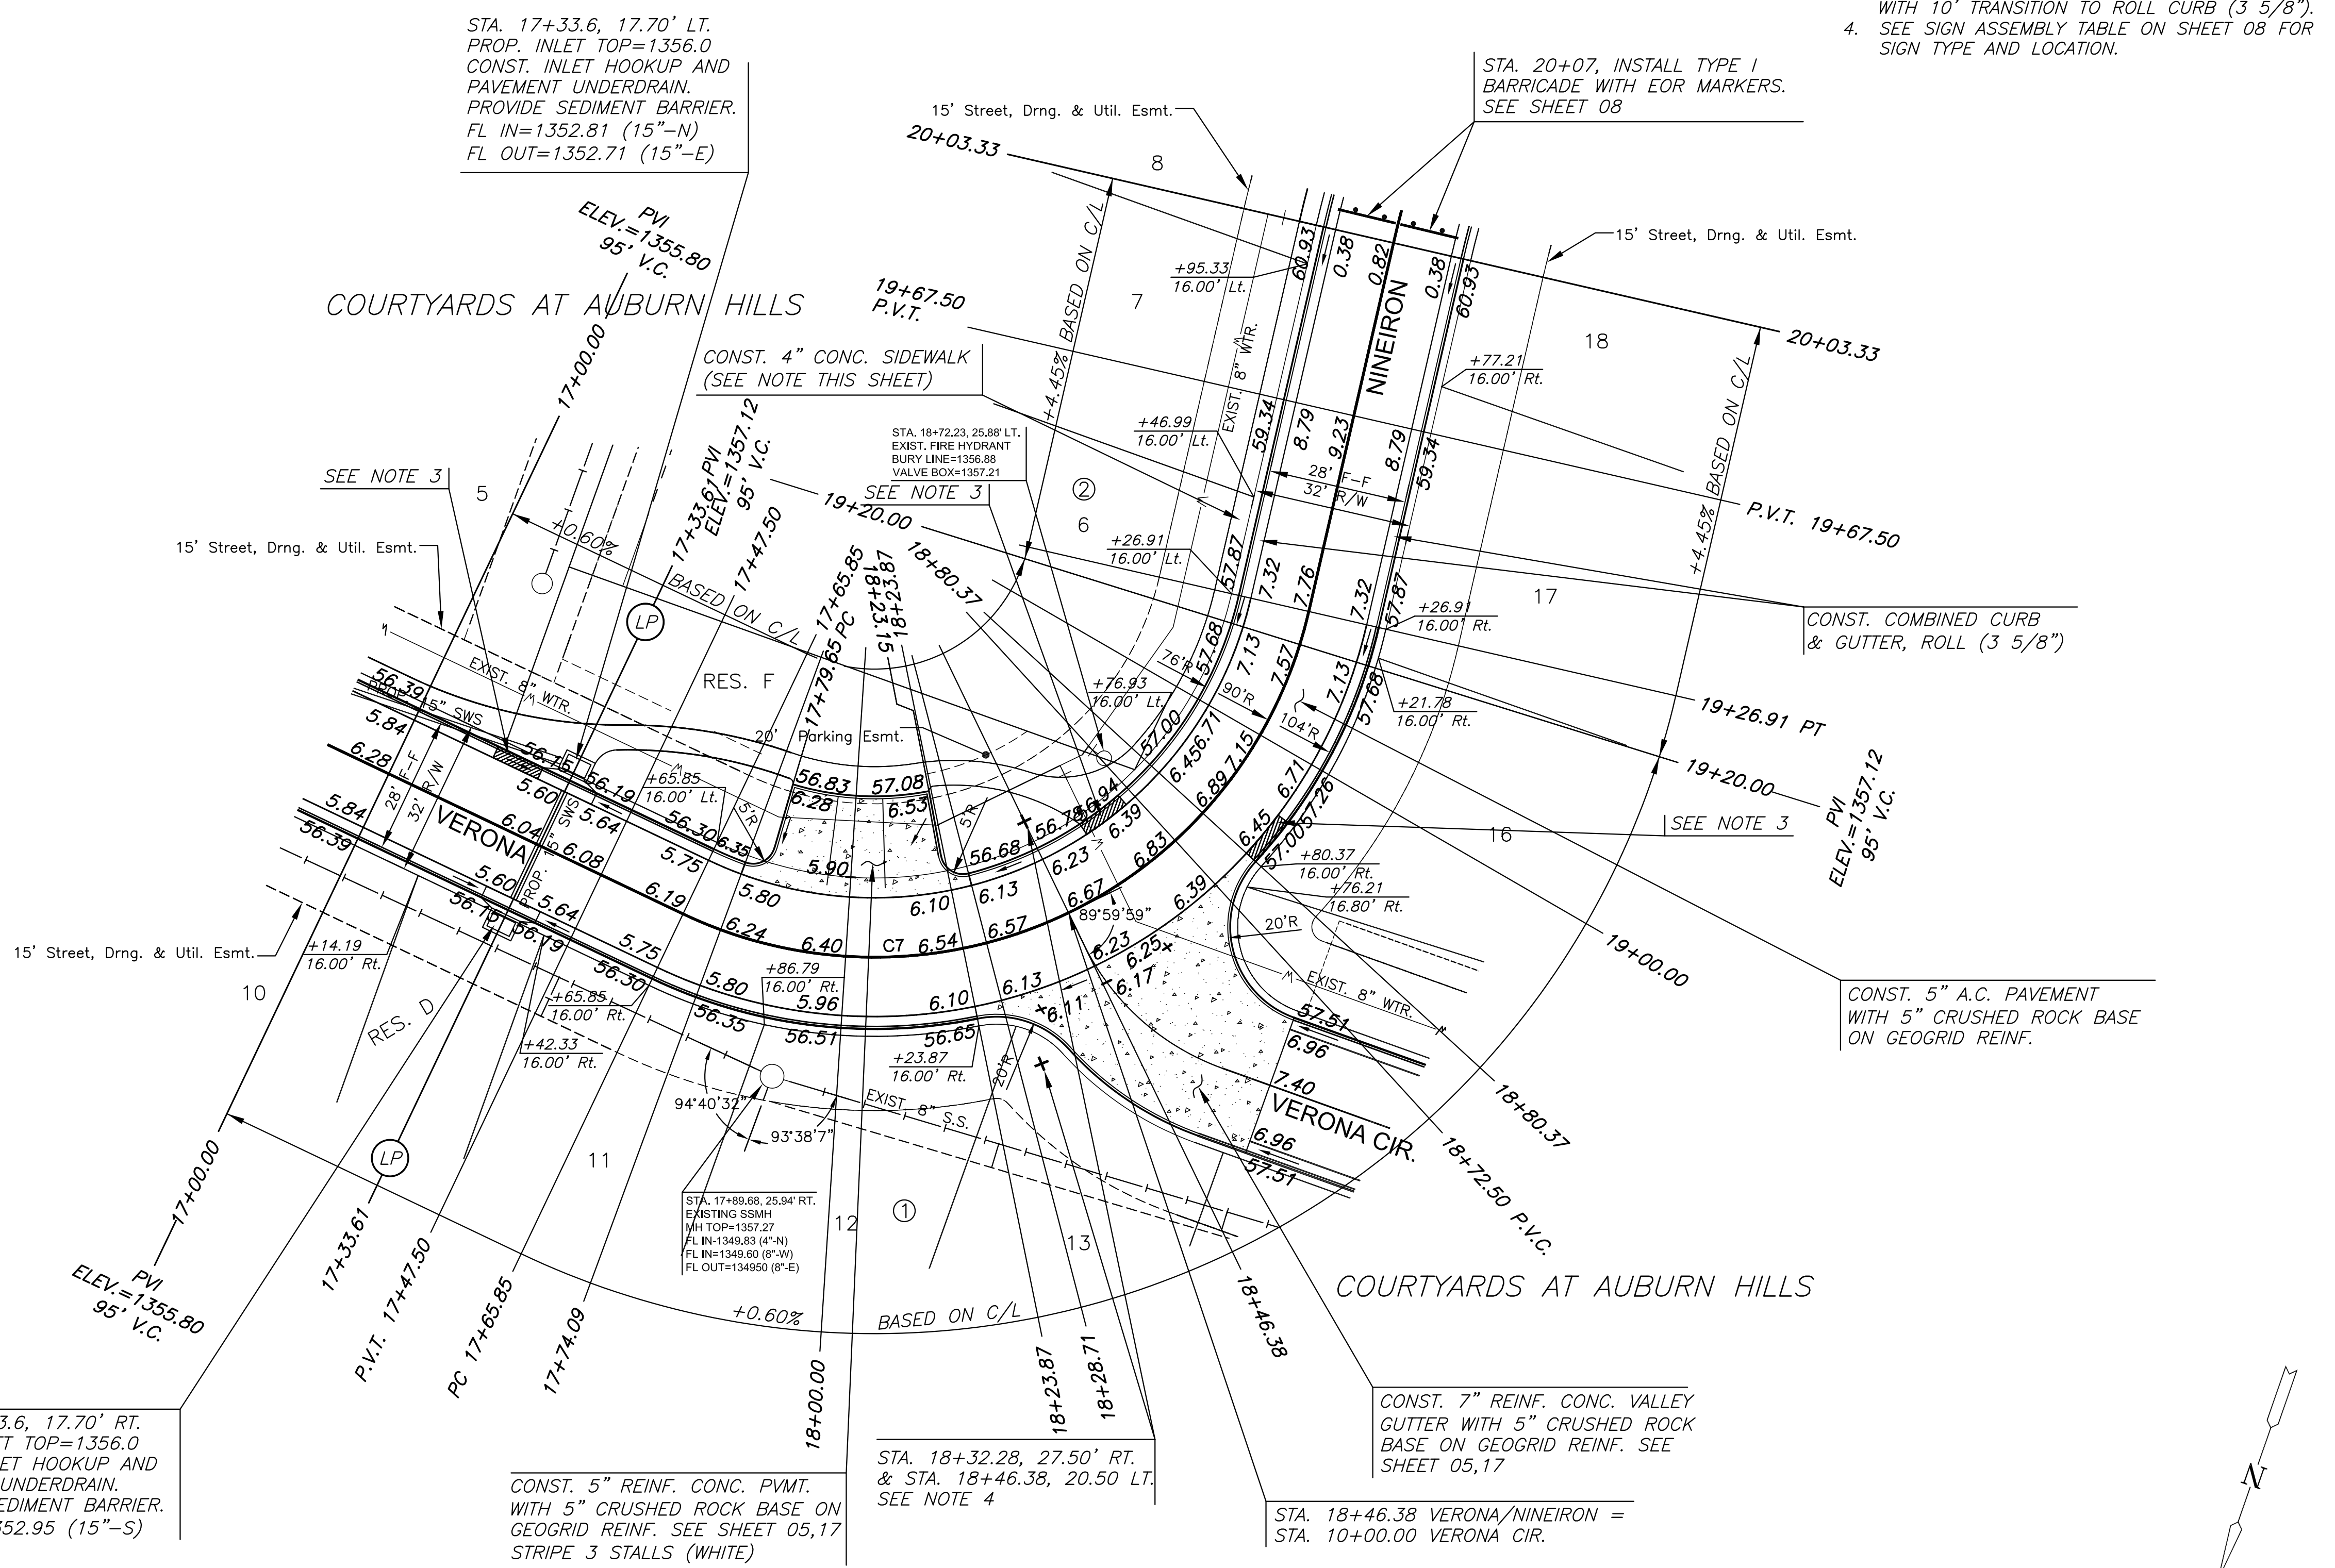

LEGEND

- 10' CURB TRANSITION (SEE NOTE 3)
- STREET SIGN (SEE NOTE 4)

NOTES

1. TOP OF CURB ELEVATIONS SHOWN ARE FOR FULL CURB. CONSTRUCT CURB AND GUTTER AS NOTED.
2. SIDEWALKS TO BE CONSTRUCTED AT 5' WIDTH EXCEPT AT THOSE LOCATIONS ACROSS ENDS OF PARKING WHERE THEY SHALL BE 6' WIDTH.
3. CONSTRUCT CURB AND GUTTER, FULL (6 5/8") WITH 10' TRANSITION TO ROLL CURB (3 5/8").
4. SEE SIGN ASSEMBLY TABLE ON SHEET 08 FOR SIGN TYPE AND LOCATION.



PAVING & INCIDENTAL DRAINAGE FOR
COURTYARDS AT AUBURN HILLS
 PHASE 1

©2013 MKEC Engineering All Rights Reserved
 These drawings and their contents, including, but not limited to, all concepts, designs, & ideas are the exclusive property of MKEC Engineering (MKEC), and may not be used or reproduced in any way without the express consent of MKEC.

VERONA AND NINEIRON
 PAVING PLAN 15+00 TO
 20+03.33

PROJECT NO.	472-85128		
DATE	MAR, 2014		
SCALE	1"=20'		
DESIGNED	DRAWN	CHECKED	
SPE	WNJ	JTC	
#	NO.	REVISION	DATE

SHEET NO.
 12 OF 52

