


GRADING PLANS FOR
COURTYARDS AT AUBURN HILLS
PHASE 1

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EROSION CONTROL PLAN

PROJECT NO.	472-85128	
DATE	MAR, 2014	
SCALE	AS SHOWN	
DESIGNED	DRAWN	CHECKED
JTC	LES	JTC
#	REVISION	DATE
NO.	REVISION	DATE

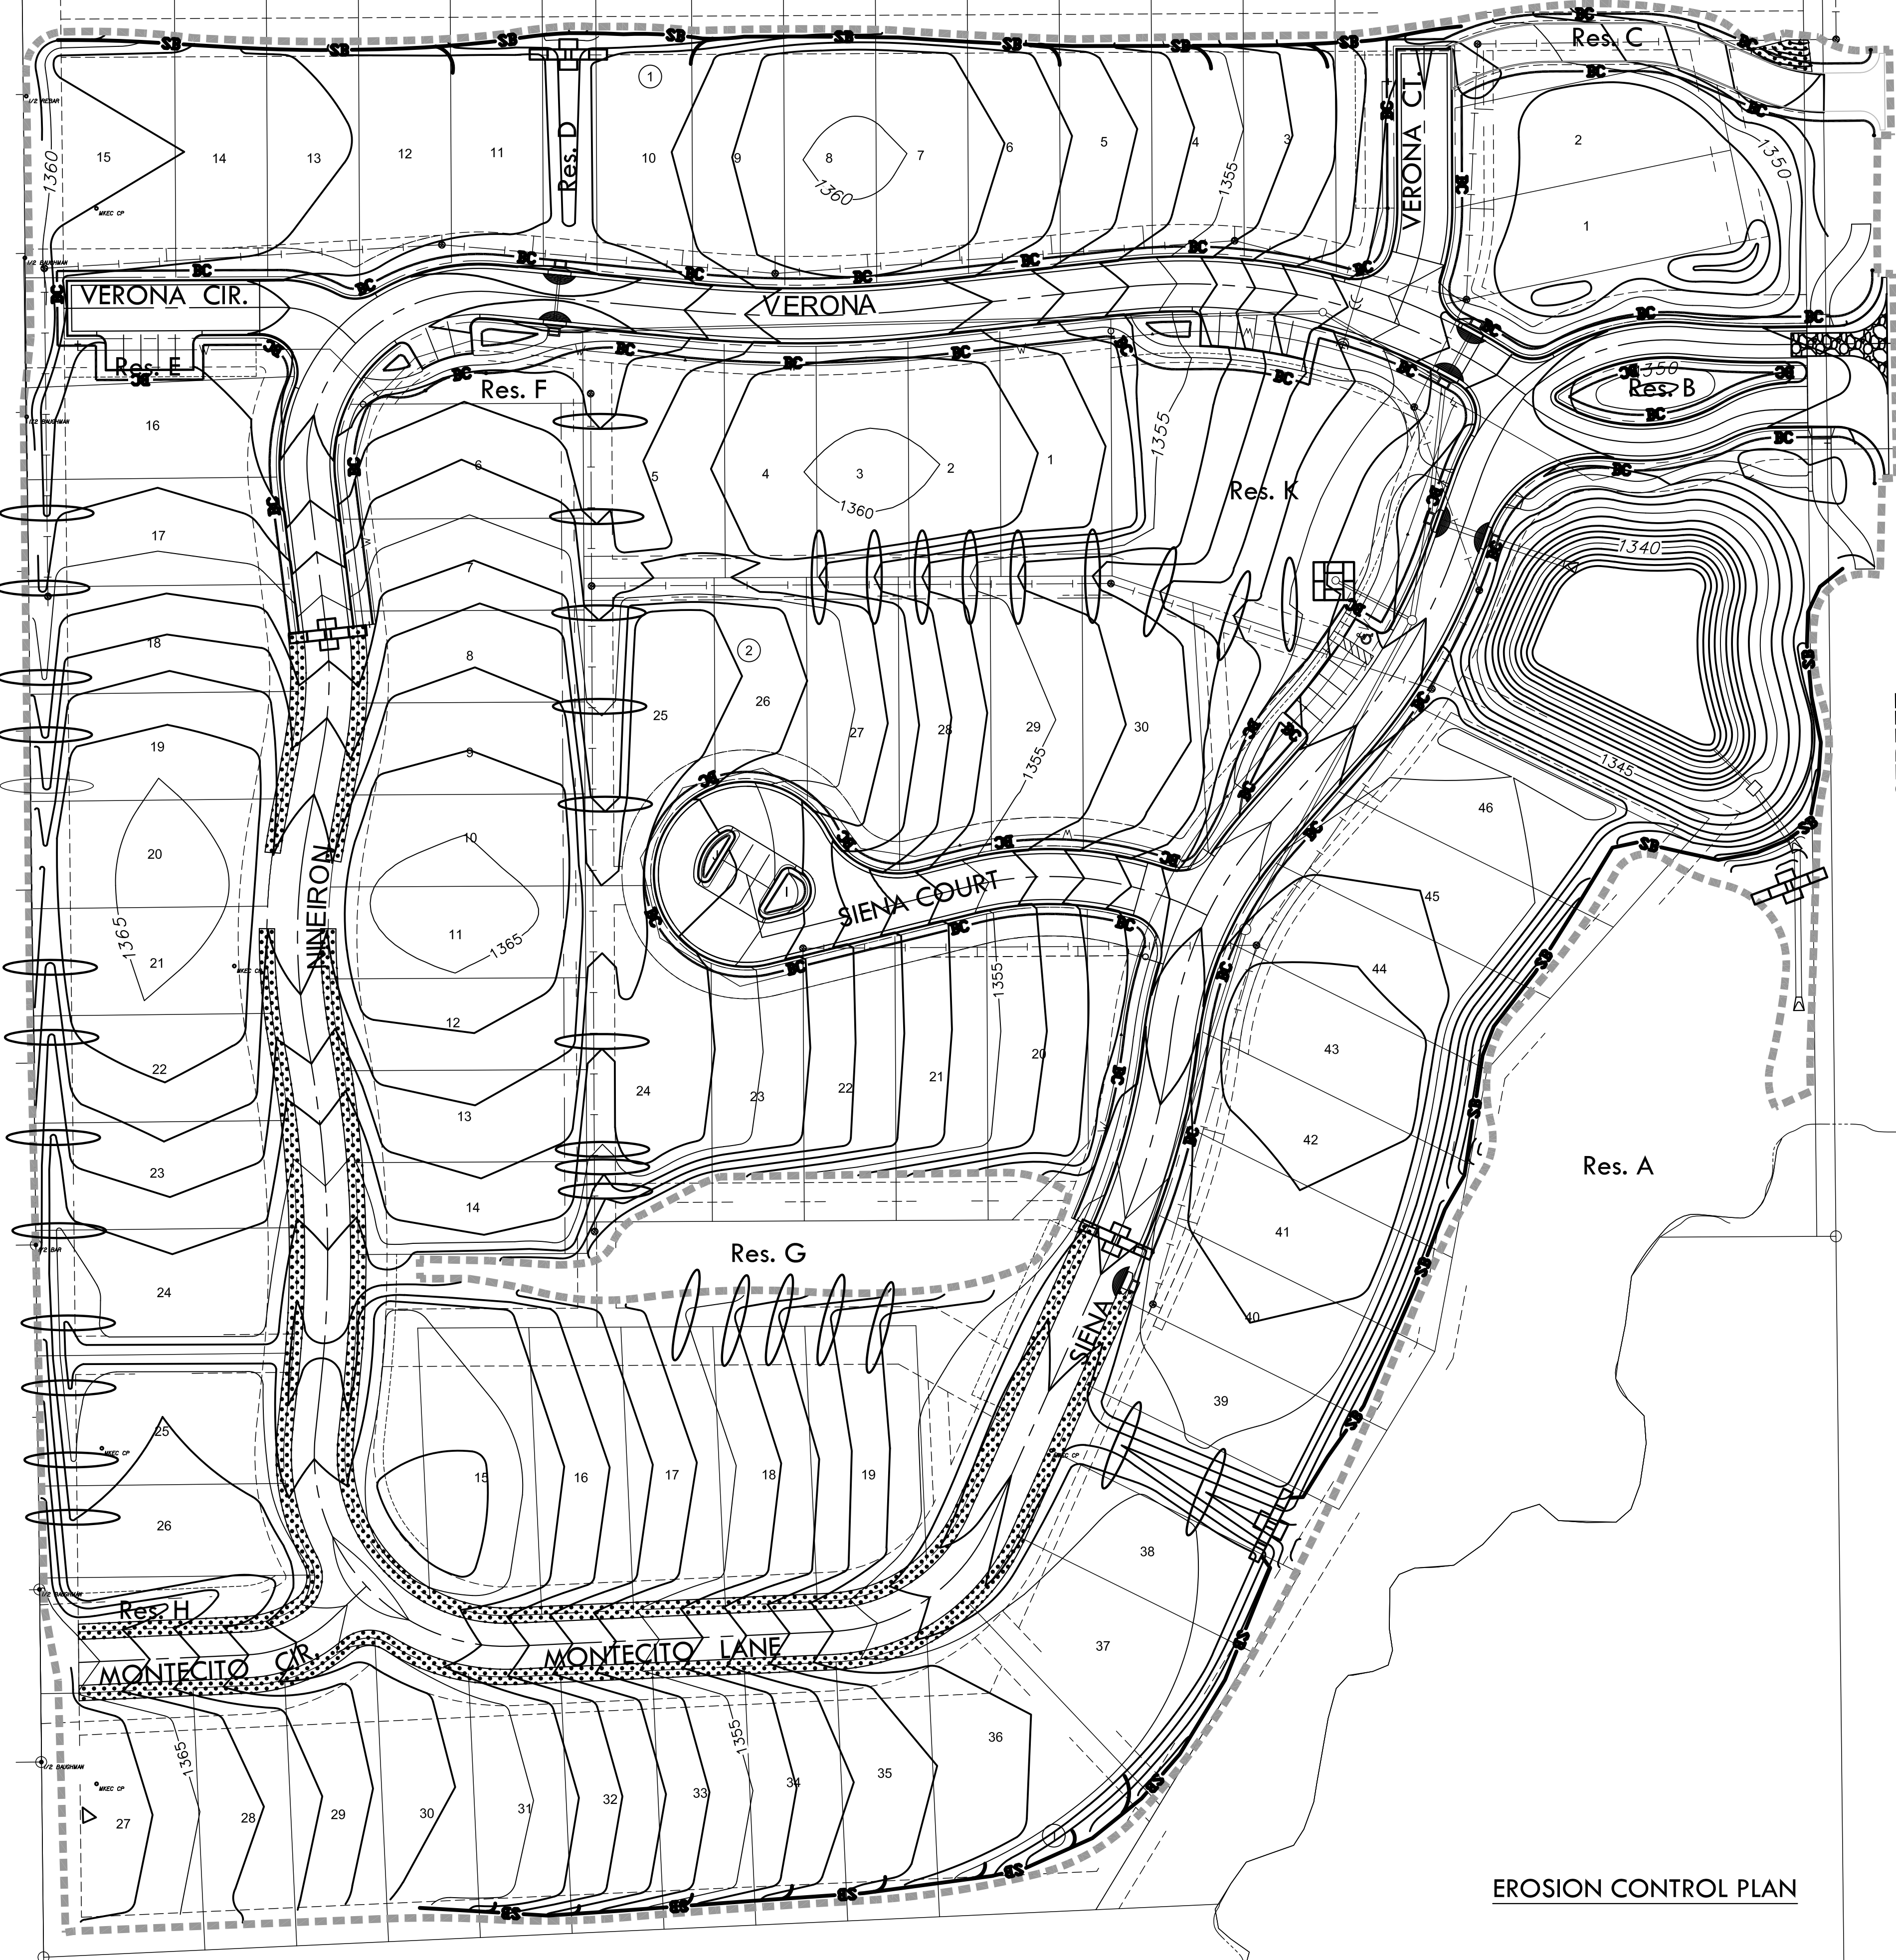


EROSION CONTROL NOTES


1. EROSION CONTROL IS TO MEET ALL FEDERAL, STATE, COUNTY AND LOCAL CODE STANDARDS.
2. CONTRACTOR SHALL PROVIDE AND PRESERVE EROSION PROTECTION THROUGHOUT PROJECT CONSTRUCTION. THE PLAN PROVIDED HERE IS FOR FINAL PROTECTION, VARIOUS PHASES OF THIS PLAN SHALL BE IMPLEMENTED OR MODIFIED TO CONTROL EROSION. MODIFICATIONS OF THE PLAN SHALL BE APPROVED BY THE OWNERS REPRESENTATIVE.
3. CONTRACTOR IS RESPONSIBLE FOR MAINTAINING AND IMPLEMENTING ALL EROSION CONTROL.
4. CONTRACTOR SHALL INSTALL AND MAINTAIN A STABILIZED CONSTRUCTION ENTRANCE AT A LOCATION DETERMINED BY THE ENGINEER.

CRIMPING NOTES

1. ONCE TOPSOIL HAS BEEN PLACED, DISC/SCARIFY SOIL PRIOR TO SPREADING PRAIRIE HAY.
2. SPREAD PRAIRIE HAY (2 TONS/AC.) AND IMMEDIATELY CRIMP INTO TOPSOIL WITH SUITABLE MECHANICAL EQUIPMENT.

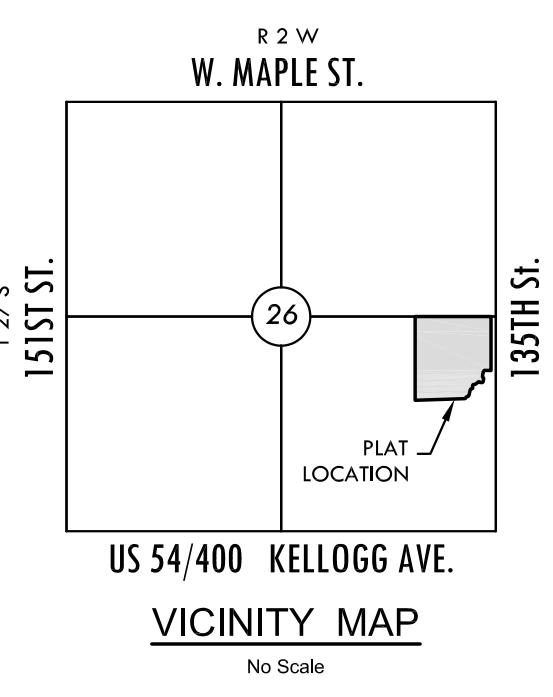


BENCH MARKS

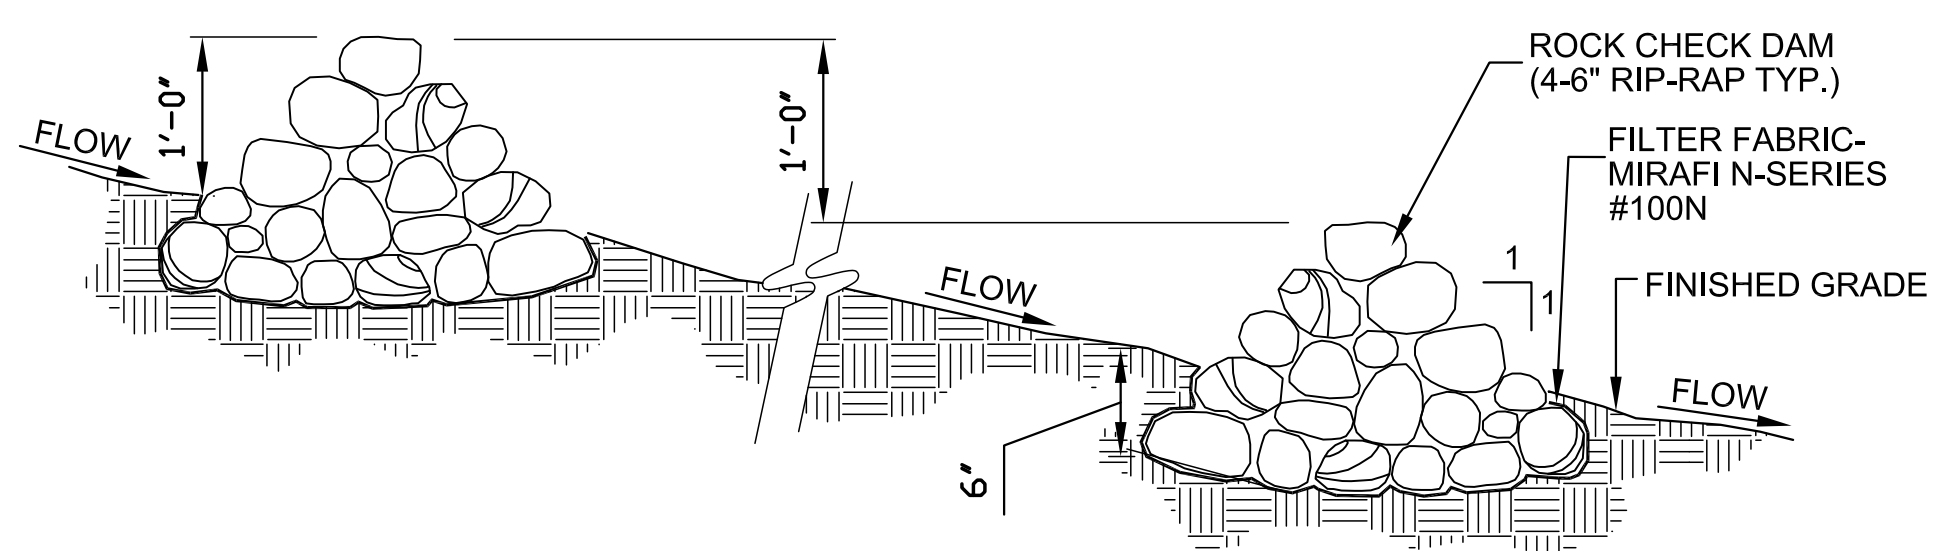

ROCK CHECK DAM - SECTION
SCALE: N.T.S.

EROSION CONTROL LEGEND

- SEEDING LIMITS
- ANNUAL RYE 200 LBS/ACRE
- FERTILIZE 10-20-10 @ 150 LBS/ACRE (BOUNDARY GIVEN FOR INFORMATION ONLY)
- SILT FENCE PROTECTION
- BACK OF CURB PROTECTION
- PROPOSED STORM SEWER LINE
- 1.360 PROPOSED CONTOURS
- EXISTING CURB INLET FILTER
- EXISTING INLET PROTECTION
- CURB INLET FILTER
- INLET PROTECTION
- HAYBALE BARRIER
- STABILIZED ENTRANCE
- EROSION CONTROL MAT (8' WIDE CURLEX I or II EXCELSIOR MAT)
- ROCK CHECK DAM

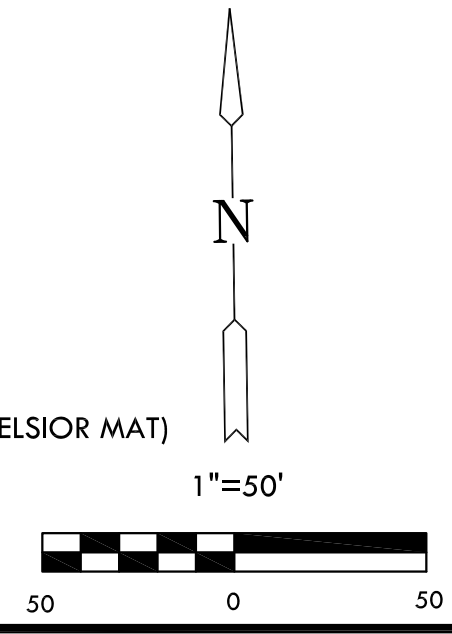

PLOTTED: Monday, March 17, 2014 @ 01:45PM
 J:\PROJECTS\2013\1301010292_PERFECTION_COURTYARDS_AT_AUBURNHILLS\CIVIL\DWG\PHASE 1\13022FP01.DWG