

BASE BID

SCHOOL DRIVE TO BE CLOSED DURING CONSTRUCTION SILVER FOX. INSTALL TRAFFIC CONTROL DEVICES AS NEEDED PER MUTCD MANUAL TO CLOSE STREET. REFER TO DEMO NOTES FOR REMOVAL OF THE EXISTING DRIVE.



ADD ALT #1 CONSTRUCTION SEQUENCE

THIS PROJECT PLAN SET IS TIED TO THE STORM WATER DRAIN #394 GRADING PLANS. REFERENCE SAID PLAN TO COORDINATE LOT, STREET, & BERM FILL OPERATIONS

1. CONSTRUCT PROPOSED SILVER FOX FROM STA. 10+98.07 TO STA. 22+11.32 AND NORTH HALF OF CONCRETE VG AT SILVER FOX ST AND MAIZE ROAD.
2. CONSTRUCT TEMPORARY CONNECTION TO EXISTING SILVER FOX (EAST END)
3. INSTALL TEMPORARY CONNECTION TO MAIZE ROAD (SOUTH HALF OF VG). SEE SHEET 12 FOR CONNECTION
4. INSTALL TRAFFIC CONTROL DEVICES AS NEEDED PER MUTCD MANUAL TO SWITCH TRAFFIC TO NEW SILVER FOX ST.
5. DEMO EXISTING STREET (SEE DEMO NOTE). CONSTRUCT BERM. EARTHWORK EQUIPMENT SHALL CROSS OVER SILVER FOX AT THE TEMPORARY CONNECTION. FLAGMEN TO BE USED DURING CONSTRUCTION TO PROTECT TRAFFIC. (CONTRACTOR SHALL TAKE CARE TO PROTECT ASPHALT PAVEMENT WHERE EQUIPMENT CROSSES).
6. INSTALL TRAFFIC CONTROL DEVICES AS NEEDED PER MUTCD MANUAL TO CLOSE STREET. CLOSE SILVER FOX TO COMPLETE PERMANENT CONNECTIONS AT EACH END OF STREET WORK. ROAD CLOSURE SHALL NOT EXCEED 15 CALENDAR DAYS.

DEMO NOTES

EXISTING ASPHALT DRIVE SHALL BE REMOVED AND HAULED OFF SITE. PRIOR TO BERM CONSTRUCTION THE SUBGRADE BELOW THE REMOVED PAVEMENT SHALL BE RIPPED TO A DEPTH OF 12" TO ALLEVIATE COMPACTED SOILS.

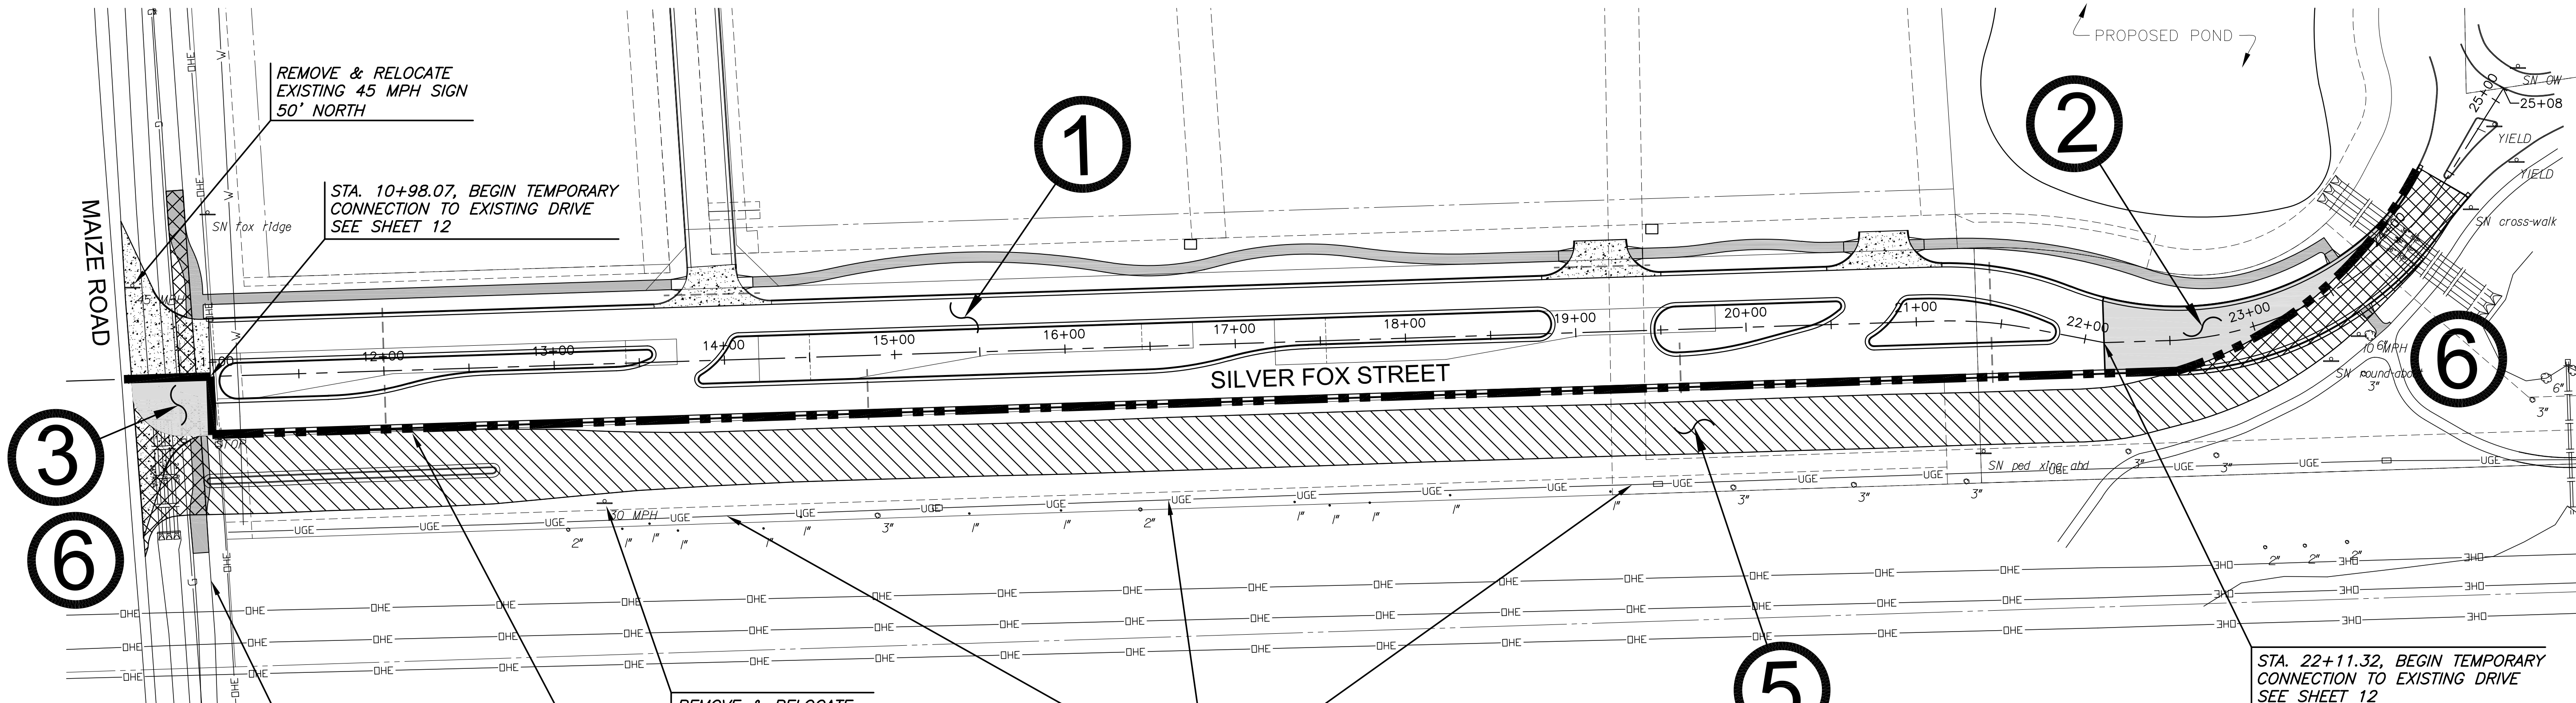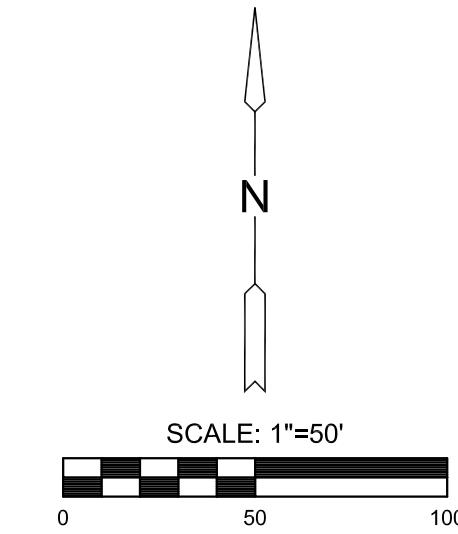

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
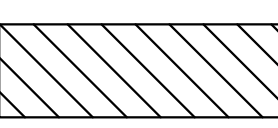
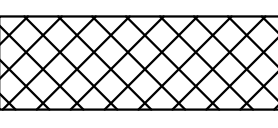

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1

- 1** = SEQUENCE NUMBER
-  = PHASE DELINEATION
-  = DEMO (SEE NOTE 5)
-  = DEMO (SEE NOTE 6)
-  = TEMP. ASPHALT HOOKUP

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CONST. SEQUENCE & DEMO PLAN

PROJECT NO.	472-85166	
DATE	JULY 2015	
SCALE	1"=50'	
DESIGNED	DRAWN	CHECKED
DFL	JWC	GJA
NO.	REVISION	DATE

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