


STATE	PROJECT NO.	YEAR	SHEET NO.	TOTAL SHEETS
KANSAS	87 N-0615-01	2017	1	183




KDOT PROJ. NO. 87 N-0615-01
F.A. NO. STP-N-061(501)

GRADING
SURFACING
STORM SEWER
BRIDGE
PAVEMENT MARKING
SEEDING

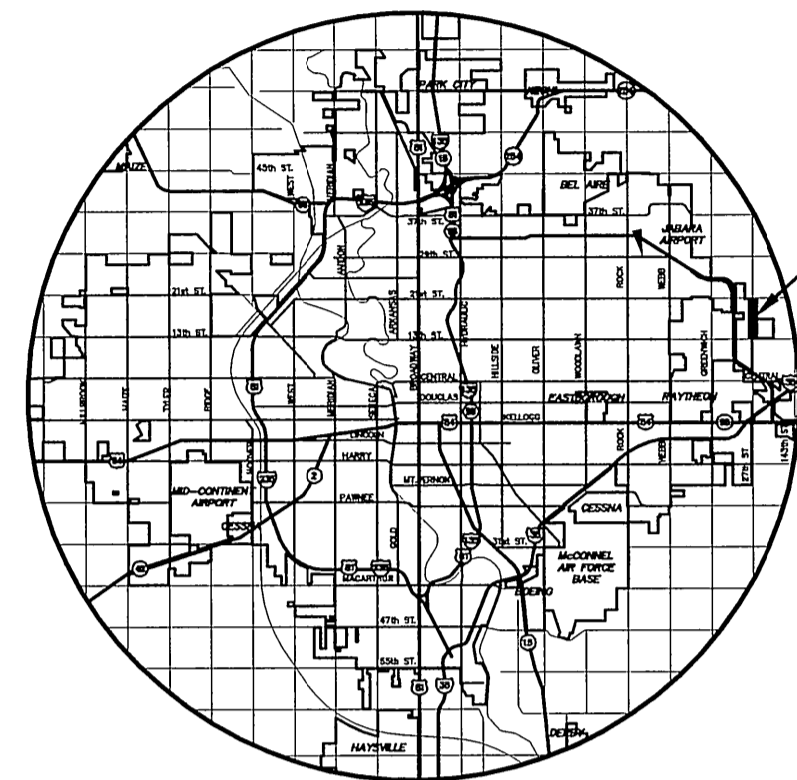

LOCATION MAP

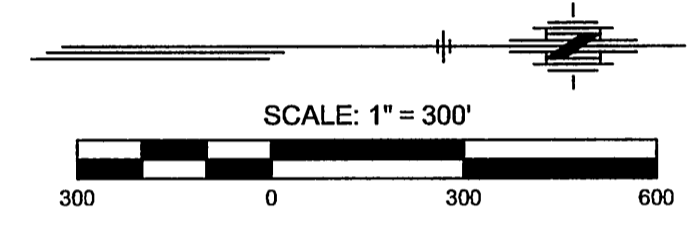


STATE OF KANSAS
DEPARTMENT OF TRANSPORTATION
PLAN AND PROFILE OF PROPOSED
127TH STREET EAST
FROM 13TH STREET NORTH TO 21ST STREET NORTH
FEDERAL AID PROJECT
CITY OF WICHITA PROJECT NO. 472-85158
CITY OF WICHITA OCA NO. 707065
SEDGWICK COUNTY
CITY OF WICHITA

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17-19	PAVING BUBBLES MAPS
20	STORM SEWER KEY MAP
21	STORM SEWER SUMMARY
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73	SANITARY SEWER MANHOLE DETAILS
75	MISCELLANEOUS DETAILS
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Sta. 23+78.56 Const.
 Br. No. 530400870WBFM20
 30'-40'-30' R.C.
 Haunched Slab Spans
 48'-0" Roadway
 6'-0" Walkway, Lt.
 30° Skew Rt.



Sta. 62+51.82 End
 Proj. No. 87 N-0615-01

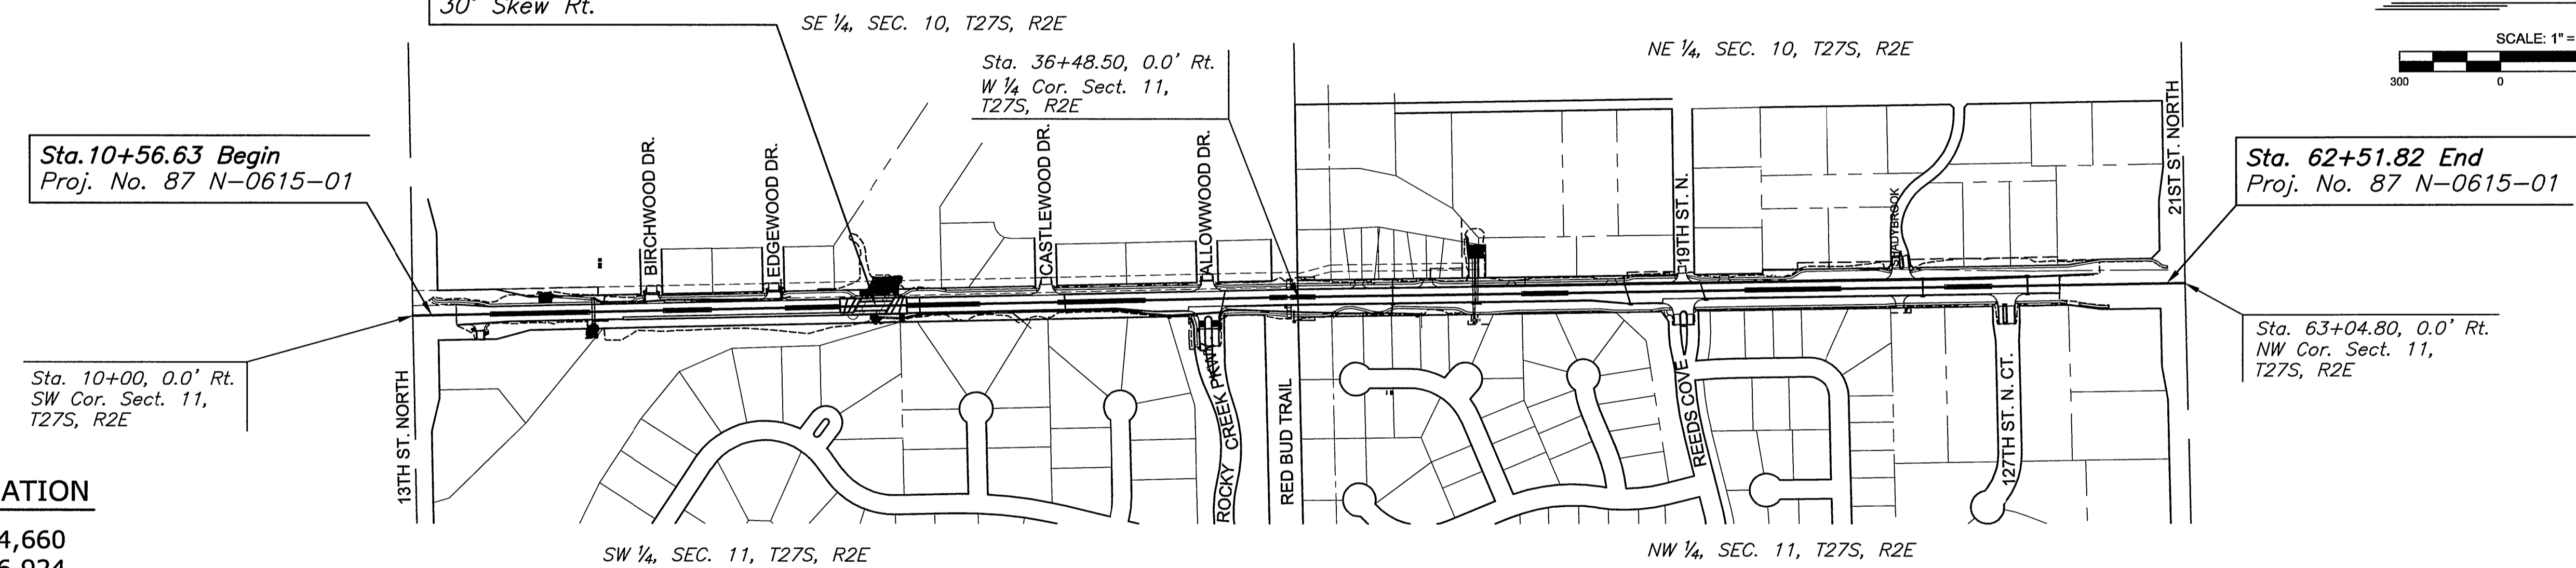Sta. 63+04.80, 0.0' Rt.
 NW Cor. Sect. 11,
 T27S, R2E

Sta. 10+56.63 Begin
 Proj. No. 87 N-0615-01

Sta. 10+00, 0.0' Rt.
 SW Cor. Sect. 11,
 T27S, R2E

DESIGN DESIGNATION

- AADT (2014) = 4,660
- AADT (2034) = 6,924
- DHV = 10%
- D = 60%
- T = 3%
- V = 40 MPH
- C of A = None
- Lateral Offset = 2 FT.


CONVENTIONAL SIGNS

COUNTY LINE	-----	CENTER LINE OF PROJECT	-----
CITY LIMITS	-----	TERRACE	-----
STATE OR NATIONAL LINE	-----	CULVERTS	-----
TOWNSHIP, SECTION or GRANT LINE	-----	DROP INLET & STORM SEWER	-----
PROPERTY LINE	-----	ACCESS CONTROL	-----
HIGHWAY FENCE	-----	POWER POLE	-----
EXISTING FENCE	-----	TELEPHONE POLE	-----
GUARDRAIL	-----	MARSH	-----
CONSTRUCTION LIMITS	-----	HEDGE	-----
RIGHT OF WAY LINE	-----	TREES	-----
TRAVELED WAY	-----	PROFILE ELEVATION	-----
RAILROADS	-----	STREAM or CREEK	-----

GROSS LENGTH OF PROJECT	5,195.19	FT.
EXCEPTIONS	0.00	FT.
ADDITIONS	0.00	FT.
NET LENGTH OF PROJECT	5,195.19	FT. 0.984 MILES
NET LENGTH OF BRIDGES	102.94	FT. 0.019 MILES
NET LENGTH OF ROAD	5,092.25	FT. 0.889 MILES

NOTE: ONE LANE NORTH BOUND TRAFFIC TO BE CARRIED THROUGH CONSTRUCTION. LOCAL TRAFFIC WILL BE PERMITTED TO ADJACENT PROPERTIES.

NOTE: THE PIPES ON THIS PROJECT ARE IN ACCORDANCE WITH THE CURRENT KDOT PIPE POLICY.

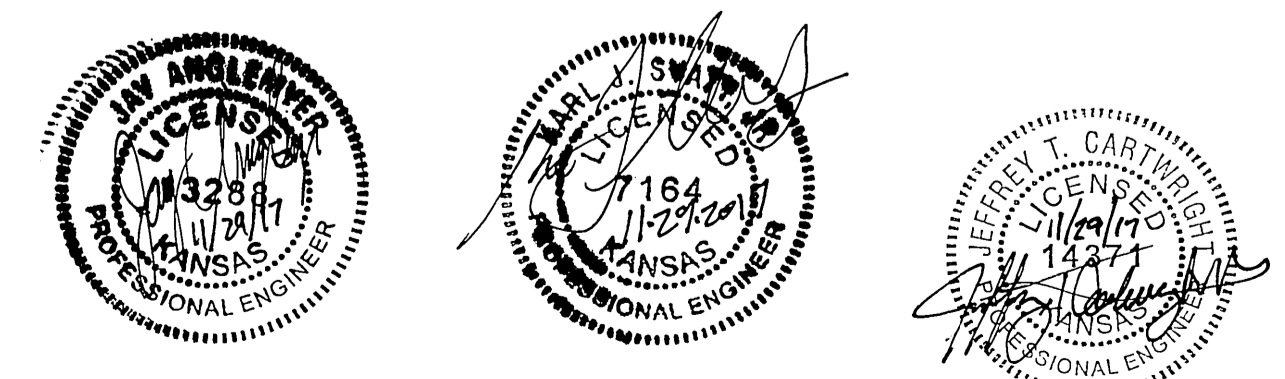

APPROVED - DATE
 Gary Janzen 11/30/17
 GARY JANZEN, P.E.
 CITY ENGINEER

STREET IMPROVEMENTS FOR
127TH STREET EAST
 FROM 13TH STREET NORTH TO 21ST STREET NORTH

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TITLE SHEET

PROJECT NO.	472-85158	
DATE	11/29/17	
SCALE	1"=300'	
DESIGNED	JRA	
DRAWN	DM	
CHECKED	JRA	
NO.	REVISION	DATE
SHEET NO.		
1 OF 183		