





SCALE: 1" = 40'
0 40

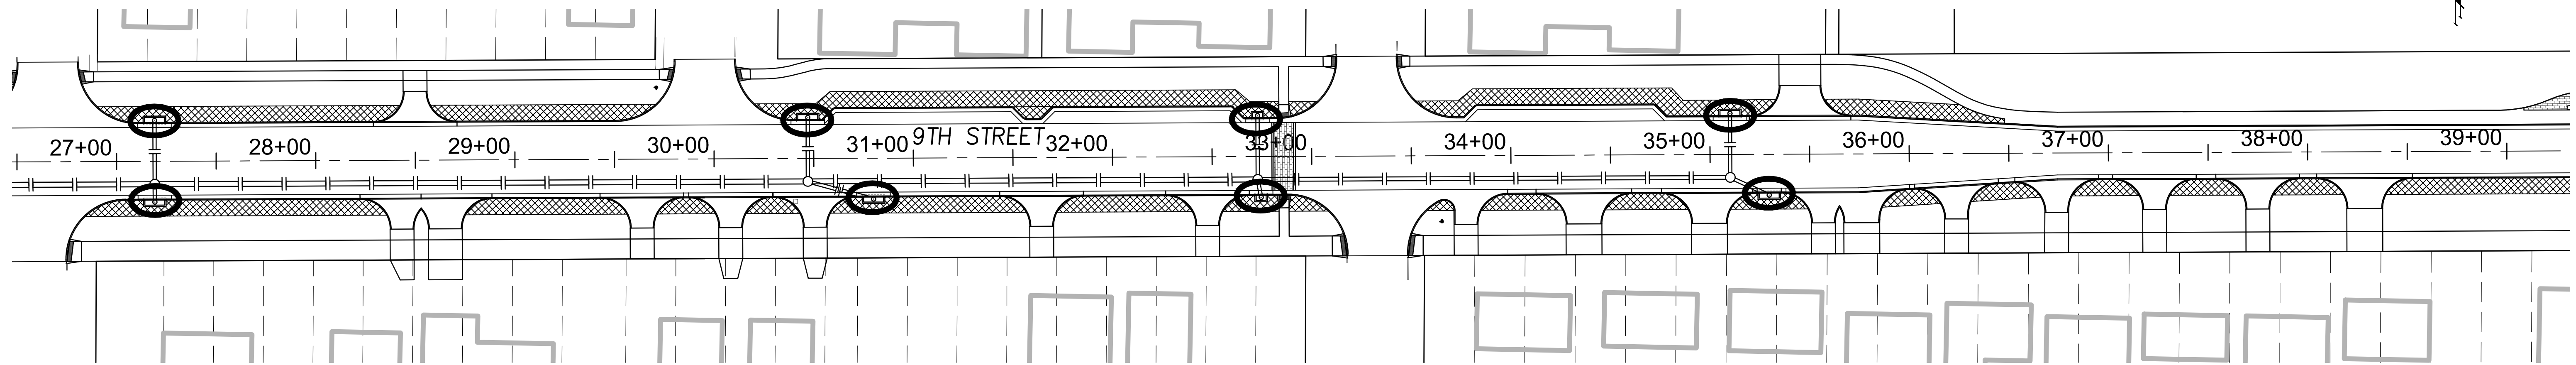

SCALE: 1" = 40'
0 40

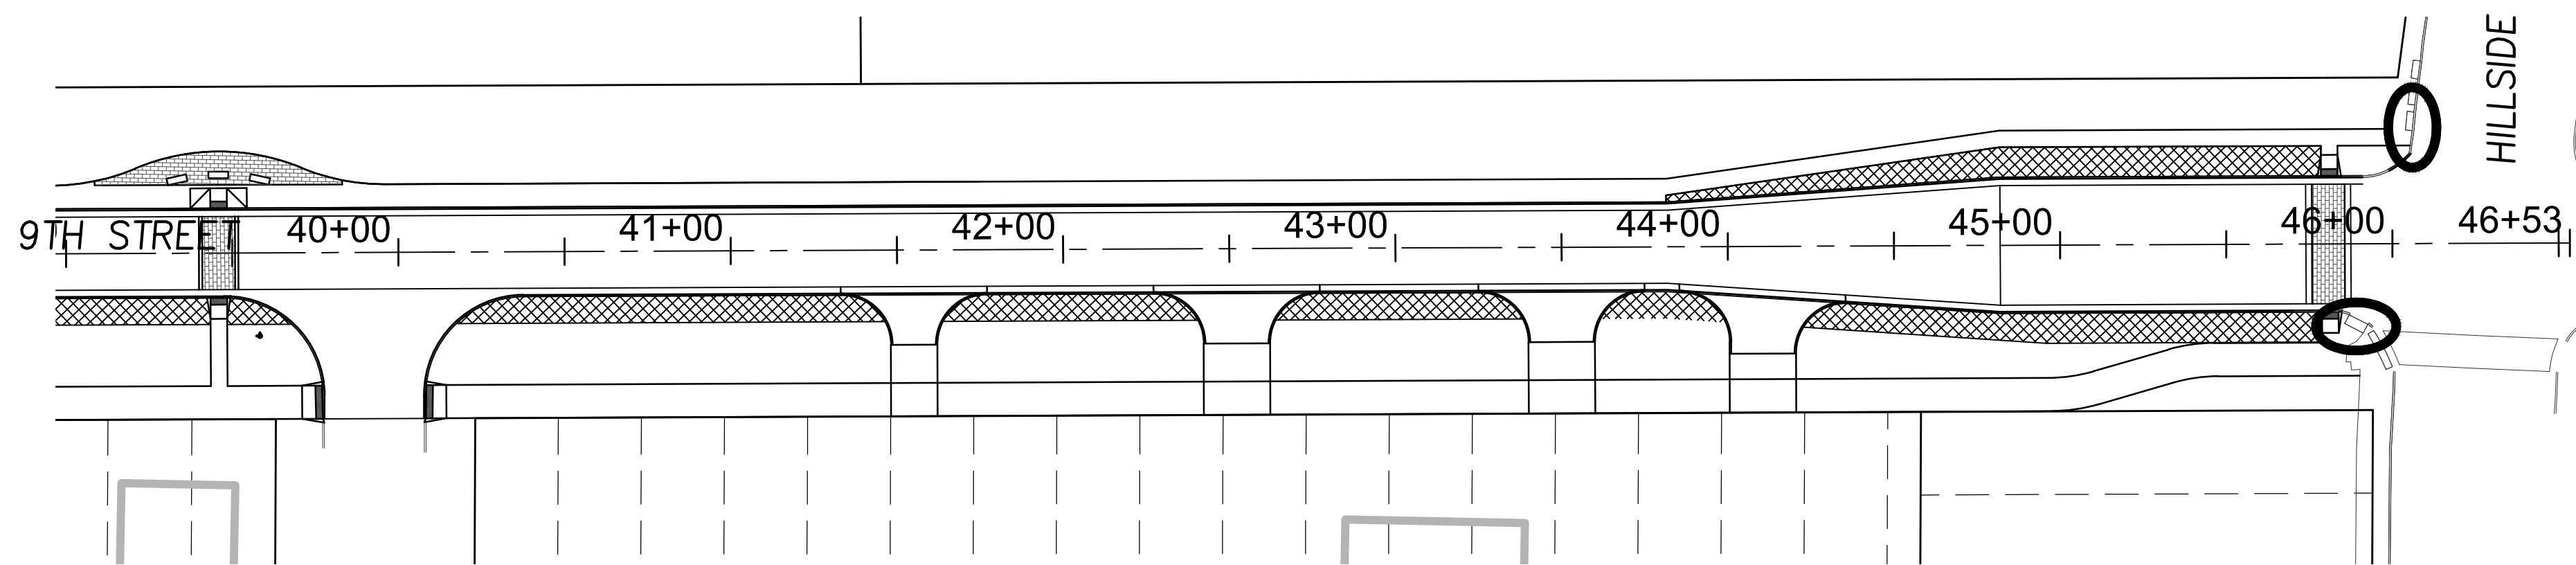

EROSION CONTROL QUANTITIES	
EROSION CONTROL MEASURE	QUANTITIES
BACK OF CURB PROTECTION (LF)	8,210
CONSTRUCTION ENTRANCE (EA)	2
CURB INLET PROTECTION (EA)	31
DROP INLET PROTECTION (EA)	1
DITCH CHECKS (EA)	-
SILT FENCE (LF)	150
RIP-RAP (SY)	-

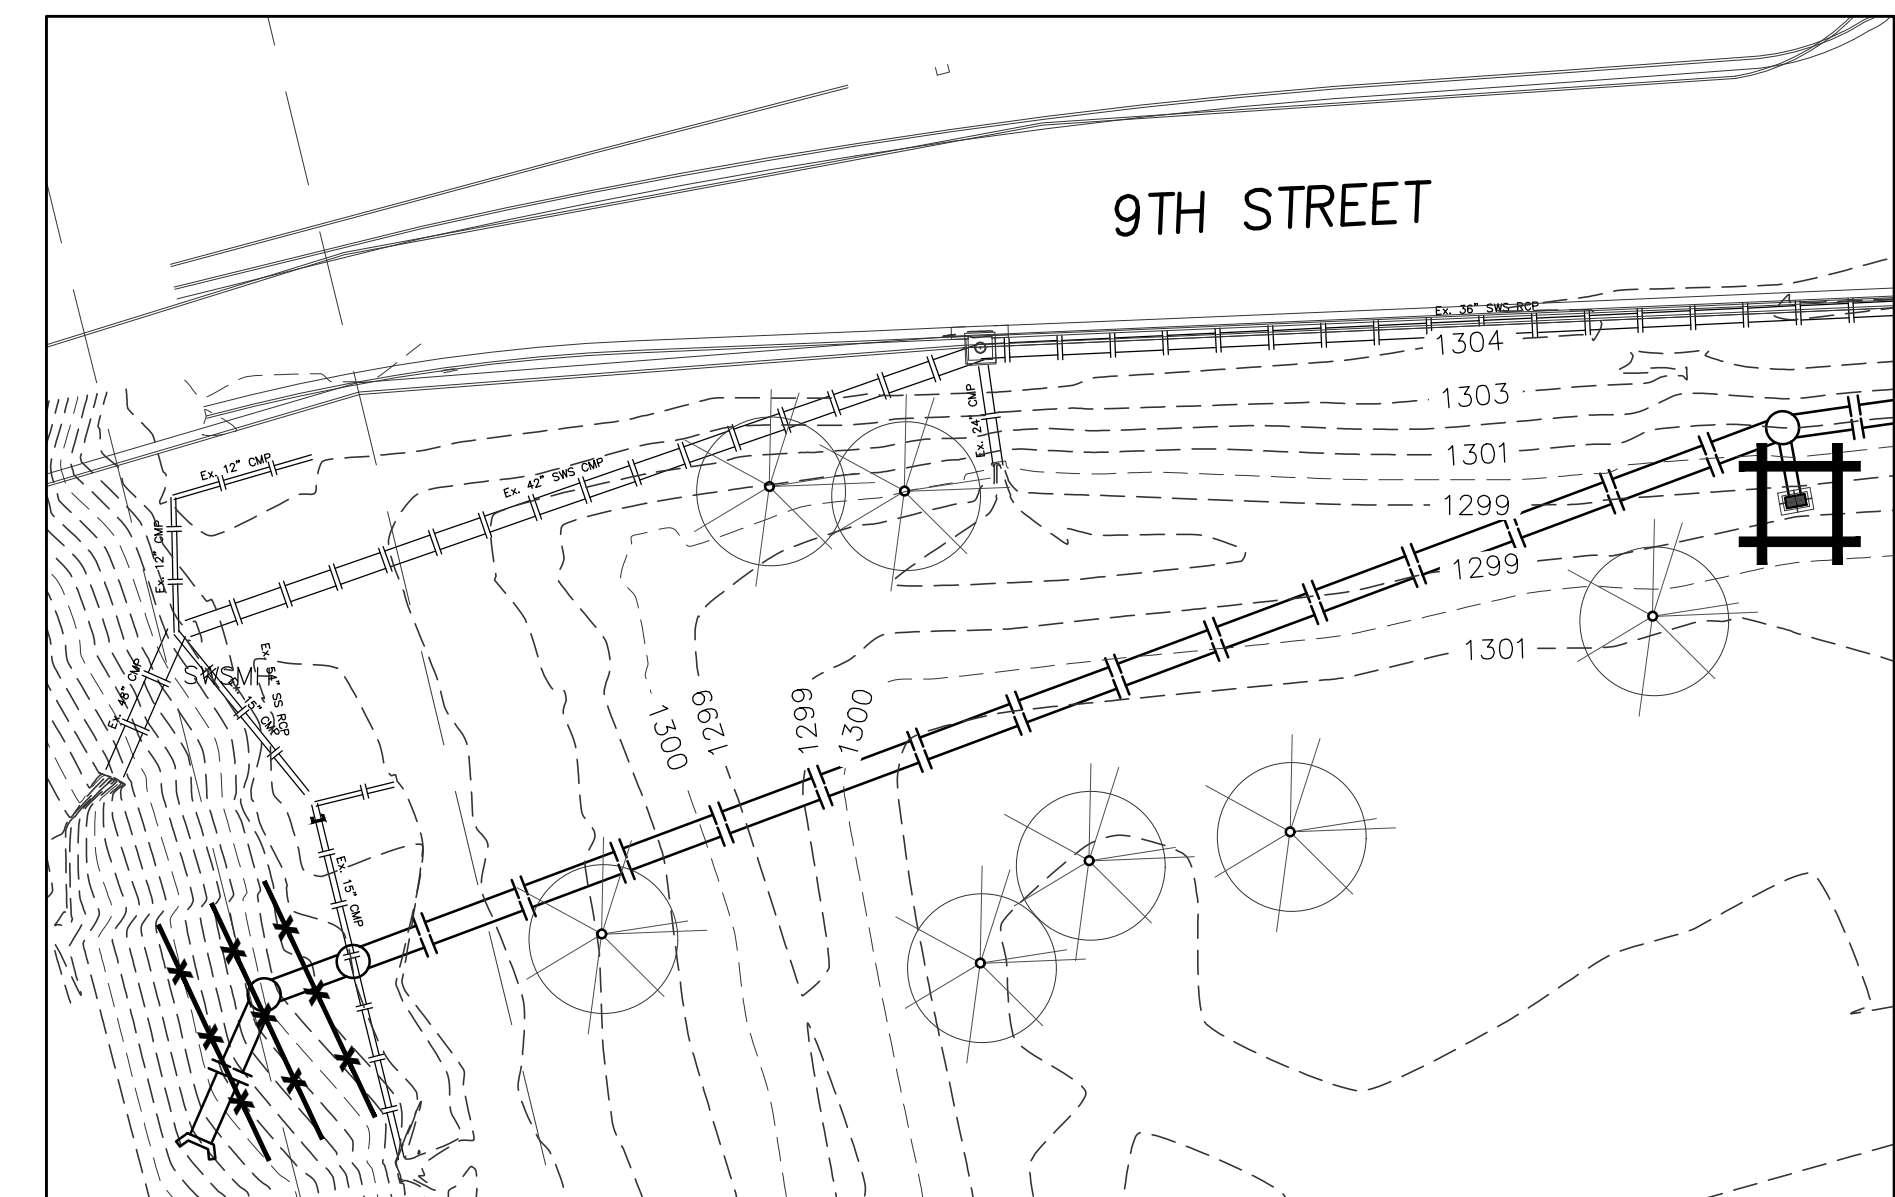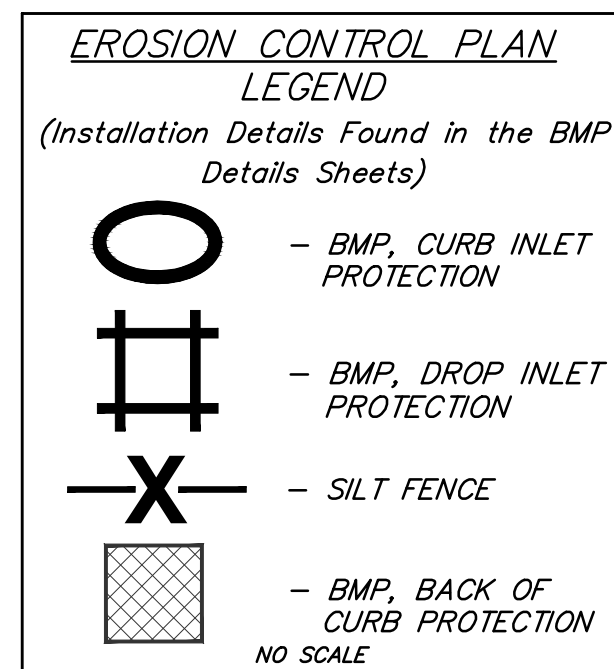

SWS LINE 1 - OUTFALL
1" = 40'

EROSION CONTROL PLAN
1" = 40'

Drawing File: E:\Projects\9th Street Corridor_16-02-E407\Civil 3D\Basemap
Design: LP
Drawn: LP
Approved: T Alieri
Scale: NOTED

Project No. 16-02-E407 CAPITAL IMPROVEMENT PROJECT
9TH STREET
EROSION CONTROL PLAN
9TH STREET (H315 to HILLSIDE)

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315 Ellis St. Wichita, KS 67211 P 316-262-7271 F 316-262-0149
ENGINEERING | SURVEYING | PLANNING | LANDSCAPE ARCHITECTURE

September, 2017
SHEET **62**
OF 110