

PLOTTED: Wednesday, May 02, 2018 @ 02:00PM

J:\PROJECTS\2017\1010567_COW_STRYKER_L170567_CAD\SH1510 BLOG MEP\SITE LIGHTING PACKAGE\170567-08-0101-04 ELECTRICAL SITE LIGHTING PLAN.DWG

FIXTURE LEGEND	
	SINGLE ARM FIXTURE.
	DOUBLE ARM FIXTURE AT 0° AND 180°.
	PEDESTRIAN FIXTURE.
	FLAG POLE FIXTURE.

GENERAL NOTES	
1.	EXISTING CONDITIONS SHOWN ON THE DRAWINGS WERE TAKEN FROM ORIGINAL DOCUMENTS AND FIELD OBSERVATIONS. THIS CONTRACTOR SHALL BE RESPONSIBLE FOR VERIFICATION OF EXISTING CONDITIONS. E.C. SHALL VISIT THE JOBSITE PRIOR TO BID AND VERIFY ALL EXISTING CONDITIONS.
2.	UPON COMPLETION OF PROJECT, E.C. SHALL PROVIDE A FULL TYPED AND UPDATED PANEL DIRECTORY FOR EACH PANELBOARD AFFECTED BY THE SCOPE OF THIS PROJECT.
3.	FEEDER ROUTING INDICATED ON THE DRAWINGS DOES NOT INDICATE NEC CODE REQUIRED PULL BOXES. E.C. SHALL BE RESPONSIBLE FOR LOCATING AND INSTALLING REQUIRED PULL BOXES FOR EACH FEEDER.


HATCH LEGEND	
	AREA NOT COVERED ON THIS SHEET.

KEYED NOTES	
1.	REFER TO DETAIL 2/87 FOR POLE BASE DETAIL.
2.	REFER TO DETAIL 1/87 FOR POLE BASE DETAIL.
3.	EXISTING PANEL TO BE REMOVED. DISCONNECT ALL CONDUITS AND CONDUCTORS AND REMOVE TO BELOW GRADE.
4.	PROVIDE 120V POWER TO LIGHTING CONTROL PANEL 'LC-1'.
5.	WESTAR TO RELOCATE EXISTING MEDIUM VOLTAGE CABINET AT THIS LOCATION.
6.	ROUTE CIRCUIT THROUGH LIGHTING CONTACTOR 'LC-1'. SEE DETAIL 4/87.
7.	PROVIDE NEW PANELBOARD 'SL1' AND LIGHTING CONTROLLER 'LC-1' IN NEW PEDESTAL PER DETAILS 3/87 AND 5/87
8.	WESTAR TO REMOVE EXISTING MEDIUM VOLTAGE CABINET FOR RELOCATION.

FEEDER SCHEDULE	
(A)	PROVIDE (2)-#10, (1)-#10 GND IN EXISTING 1" CONDUIT FOR LIGHTING.





PAVING, LANDSCAPE & UTILITIES FOR
STRYKER SPORTS
WICHITA, KANSAS

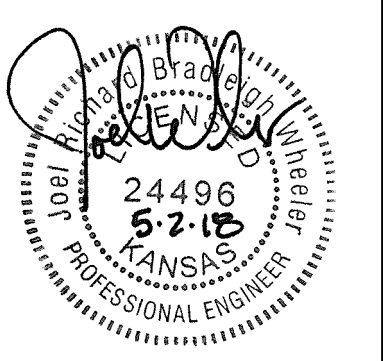

©2018 MKEC Engineering All Rights Reserved www.mkec.com
These drawings and their contents, including, but not limited to, all concepts, designs, & ideas are the exclusive property of MKEC Engineering (MKEC), and may not be used or reproduced in any way without the express consent of MKEC.

ELECTRICAL SITE PLAN - AREA A	
PROJECT NO.	1701010567
DATE	MAY 2, 2018
SCALE	1"=50'-0"
DESIGNED	CNG
DRAWN	ECW
CHECKED	JRBW
ISSUED FOR CONST. NO.	05-02-18
REVISION	DATE
SHEET NO. 83 OF 102	

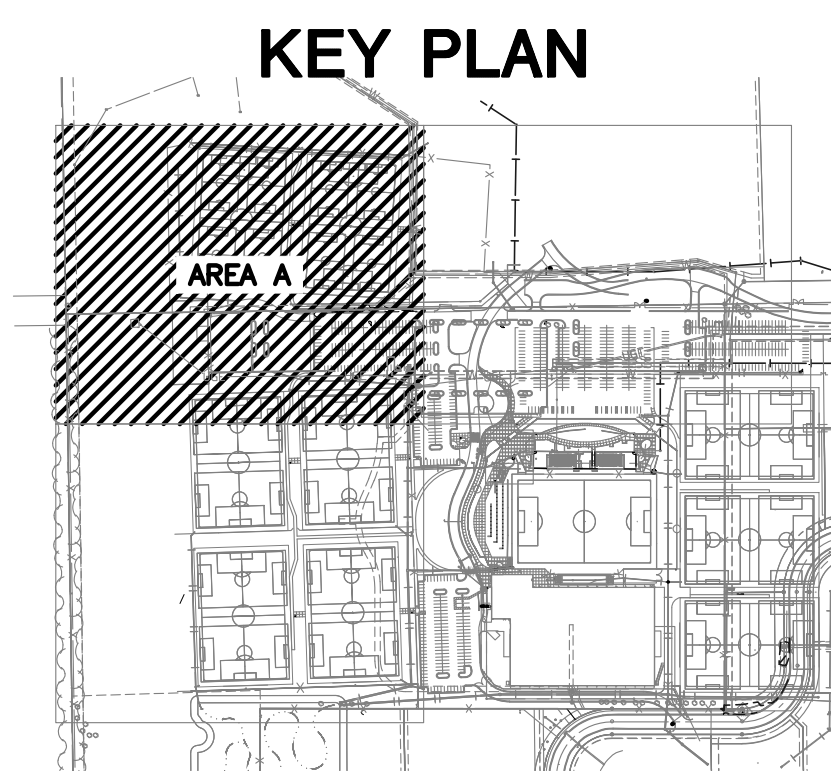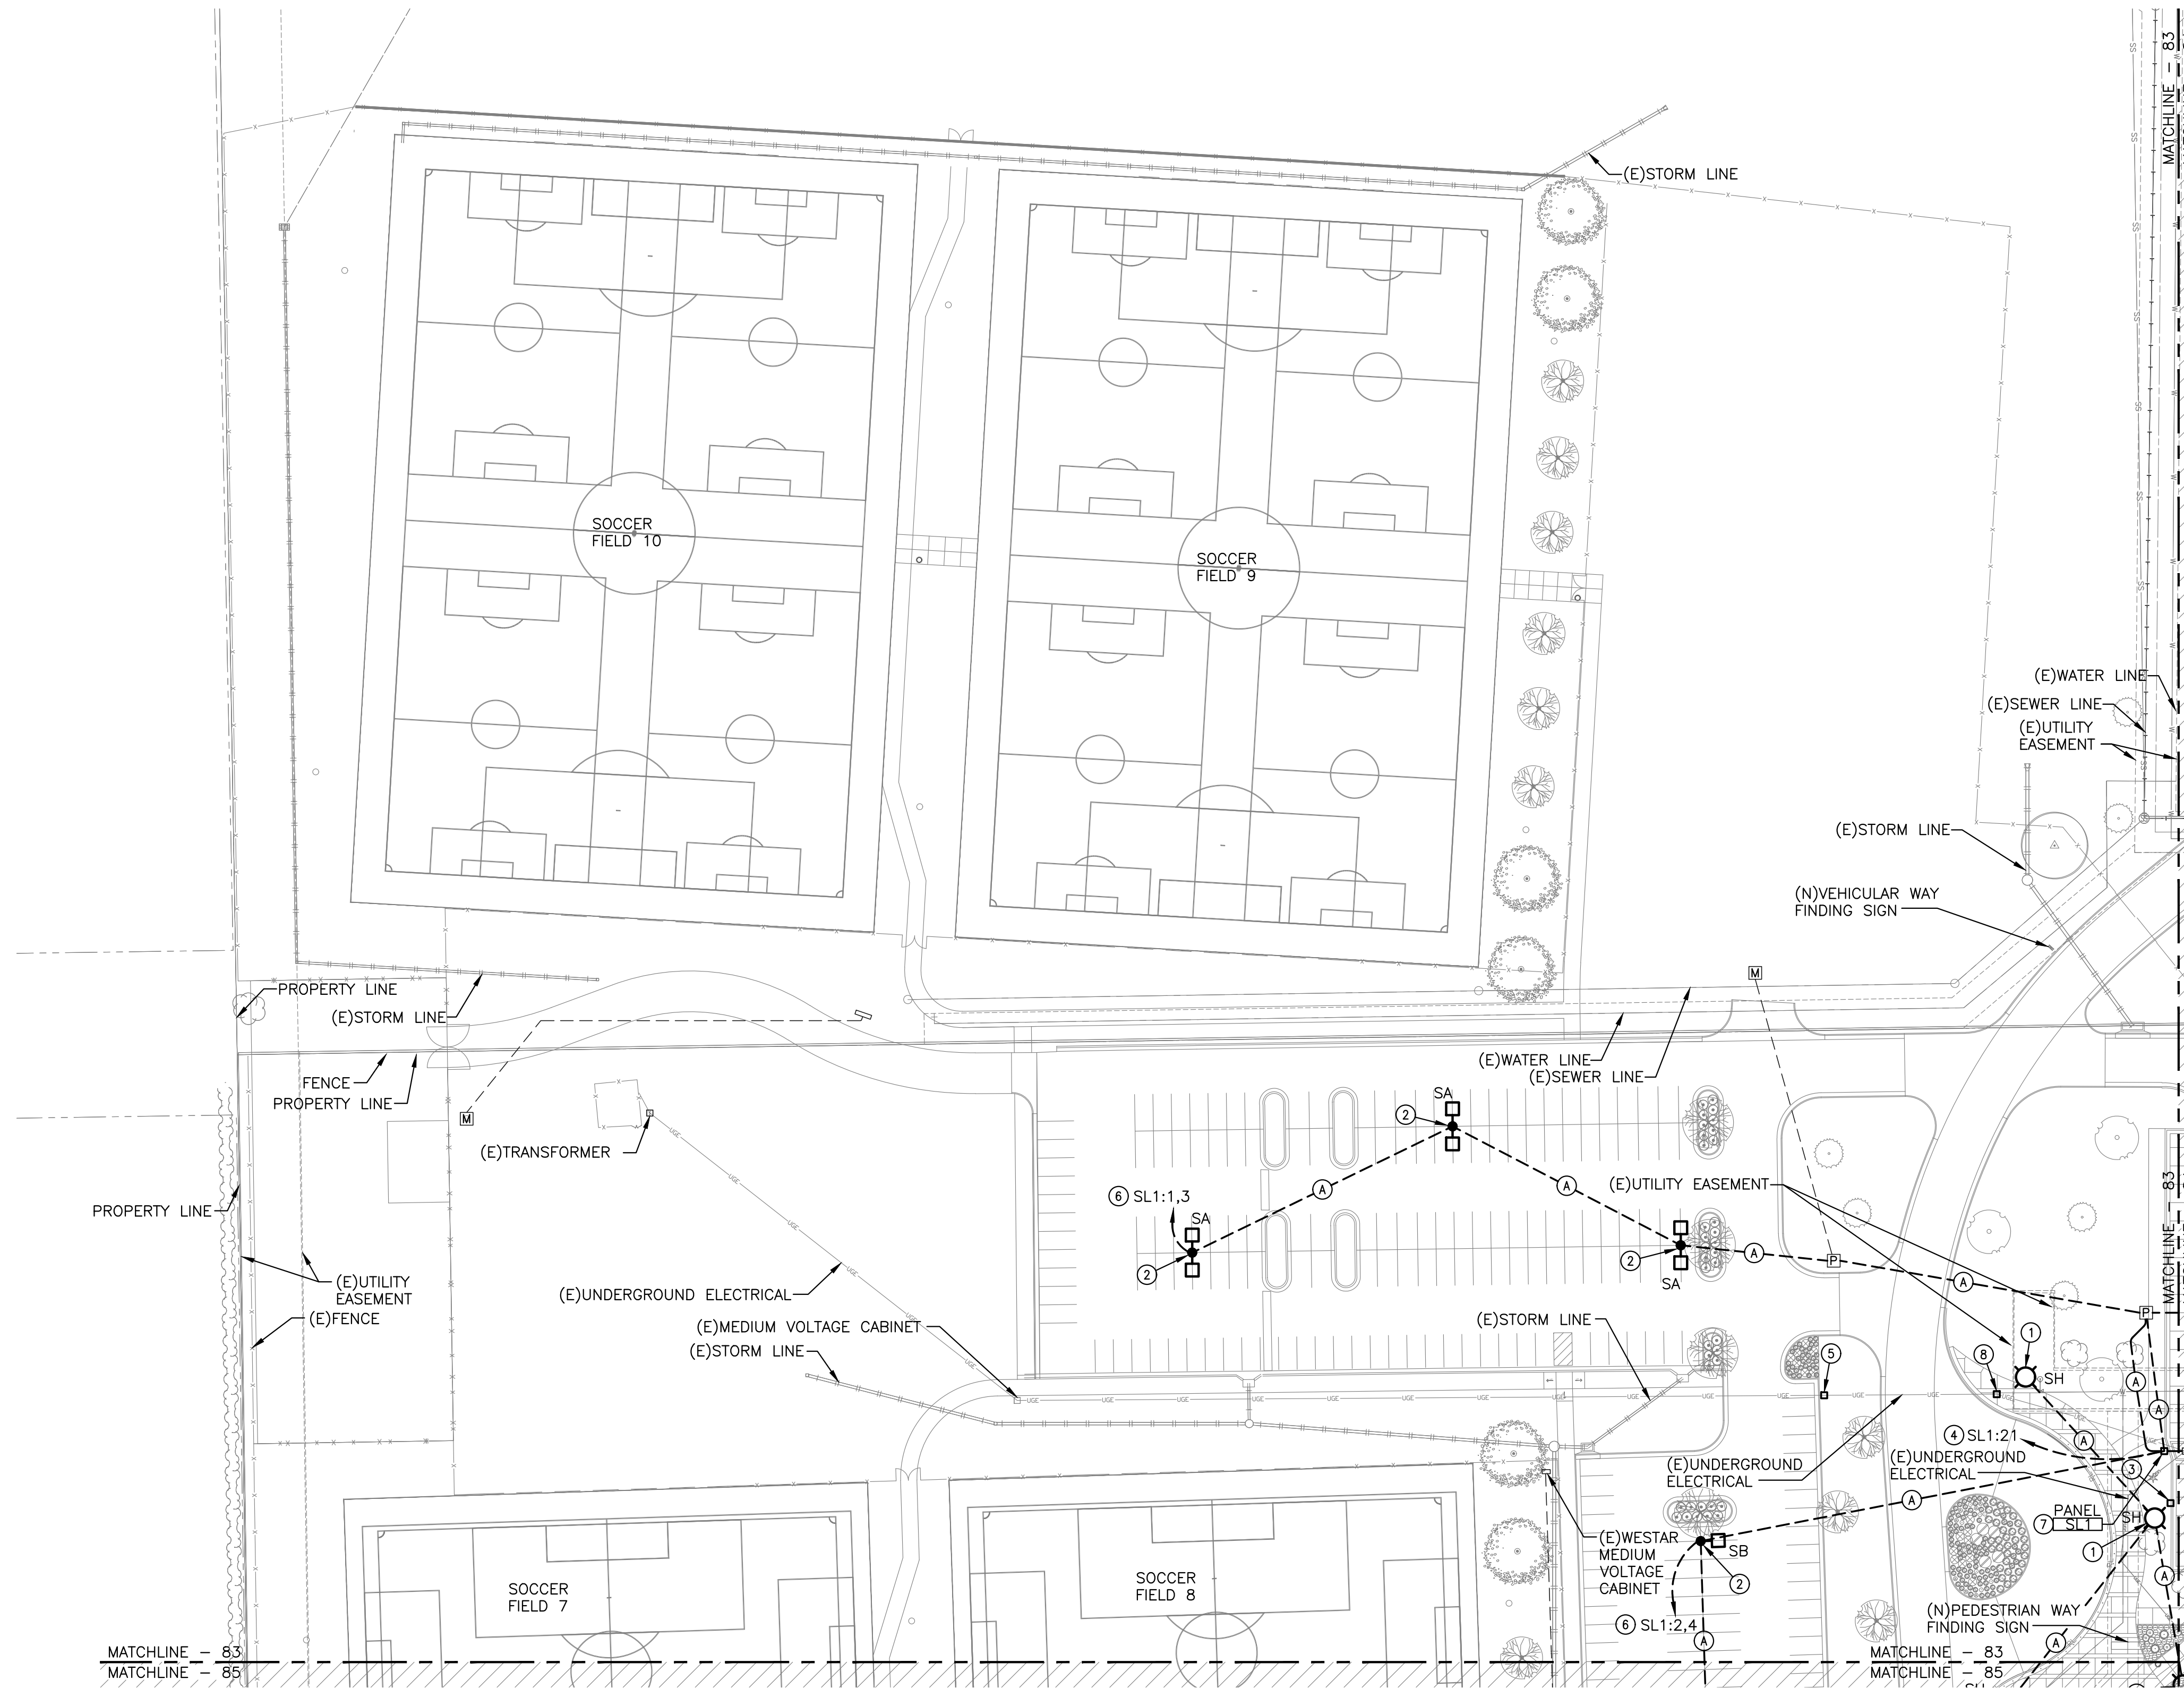

ELECTRICAL SITE PLAN - AREA A
SCALE: 1" = 50'-0"