




5 LIGHTING PLAN - WEST ABUTMENT
 SCALE: 1" = 20'-0"

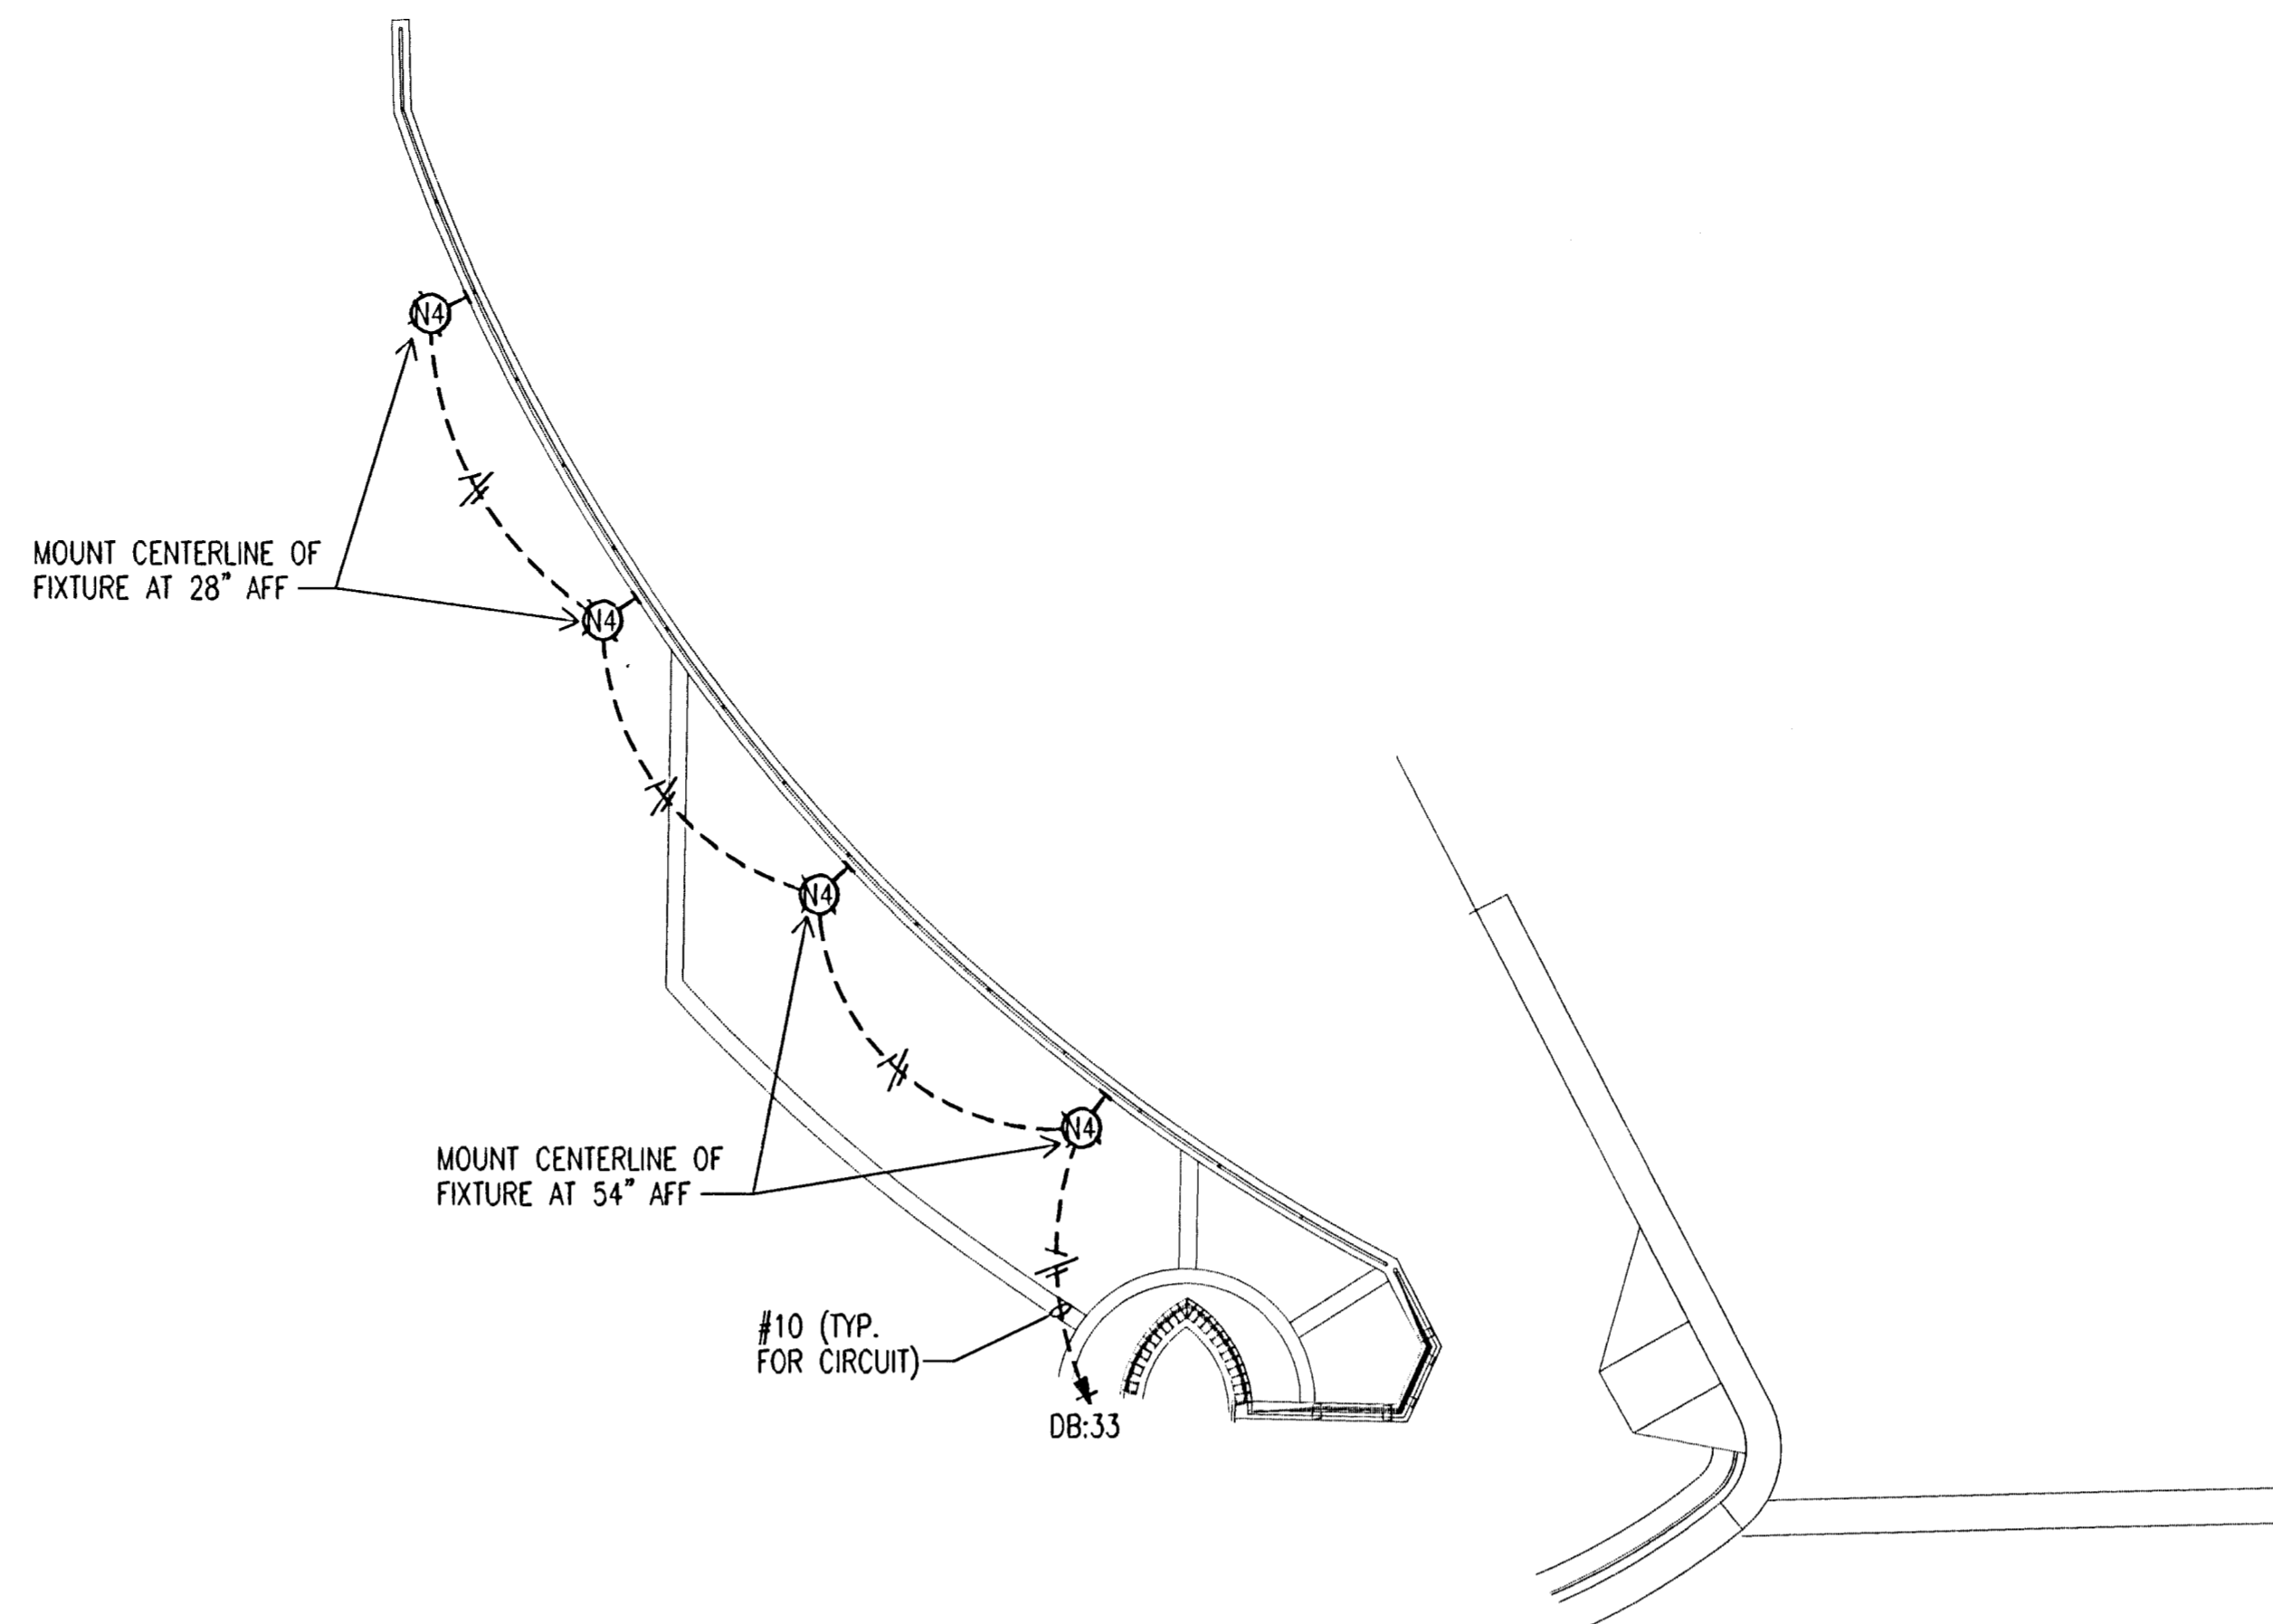

2 LIGHTING PLAN - NORTHEAST RETAINING WALL
 SCALE: 1" = 10'-0"

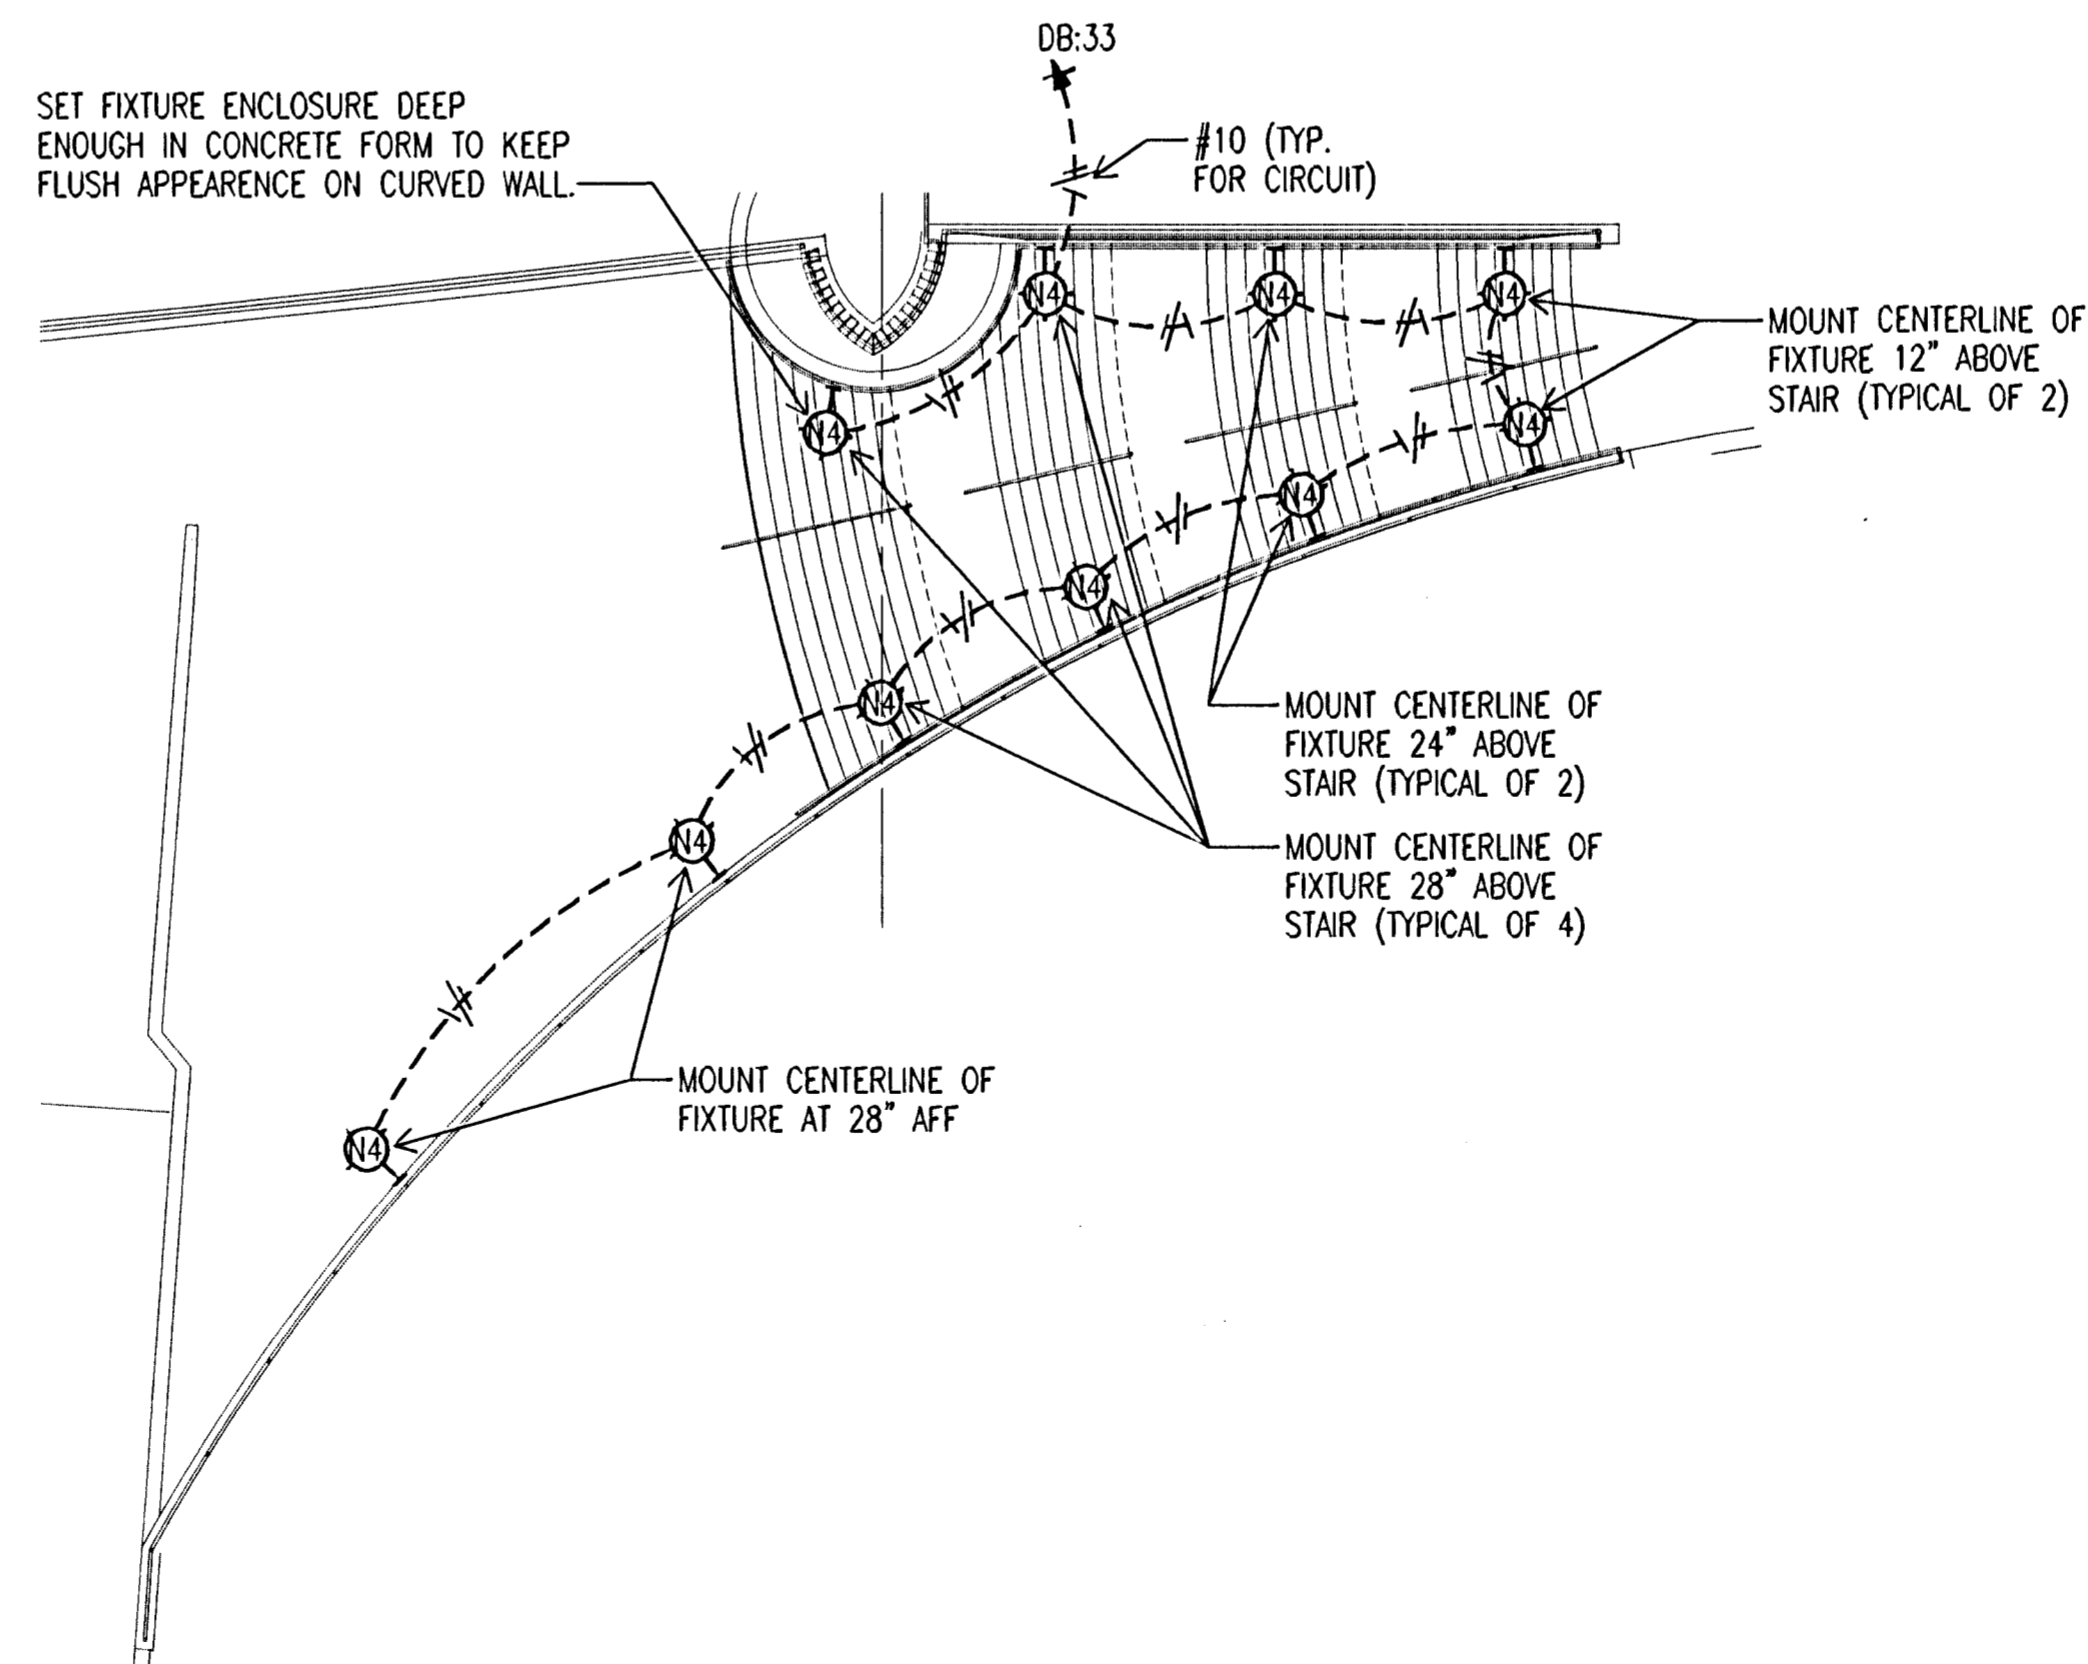


3 LIGHTING PLAN - SOUTHEAST STAIR
 SCALE: 1" = 10'-0"

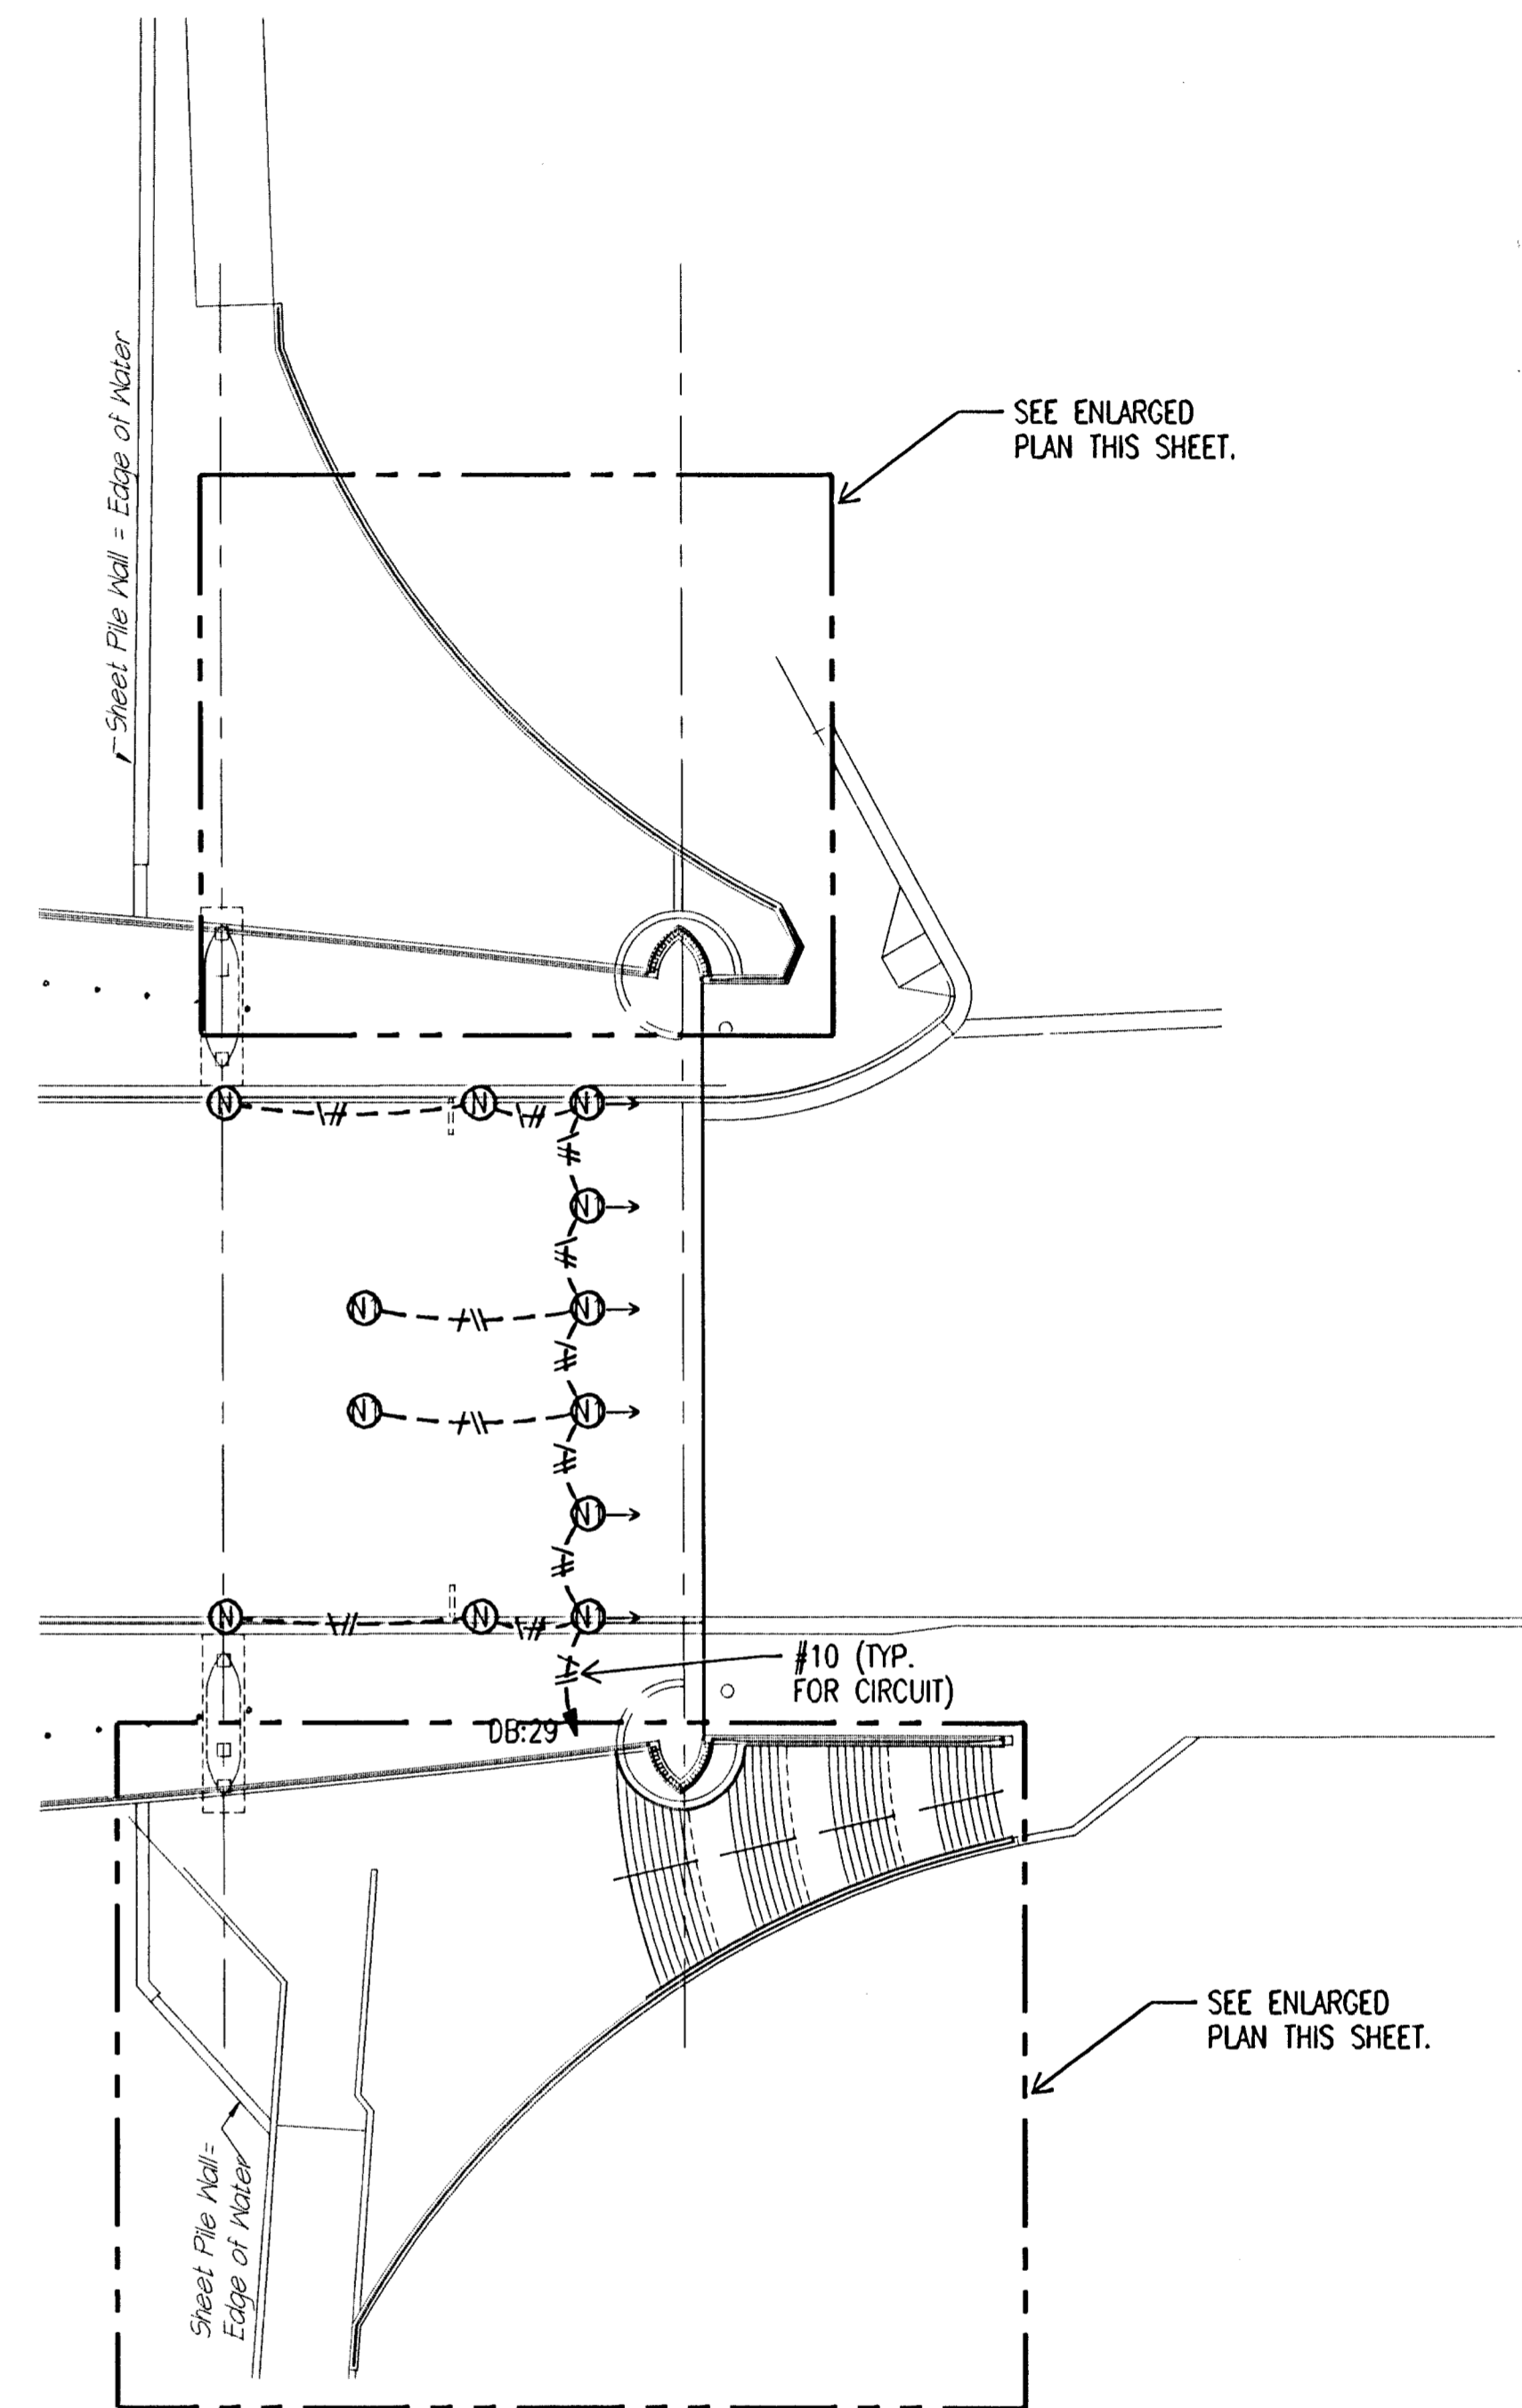

1 LIGHTING PLAN - EAST STAIR
 SCALE: 1" = 20'-0"

PLAN	DATE
SURVEYED	
PLOTTED	
ALIGNMENT CHECKED	
RT. OF WAY CHECKED	
NOTE BOOK NO.	
BY	

DSNR: DCG OPER. TRK SCALE: 1=240.00
 E:\1995\95088\004\DSBE4 11-17-1997 11:11:34 am

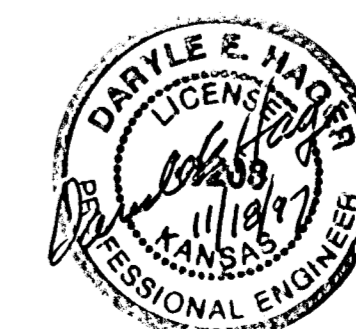

CITY OF WICHITA, KANSAS
 MICHAEL E. LINDEBAK, P.E. - CITY ENGINEER
 DOUGLAS AVENUE BRIDGE
 OVER ARKANSAS RIVER

ELECTRICAL SITE PLAN

CITY OF WICHITA PROJECT NO. 472-82721

PROFESSIONAL ENGINEERING CONSULTANTS, P.A.
 ENGINEERS
 WICHITA, KANSAS

Designed by	DCG	Checked by	DCG
Drawn by	MOB	Date	SEPT. 1997
		Job No.	95088-4