


FHWA REG NO.	STATE	PROJECT NO.	YEAR	SHEET NO.	TOTAL SHEETS
7	KANSAS	87 TE-0156-01	2000	1	6

STATE OF KANSAS  
DEPARTMENT OF TRANSPORTATION

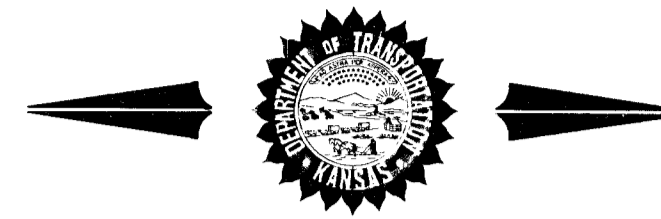

PLAN AND PROFILE OF PROPOSED  
**THIRD STREET DRAINAGE ENHANCEMENT**

PEDESTRIAN BRIDGES OVER THE  
THIRD STREET DRAINAGE CHANNEL

FEDERAL AID PROJECT  
CITY OF WICHITA PROJECT NO. 472-83181 (OCA 785012)



WICHITA, SEDGWICK COUNTY

GRADING  
BRIDGE  
SEEDING

INDEX OF SHEETS

SHEET NO.	DESCRIPTION
1	Title Sheet
2	General Notes
3	Plan and Profile Bridge #1
4	Plan and Profile Bridge #2
5	Plan and Profile Bridge #3
6	Erosion/Sediment Control Details

DATE	
BY	
SURVEYED	
CAD TECHNICIAN	
DESIGNERS	
SQUAD	

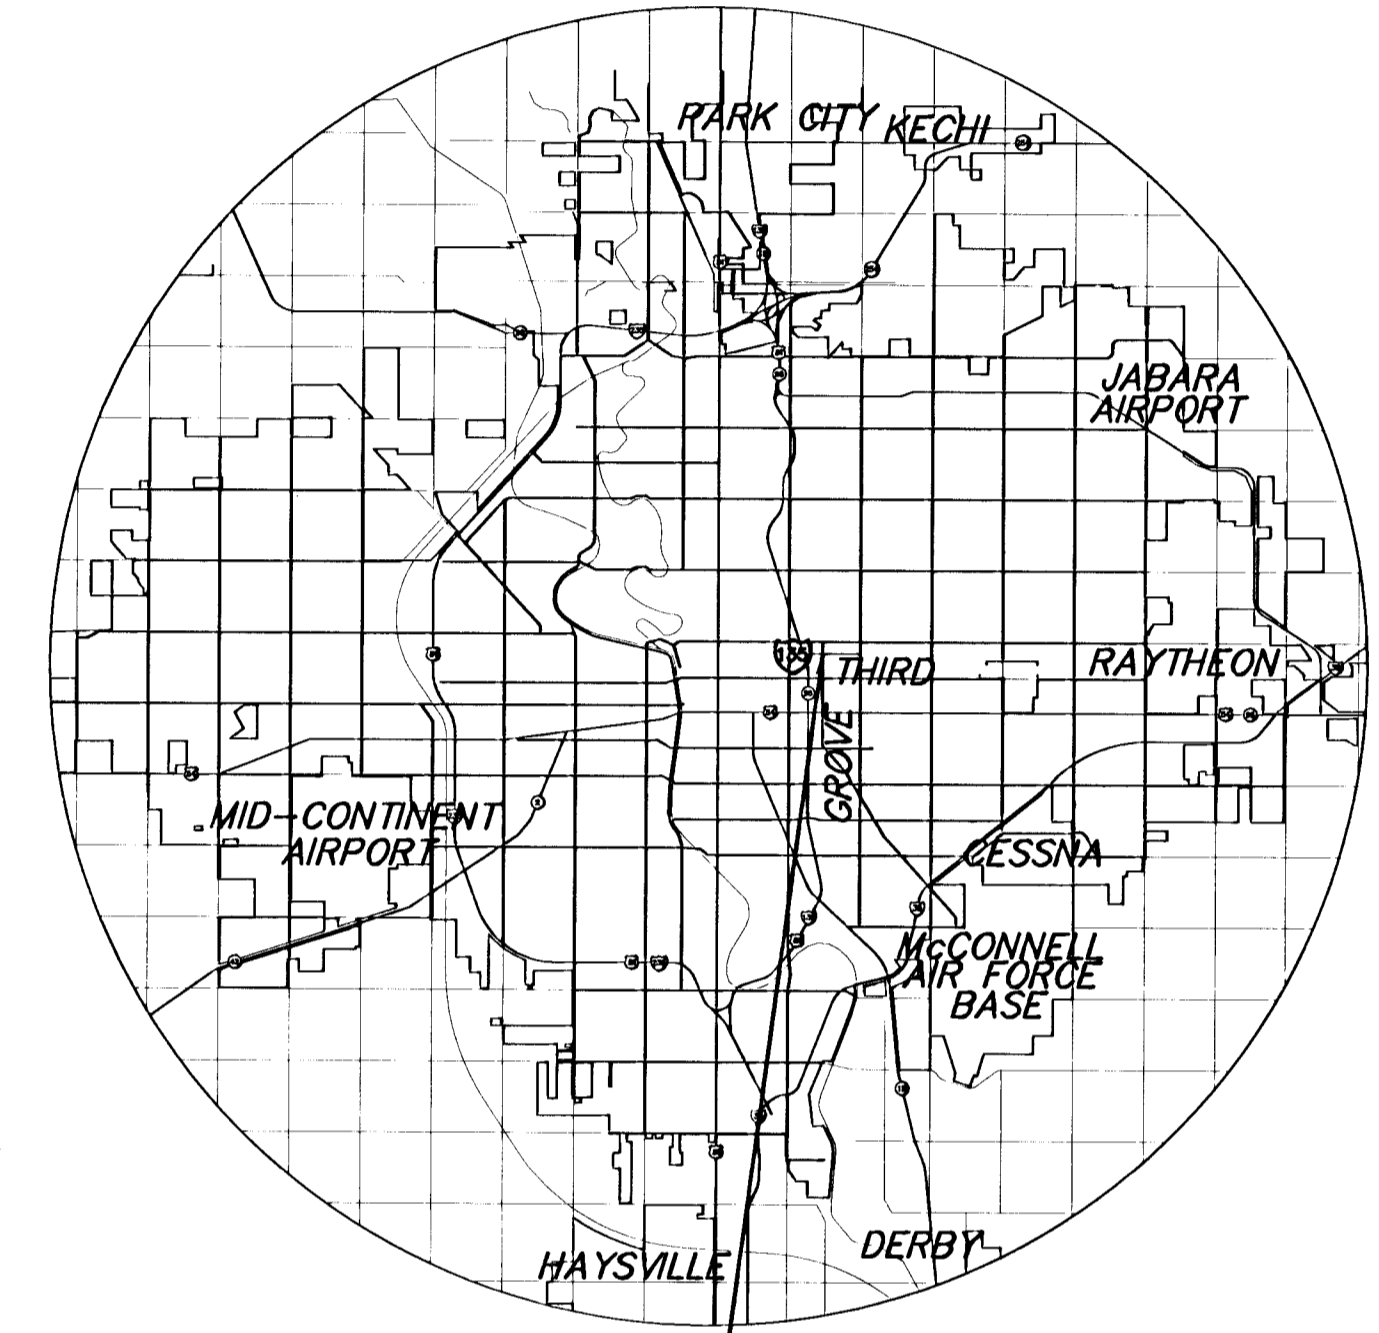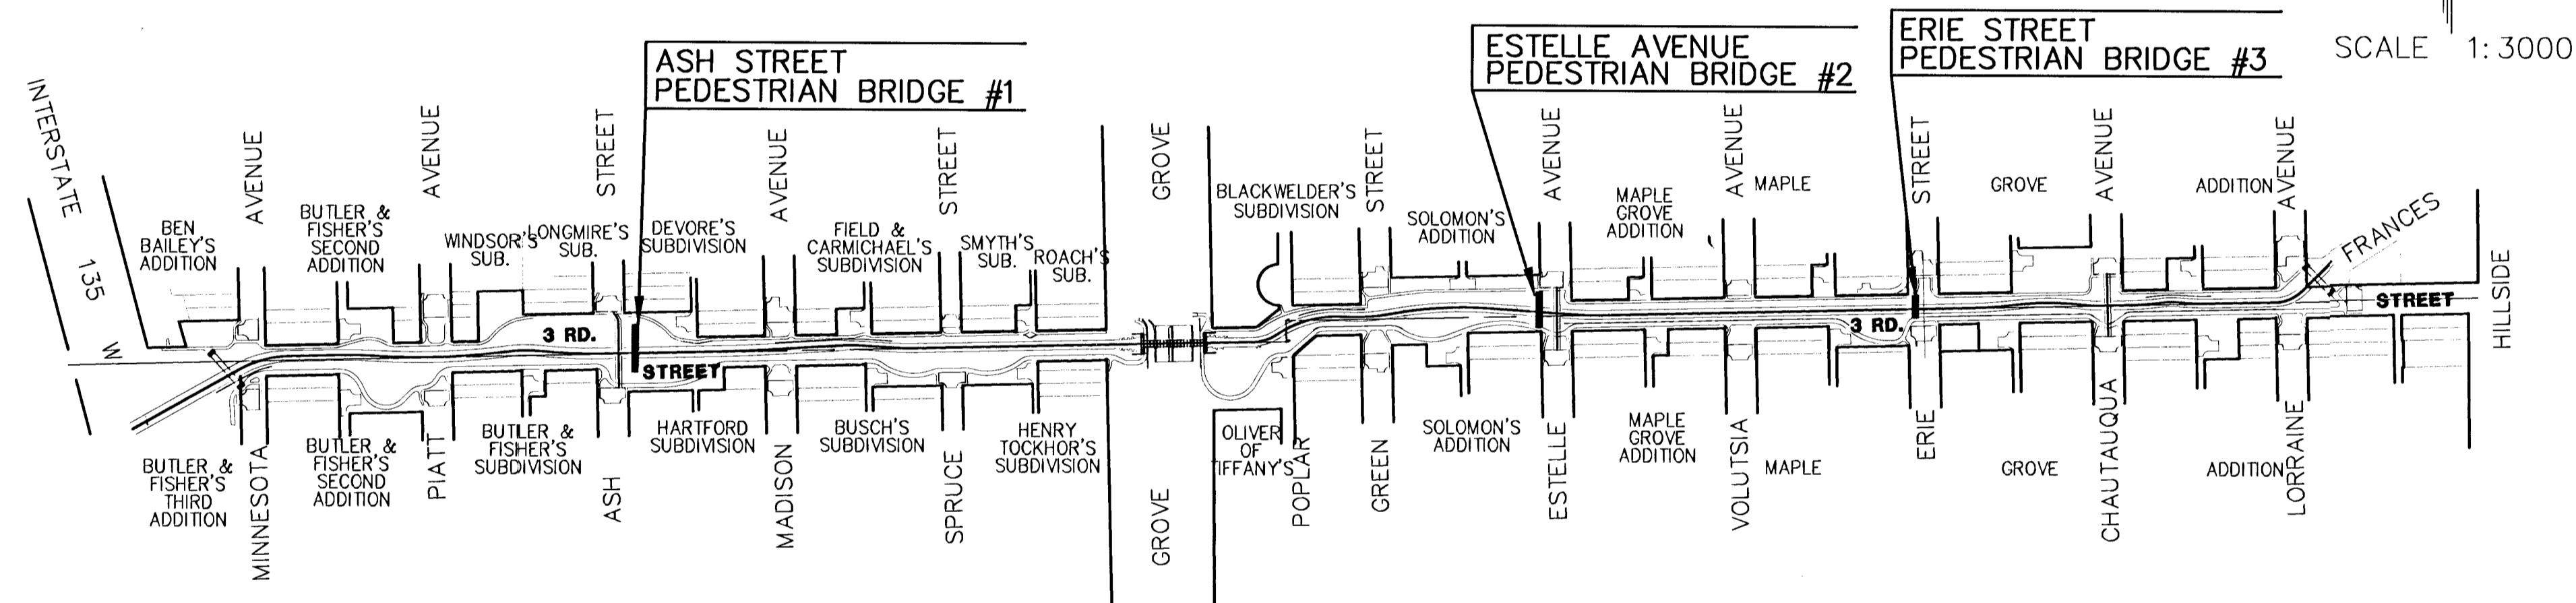

PROJECT LOCATION

SCALE 1:3000

CONVENTIONAL SIGNS

COUNTY LINE	-----	CENTER LINE OF PROJECT	-----
CITY LIMITS	-----	TERRACE	-----
STATE OR NATIONAL LINE	-----	CULVERTS	-----
TOWNSHIP, SECTION or GRANT LINE	-----	DROP INLET & STORM SEWER	-----
PROPERTY LINE	-----	ACCESS CONTROL	-----
HIGHWAY FENCE	-----	POWER POLE	-----
EXISTING FENCE	-----	TELEPHONE POLE	-----
GUARD FENCE	-----	MARSH	-----
CONSTRUCTION LIMITS	-----	HEDGE	-----
RIGHT OF WAY LINE	-----	TREES	-----
TRAVELED WAY	-----	PROFILE ELEVATION	-----
RAILROADS	-----	STREAM or CREEK	-----

GROSS LENGTH OF PROJECT	64.100 m
EXCEPTIONS	0 m
ADDITIONS	0 m
NET LENGTH OF PROJECT	64.100 m
NET LENGTH OF BRIDGES	64.100 m
NET LENGTH OF ROAD	0 m



PREPARED & SUBMITTED BY  
MKEC ENGINEERING CONSULTANTS, INC.  
WICHITA, KANSAS

All Dimensions shown, without a SI suffix, are in millimeters. All elevations shown are in meters.

RECOM. FOR APPROVAL-DATE

APPROVED - DATE

MICHAEL E. LINDEBAK  
CITY ENGINEER  
PROJECT NO. 87 N-0089-01

DESIGN DIVISION OF M.A.P.D.  
WICHITA, KANSAS

RECOM. FOR APPROVAL-DATE

APPROVED - DATE

STATE TRANSPORTATION ENGINEER  
KANSAS DEPARTMENT OF TRANSPORTATION

RECOM. FOR APPROVAL-DATE

APPROVED - DATE

ENGINEER  
FEDERAL HIGHWAY ADMINISTRATION  
DEPARTMENT OF TRANSPORTATION

DIVISION ADMINISTRATOR  
FEDERAL HIGHWAY ADMINISTRATION  
DEPARTMENT OF TRANSPORTATION

Drawn By:	
DGN File:	
Plotted:	
View=	