

| FHWA REGION NO. | STATE | PROJECT NO. | YEAR | SHEET NO. | TOTAL SHEETS |
|-----------------|--------|-------------|------|-----------|--------------|
| 7 | KANSAS | 87N 0064-01 | 1997 | 1 | 130 |

INDEX OF SHEETS

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**STATE OF KANSAS
DEPARTMENT OF TRANSPORTATION**





**PLAN AND PROFILE OF PROPOSED
FEDERAL AID PROJECT
SOUTH SENECA STREET
HASKELL AVENUE NORTH TO IRVING
87N 0064-01
FEDERAL AID PROJECT NO. CMQ - N006(401)
WICHITA, SEDGWICK COUNTY**

F.A. NO. CMQ-N006(401)

- GRADING
- STORM SEWER
- CONCRETE PAVING
- SIGNALIZATION
- PAVEMENT MARKINGS
- SODDING
- LANDSCAPING

| DATE | BY |
|------|------------------|
| 1995 | LOWRY |
| 1995 | LOWRY |
| 1995 | FERGUSON, JACOBS |
| 1995 | SELLERS |
| 1995 | MKEC |

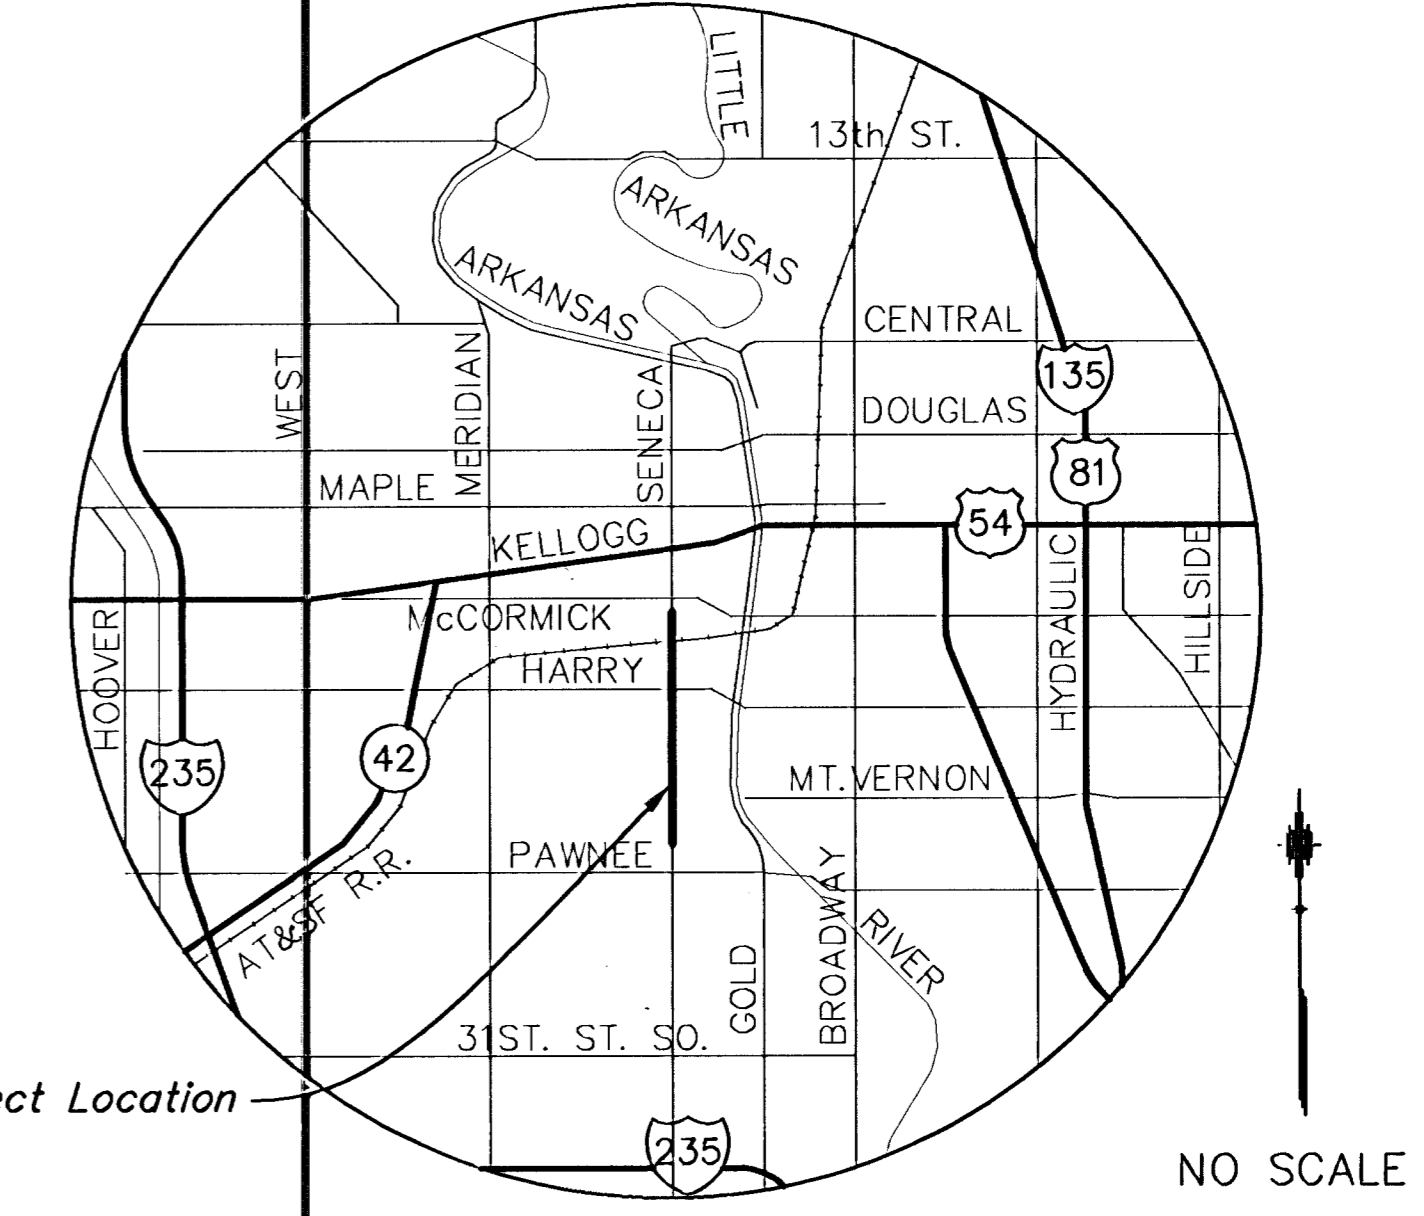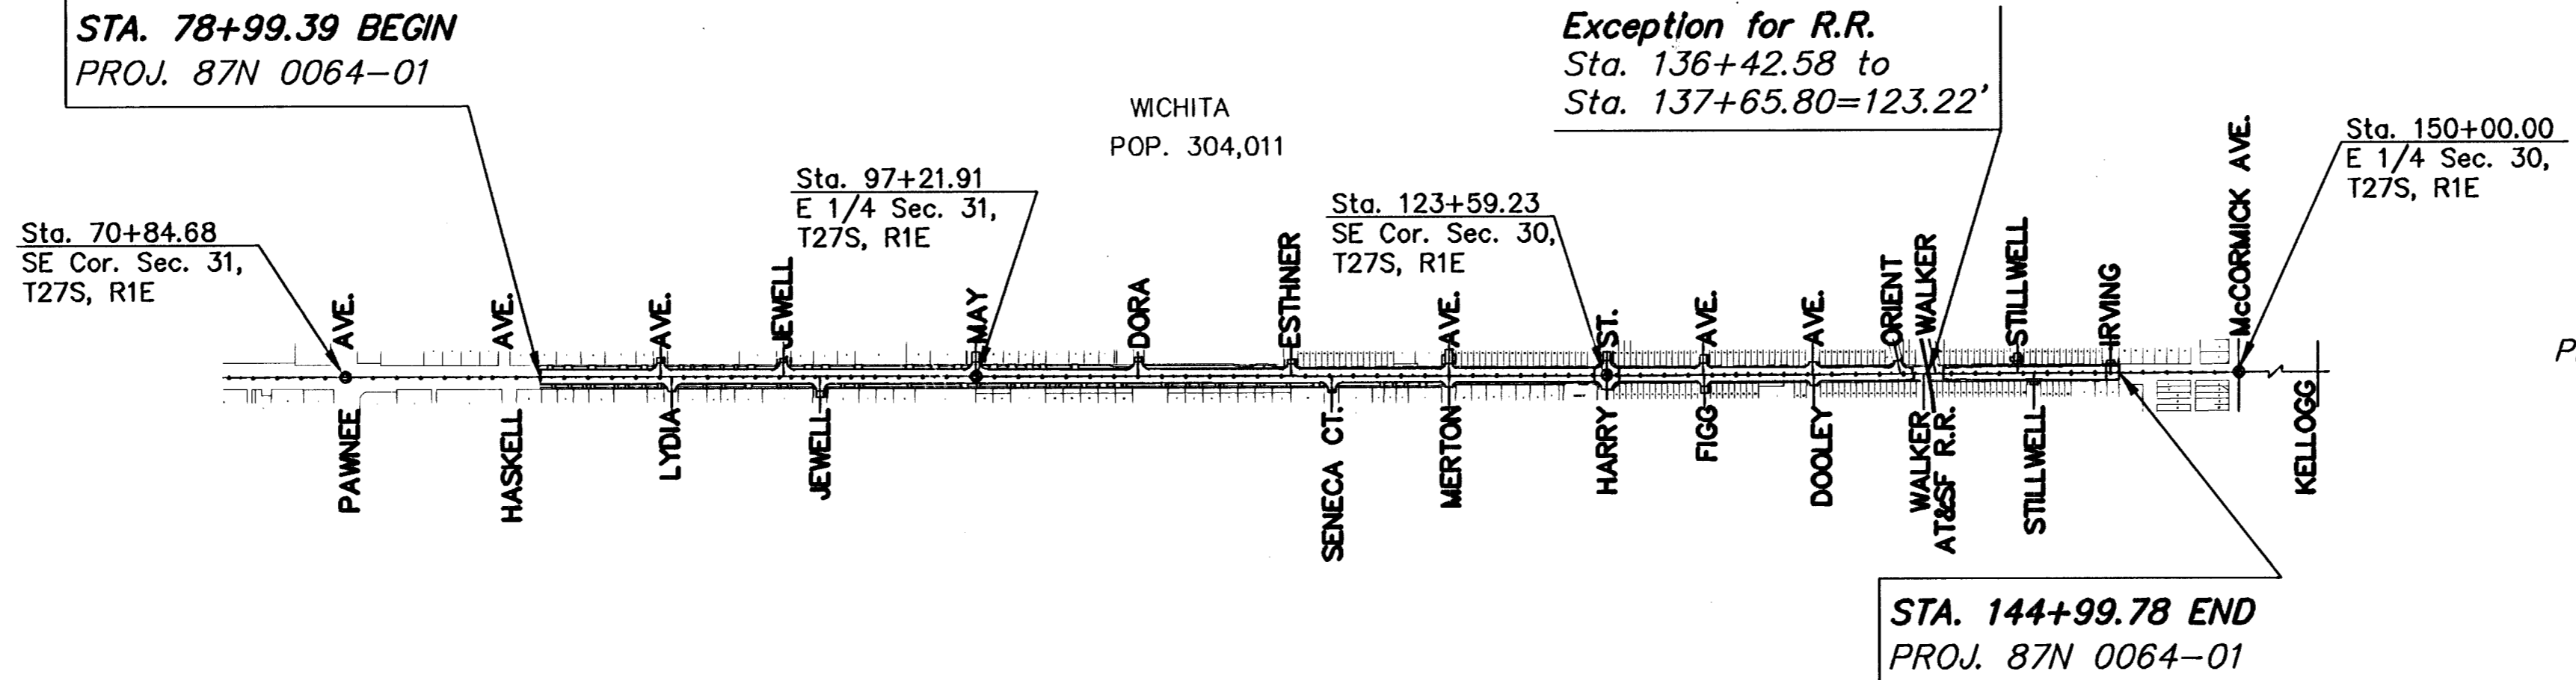

DESIGN DESIGNATION


| | | |
|-------------------|---|-----------|
| AADT (1995) | = | 18123 |
| AADT (2015) | = | 22100 |
| DHV | = | 722 |
| D | = | 56% |
| T | = | 03% |
| V | = | 40 M.P.H. |
| Control of Access | = | NONE |
| Clear Zone | = | 6 FT. |

SCALE: 1" = 600'

NOTE: TRAFFIC SHALL BE CARRIED THROUGH CONSTRUCTION
SEE SHEET NO. 97 FOR CONSTRUCTION SEQUENCES.


CONVENTIONAL SIGNS

| | | | |
|---------------------------------|-------|--------------------------|-------|
| COUNTY LINE | ---- | CENTER LINE OF PROJECT | ---- |
| CITY LIMITS | ----- | TERRACE | ----- |
| STATE OR NATIONAL LINE | ----- | CULVERTS | ----- |
| TOWNSHIP, SECTION or GRANT LINE | ----- | DROP INLET & STORM SEWER | ----- |
| PROPERTY LINE | ----- | ACCESS CONTROL | ----- |
| HIGHWAY FENCE | ----- | POWER POLE | ----- |
| EXISTING FENCE | ----- | TELEPHONE POLE | ----- |
| GUARD FENCE | ----- | MARSH | ----- |
| CONSTRUCTION LIMITS | ----- | HEDGE | ----- |
| RIGHT OF WAY LINE | ----- | TREES | ----- |
| TRAVELED WAY | ----- | PROFILE ELEVATION | ----- |
| RAILROADS | ----- | STREAM or CREEK | ----- |

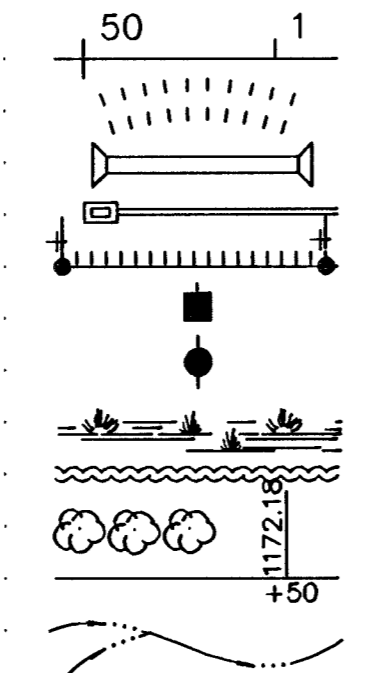

| | | |
|-------------------------|-------------|-------------|
| GROSS LENGTH OF PROJECT | 6600.39 FT. | |
| EXCEPTIONS | 123.22 FT. | |
| NET LENGTH OF PROJECT | 6477.17 FT. | 1.227 MILES |
| NET LENGTH OF BRIDGES | _____ FT. | _____ MILES |
| NET LENGTH OF ROAD | 6477.17 FT. | 1.227 MILES |

PREPARED & SUBMITTED BY
MID-KANSAS ENGINEERING CONSULTANTS, INC.
WICHITA, KANSAS

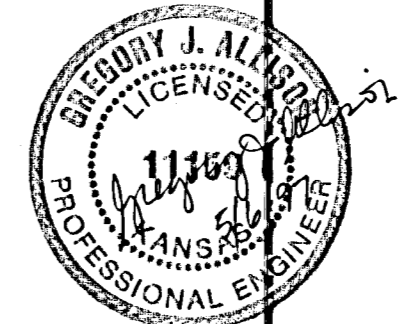

5.5-97

Michael E. Lindebak

MICHAEL E. LINDEBAK DESIGN DIVISION OF M.A.P.D.
CITY ENGINEER WICHITA, KANSAS
PROJECT NO. 87N-0064-01 M6675 (3)

RECOM. FOR APPROVAL-DATE

CHIEF BUREAU OF LOCAL PROJECTS
KANSAS DEPARTMENT OF TRANSPORTATION

APPROVED - DATE

STATE TRANSPORTATION ENGINEER
KANSAS DEPARTMENT OF TRANSPORTATION