







Scale: 1" = 60'

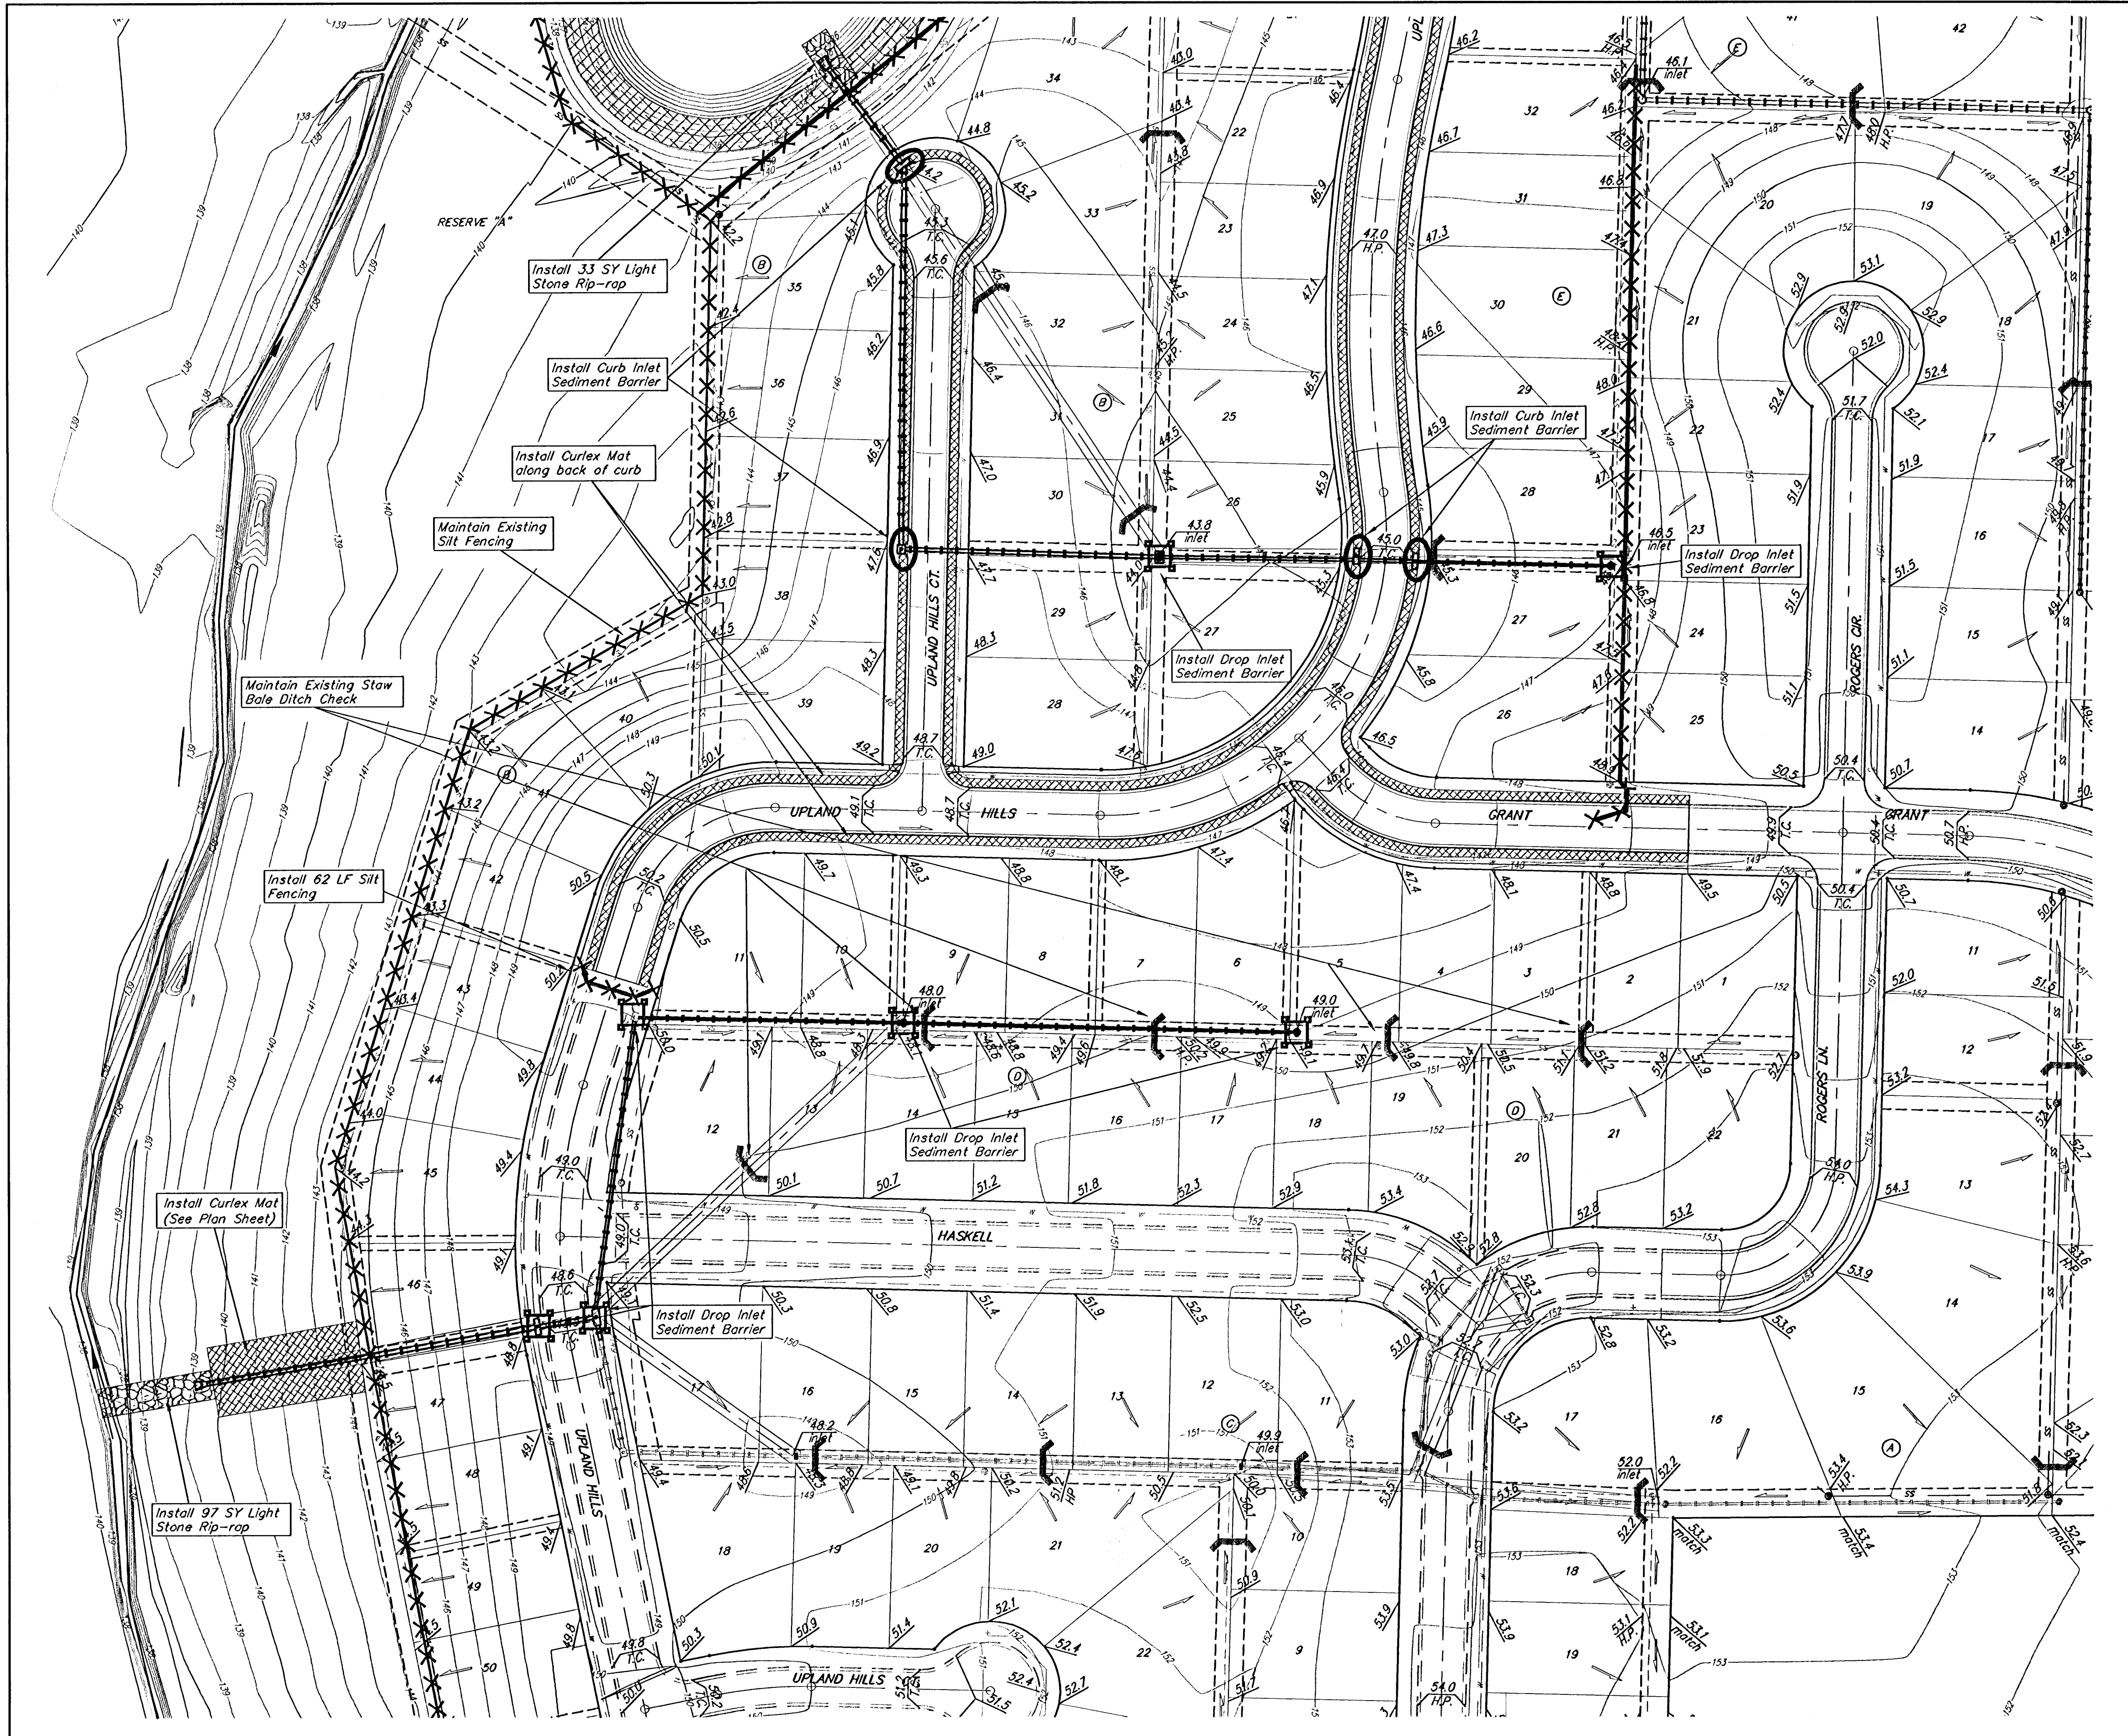


Construct 1-Construction Entrance along Pawnee Ave. (No construction through existing subdivision)

EROSION CONTROL PLAN LEGEND

-  - LIGHT STONE RIP-RAP
 -  - DROP INLET PROTECTION
 -  - CURB INLET PROTECTION
 -  - SILT FENCING
 -  - EARTH DIKES
- NO SCALE

EROSION CONTROL MEASURE	UNITS	QUANTITY
SILT FENCE	L.F.	62
RIPRAP	S.Y.	130
STRAW BALE DITCH CHECK	EA.	maintain
DROP INLET BARRIER	EA.	7
CURB INLET BARRIER	EA.	6
CURLEX OR EQUAL	SY	1,929
Construction Entrance	EA.	1

QUANTITIES ARE FOR INFORMATION ONLY!
CONTRACTOR SHALL VERIFY QUANTITIES PER SPECIFIC ENGINEERING PLAN SHEET.



Baughman
ENGINEERING | SURVEYING | PLANNING | LANDSCAPE ARCHITECTURE

Turkey Creek 2nd Addition - Phase II
Erosion Control Plan
STREET IMPROVEMENTS

PROJECT NUMBER: 47284029
DESIGN: MWS/JAK
APPROVED: [Signature]

DRAWN: JAK
DATE: 4/12/06

SCALE: 1" = 60'
SHEET: **21 OF 41**

F:\Eng\Turkey Creek 2nd\Phase II\ECPLAN (STREC2)