
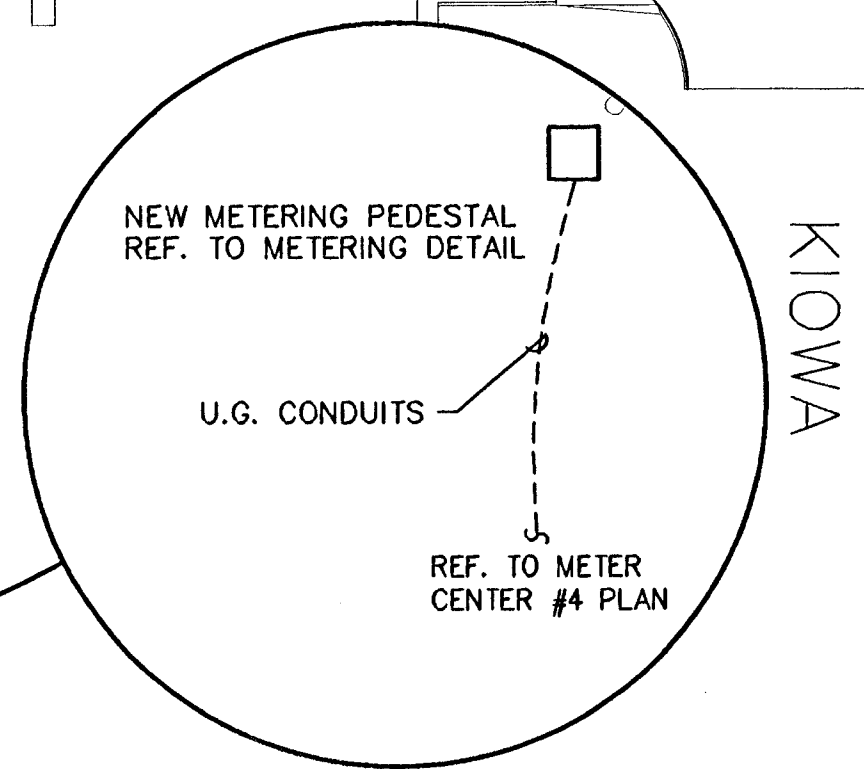




PLAN NOTES

1. E.C. SHALL COORDINATE ALL WORK WITH IRRIGATION CONTRACTOR.
2. E.C. SHALL USE EXISTING 6" SLEEVES BETWEEN ISLANDS AND CURB. E.C. SHALL REWORK THE EXISTING 6" SLEEVES TO ALLOW 36"-48" COVER.
3. E.C. SHALL MAINTAIN A MIN. COVER OF 36" OVER ALL U.G. CONDUITS. E.C. SHALL INCREASE CONDUIT COVER WITHIN THE STREET ISLANDS TO 48" MIN. TO CLEAR THE IRRIGATION AND TREE PLANTING EXCAVATION. MAINTAIN 12" CLEARANCE UNDER ALL IRRIGATION PIPING.
4. E.C. SHALL PROVIDE 1ea. 15 AMP 120 VOLT UNSWITCHED CIRCUIT TO THE IRRIGATION CONTROLLER. IRRIGATION CONTROL PROVIDED AND MOUNTED BY IRRIGATION CONTRACTOR.

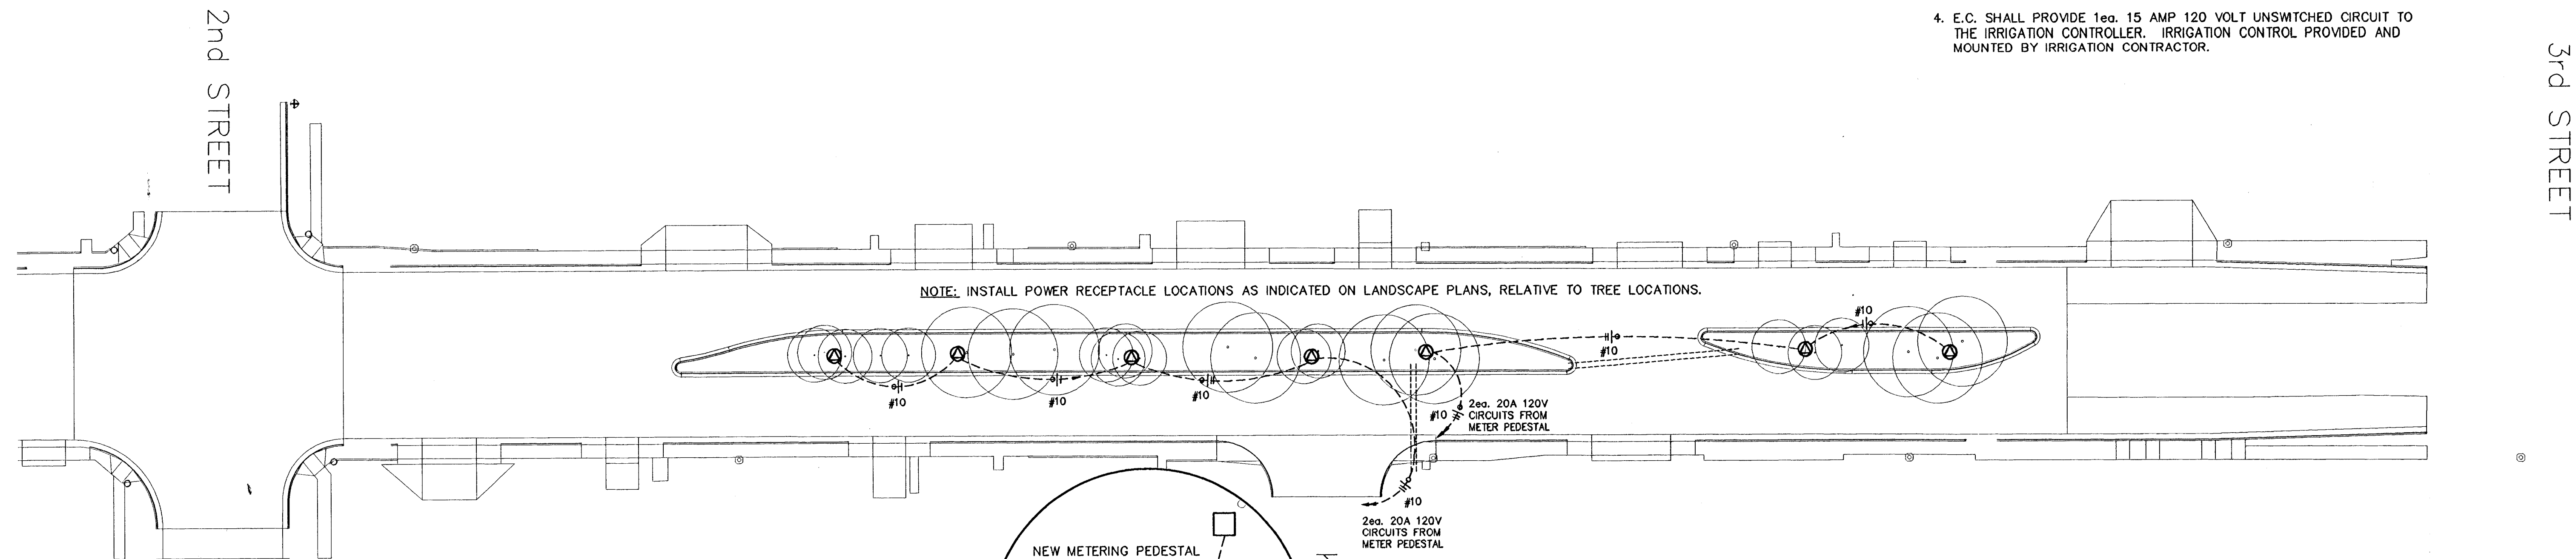




ELECTRICAL PLAN NO. 4

1" = 30'

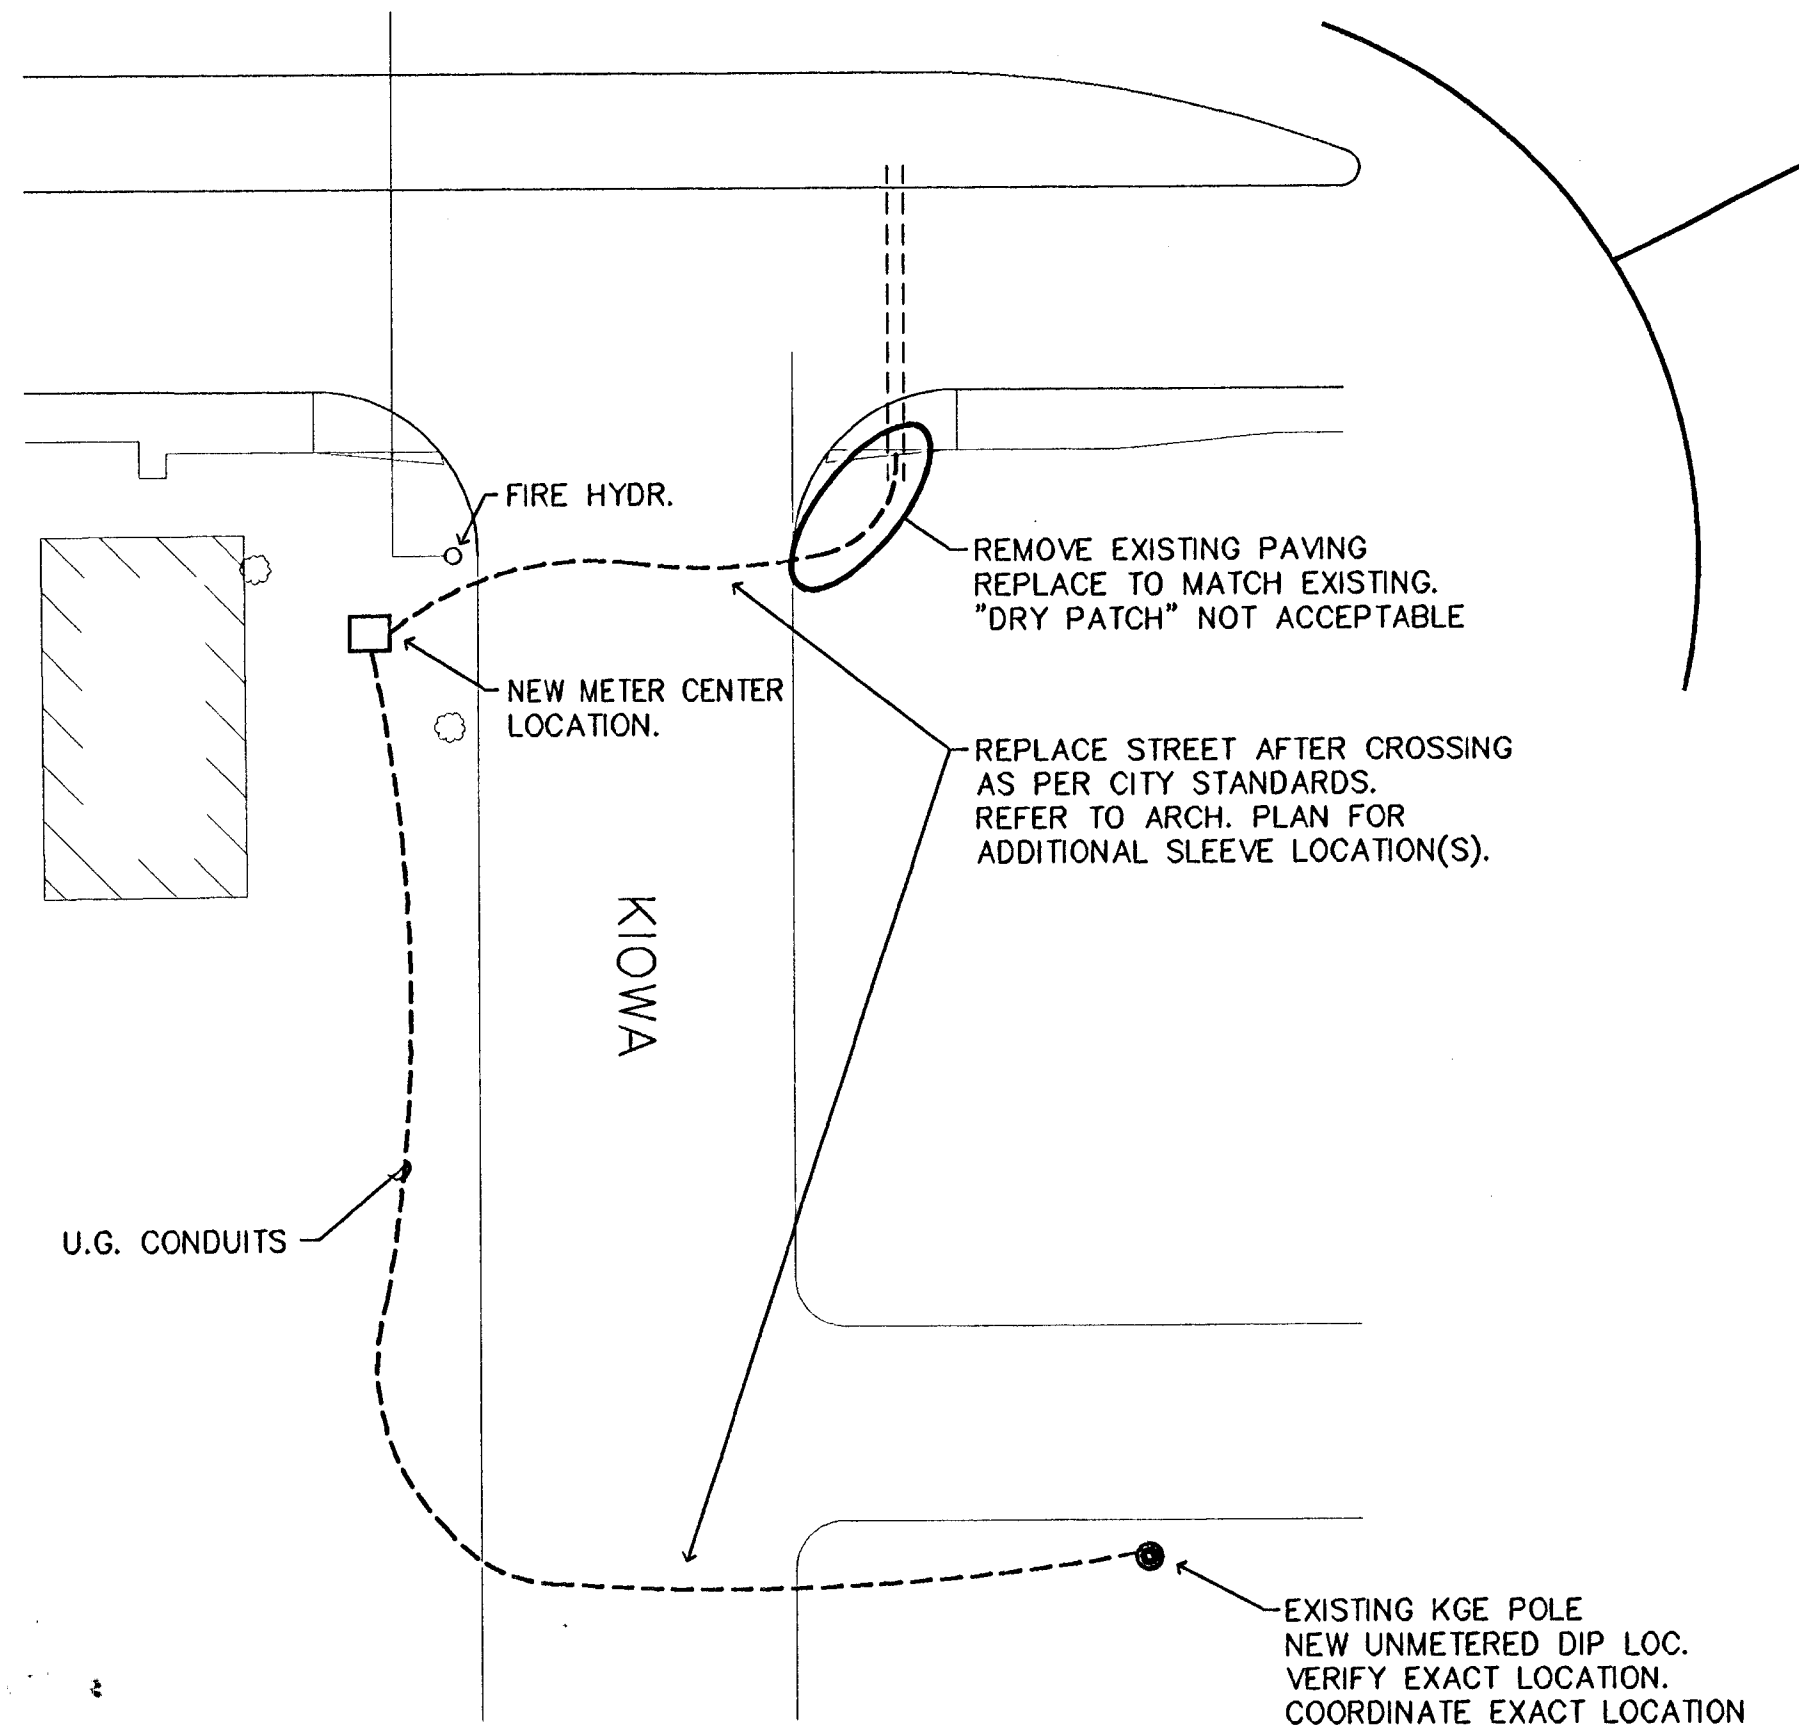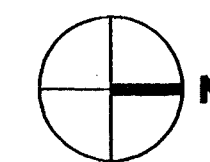

METER CENTER #4

ELECTRICAL KEY PLAN

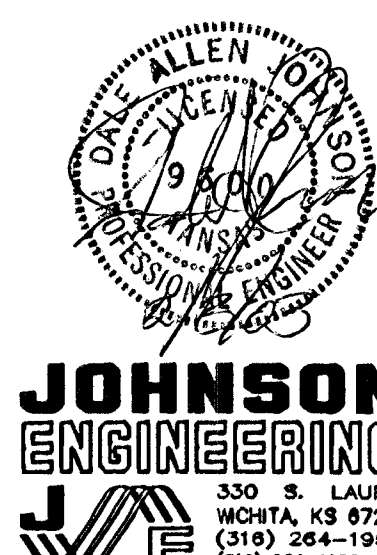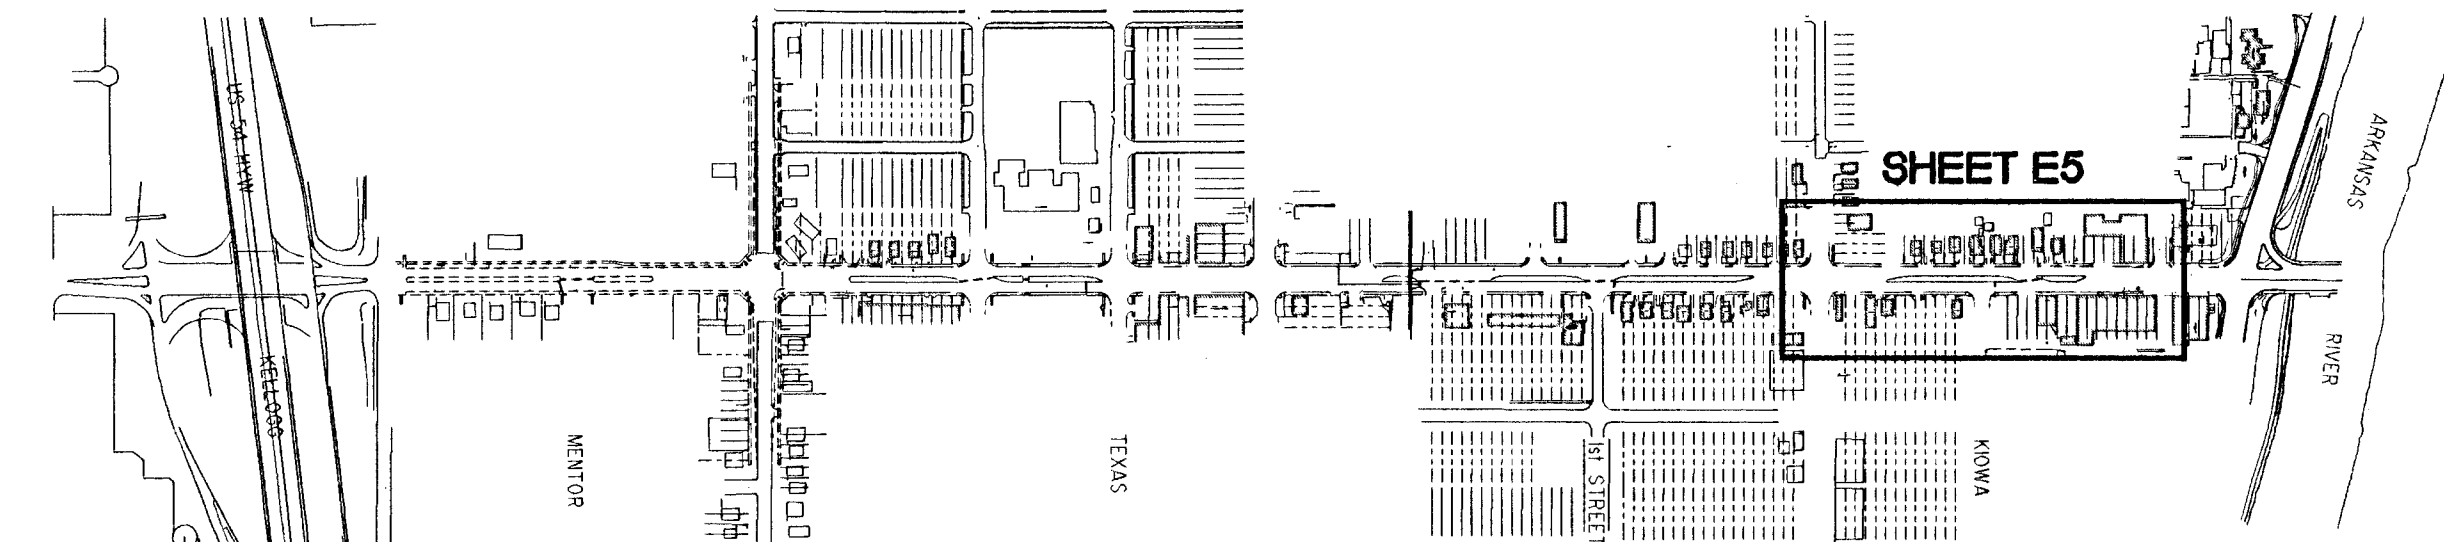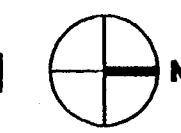

JOHNSON ENGINEERING
 330 S. LAURA
 WICHITA, KS 67211
 (316) 264-1953
 (316) 264-1954 FAX

MKEC
 ENGINEERING CONSULTANTS
 411 N. WEBB ROAD
 WICHITA, KS. 67206
 316-684-9600

SENECA STREET		
PROJECT NAME		
ELECTRICAL PLAN NO. 4		
SHEET TITLE		
DAJ	DAJ	DAJ
DESIGN BY:	DRAWN BY:	CHECKED BY:
2/3/03	E5	E5 / 5
DATE	DRAWING NAME	SHEET # OF