








EROSION CONTROL PLAN
(Introduction Details Found in the SPP2 Plan)

LEGEND



-  - LIGHT STONE RIP-RAP
-  - DROP INLET PROTECTION
-  - CURB INLET PROTECTION
-  - STRAW BALE BARRIERS
-  - SILT FENCING
-  - EARTH DIKES
-  - CURLEX BLANKET

NO SCALE


All easements have been graded prior to construction with the mass grading plan, however, all easements shall be fine graded with this project after street & s/w construction has been completed. All cost associated with the fine grading shall be included in the lump sum bid item "Easement Grading".




Scale: 1" = 60'

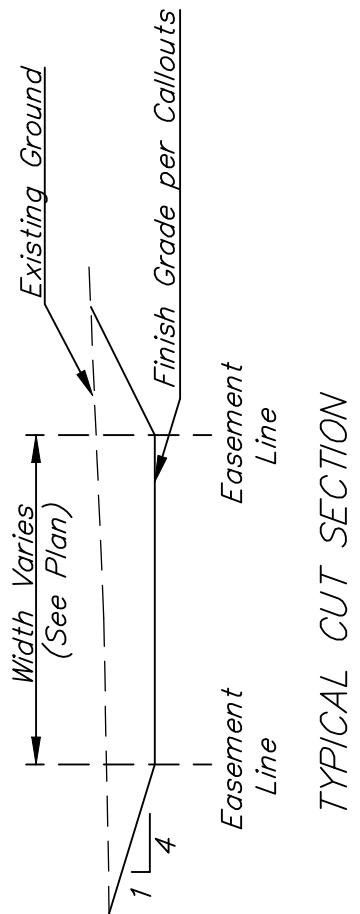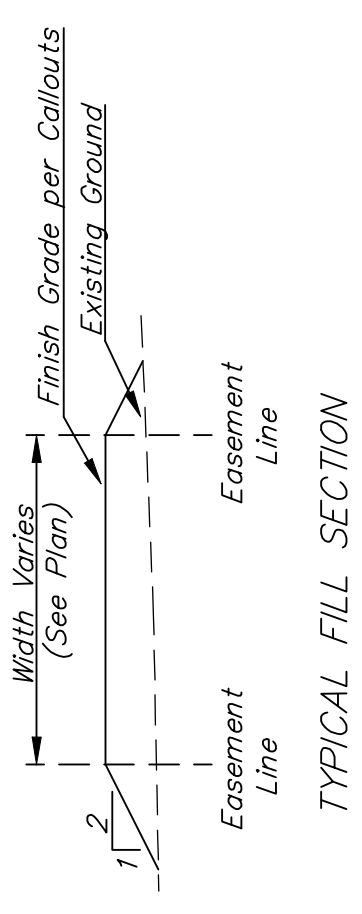

SECTION A-A

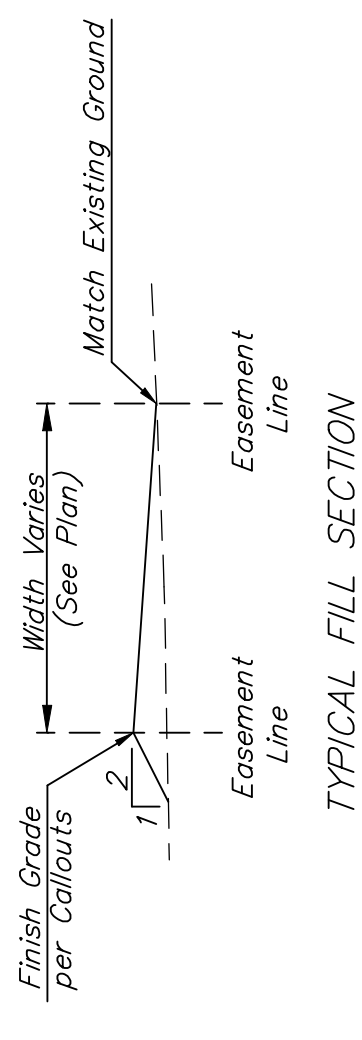


TYPICAL CUT SECTION

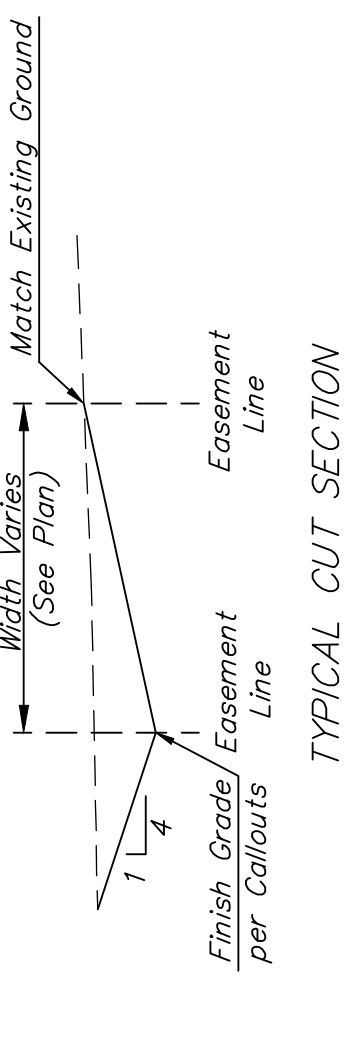

TYPICAL FILL SECTION


SECTION B-B

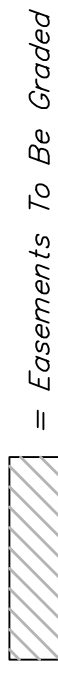

= Easements To Be Graded

The contractor shall grade the easements as shown to the elevations given on the easement grading plan. All costs for grading shall be incidental to the Easement Grading Bid Item.

The contractor shall 'straight' grade the easements between the elevations given. Where a callout designates 'Match', the contractor will grade to the existing ground elevation.

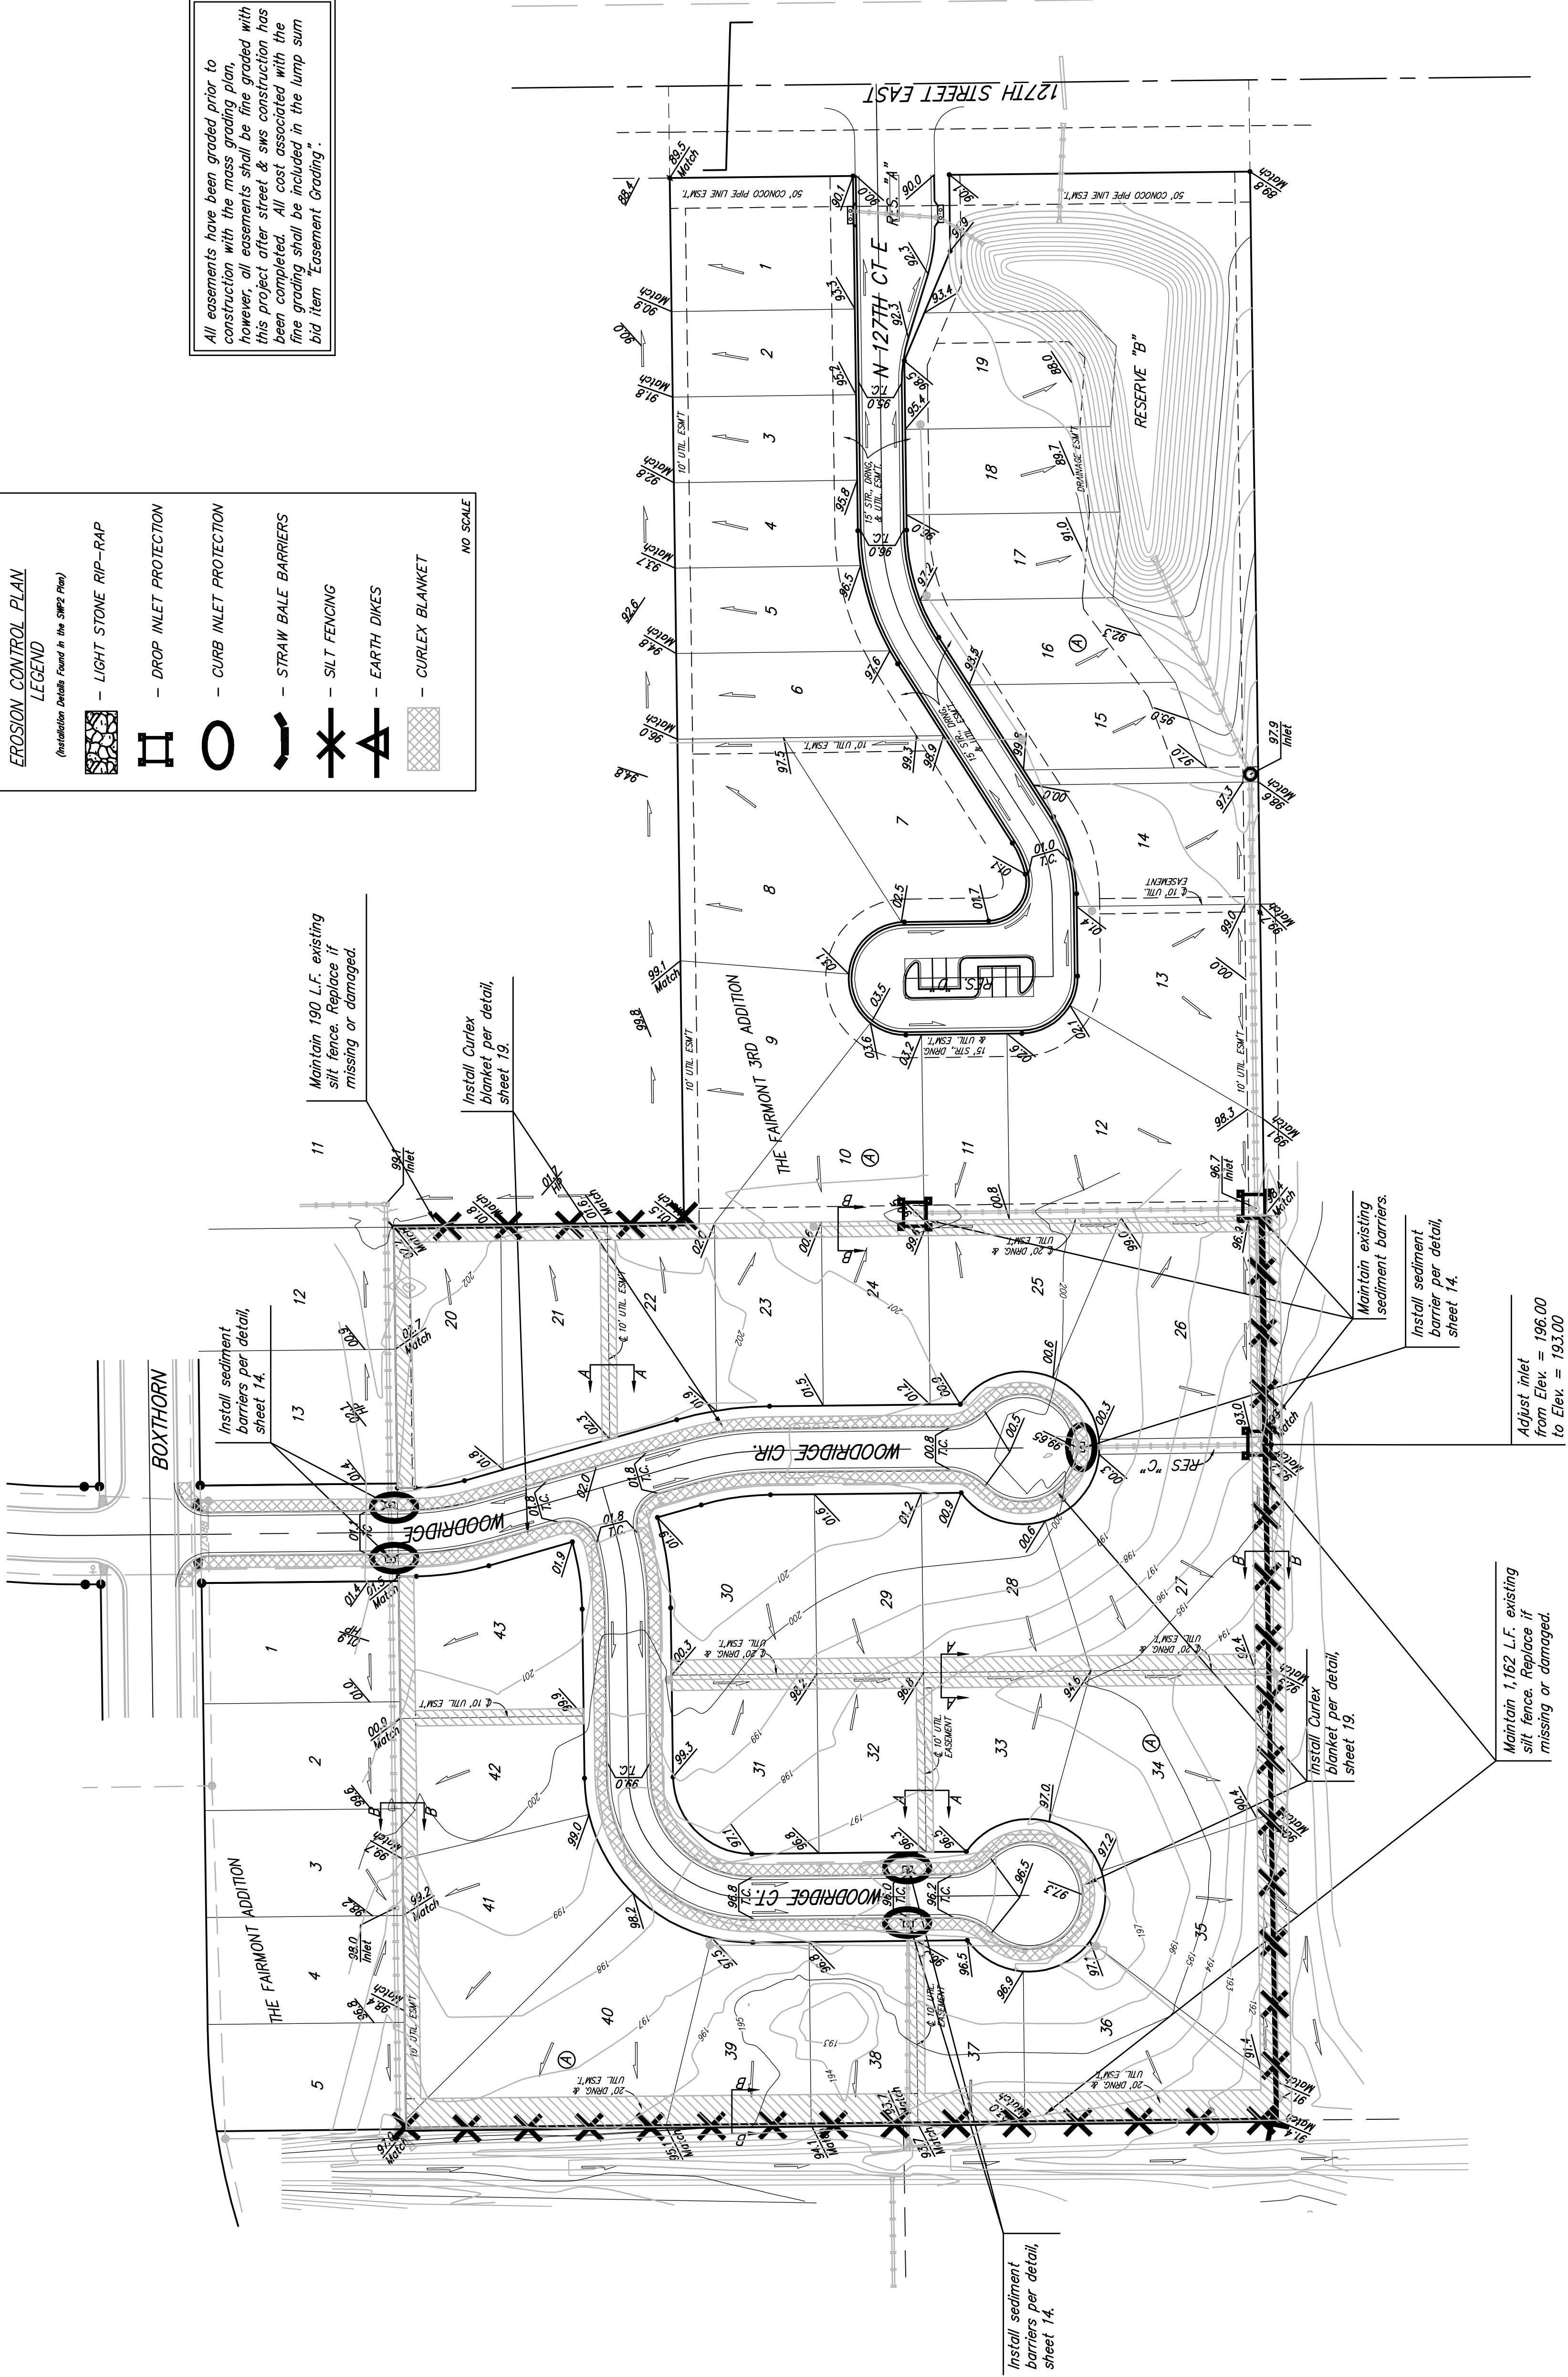

Maintain 1,162 L.F. existing silt fence. Replace if missing or damaged.

Adjust inlet from Elev. = 196.00 to Elev. = 193.00

Maintain one construction entrance onto existing paved roadway per detail, sheet 14.

NOTE: Contractor shall remove & replace existing erosion control measures as necessary for construction. Contractor shall be required to maintain all on-site erosion control items until final acceptance by the City of Wichita.

THE FAIRMONT 3RD ADD. - PH IIP
Erosion Control Plan/
Easmt. Grading Plan
WATER DISTRIBUTION SYSTEM

Baughman
 ENGINEERING SURVEYING | PLANNING | LANDSCAPE ARCHITECTURE

PROJECT NUMBER: 41254131
 DESIGN: TMS
 DRAWN: TMS
 APPROVED: TMS
 DATE: 3/01

SCALE: NOTED
 SHEET: 11 OF 20

04-11E108
 Fairmount3rdSPP2Plan