

SCALE: 1" = 60'
• = Iron

BENCHMARK:
City Disc 45' North of 1/4 Corner,
1/2 Mile East of Ridge Road on
29th St. North.
Elev. = 1328.47 NVD
= 141.07 City Datum

City Disc at S.W. Corner of R.C.B.C.
for Big Slough at Ridge Road
Elev. = 1331.62 NVD
= 144.22 City Datum


POND DATA:
STATIC POOL ELEVATION: 132.6 City Datum
BOTTOM ELEVATION: 125.6 City Datum

NOTE:
Proposed top of foundation elevations
are shown on plans.
Contractor to set finish floor elevation.

All street elevations shown on plans
are for top of curb (full height).

View-out elevations are denoted as
XX.X V.O.

MINIMUM BUILDING PAD ELEVATIONS FOR LOWEST OPENINGS TO THE STRUCTURES		
LOT(S)	BLOCK	ELEVATION
		CITY DATUM M.S.L.
1	1	139.6 1327.0
1-16	3	139.6 1327.0
3-39 44-46 49-64 65-70	4	139.6 1327.0

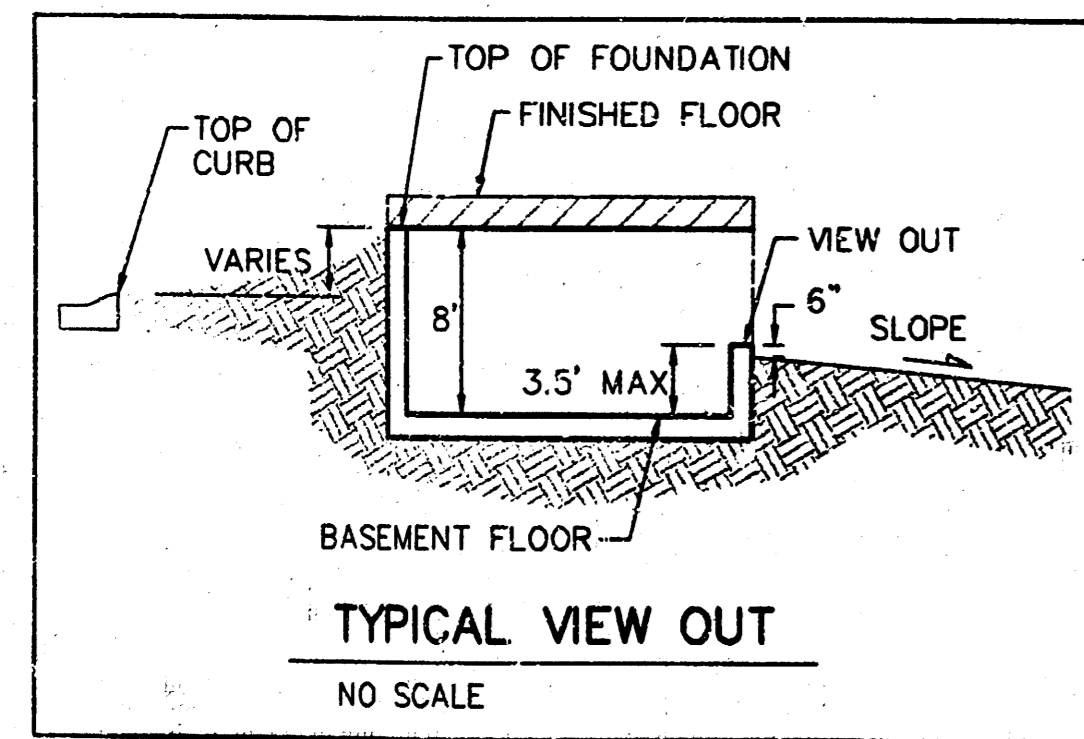

APPROVED DRAINAGE PLAN

Rev. 9/23/03 by AEG - Revised to show new plat

**RIDGE PORT ADDITION
LOT GRADING**
WICHITA, KANSAS

BAUGHMAN COMPANY P.A.
ENGINEERING, SURVEYING, & PLANNING
316-282-7271 • 315 ELLIS • WICHITA, KANSAS 67211

PROJECT NUMBER: _____ SHEET: **3** OF **4**

DESIGN: BLJ/DMV DRAWN: JAK APPROVED: _____ DATE: _____ SCALE: 1"=60'