

**CLASSROOM ALTERNATE**  
Scale 1" = 40'0"

CONTRACTOR TO INSTALL AND MAINTAIN 746 LF OF SILT FENCE PER DETAIL 1 THIS SHEET. (THIS PORTION OF SILT FENCE IS TO BE MAINTAINED DURING THE CONSTRUCTION OF BUILDING ONLY. SILT FENCE WILL BE MOVED BEFORE DEMOLITION OF EXISTING BUILDING TO BEGIN.)

OWNER TO INSTALL AND MAINTAIN 692 LF OF SILT FENCE PER DETAIL 1 THIS SHEET. (THIS PORTION OF SILT FENCE IS TO BE INSTALLED PRIOR TO THE DEMOLITION OF THE EXISTING BUILDING. CONTRACTOR MAY REUSE FENCING FROM PRIOR PHASE IF IN GOOD CONDITION)

CONTRACTOR SHALL CONSTRUCT AND MAINTAIN APPROVED ENTRANCE AS DISCUSSED IN THE STORM WATER POLLUTION PREVENTION PLAN GUIDELINES. ENTRANCE SHALL BE A MINIMUM OF 30' WIDE BY 85' IN LENGTH WITH 4"-6" DIA. STONE AT A DEPTH OF 6".

CONTRACTOR TO INSTALL AND MAINTAIN 1,702 LF OF SILT FENCE PER DETAIL 1 THIS SHEET (THIS PORTION OF SILT FENCE TO BE MAINTAINED THROUGH ALL PHASES OF THE PROJECT.)

**BENCHMARK**

T1 Cut on Crosswalk Signal Pole Base 6.4' N and 25.3' E of the NE Corner SE 1/4, NW 1/4 Section 29-26S-1E Elevation = 1323.41

**LEGAL DESCRIPTION**

Lot 1, Block A, Earhart Elementary School Addition, Wichita, Sedgwick County, Kansas.


**SITE INFORMATION**

Total Area: ±683,866.76 sq. ft. (15.7 acres)  
Impervious Area: ±176,967 sq. ft. (4.06 acres)  
Building Area: 57,207 sq. ft.  
Parking Provided: 60 Spaces, plus 3 Accessible Stalls (Including 2 Van Accessible)

**EROSION CONTROL NOTES**


- No land clearing or grading shall begin until all applicable erosion control measures have been installed. This project is subject to this SWPP Plan. The Contractor shall comply with any unusual requirements as necessary for the site to be in compliance during construction, per this plan and City specs (See #11).
- All exposed areas shall be seeded as specified within 30 days of final GRADING.
- Should construction stop for longer than 15 days, the site shall be seeded as specified.
- Maintain erosion control measures after each rain and at least once a week.
- This plan shall not be considered all inclusive as the contractor shall take all necessary precautions to prevent soil sediment from leaving the site.
- Contractor shall comply with all state and local ordinances that apply.
- Additional erosion and sediment control measures will be installed if deemed necessary by on site inspection.
- Land disturbing activities shall not commence until approval to do so has been received by governing authorities.
- If installation of storm drainage system should be interrupted by weather or nightfall, the pipe ends shall be covered with filter fabric.
- See Landscape Plan for ground treatments in all disturbed areas beyond impervious surfaces.
- This SWPP Plan should be in job trailer and/or on site at all times. The Contractor is responsible for any needed changes, updates or maintenance to BMP's on site. This plan may change and updates need to be recorded and documented on the plan. This plan is a flexible plan, due to changing site conditions and weather. Please inform Landscape Architect and/or Engineer of changes to plan.
- ANY substitutions for the sediment control devices shown, must be approved by the Landscape Architect and/or Engineer prior to any uses on site.
- An NPDES Permit Application has been submitted for this property. A copy of this application must be kept at the job site for the duration of the construction process.

**EROSION CONTROL LEGEND**

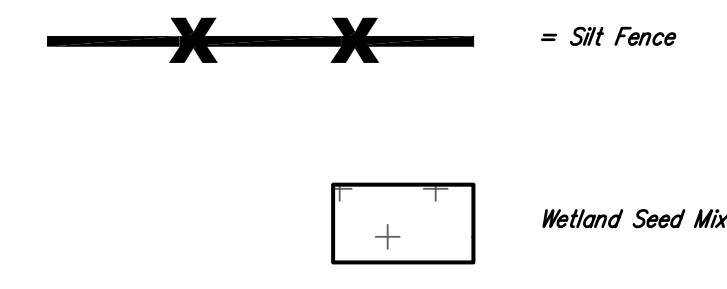


**NOTE:**  
ALL OTHER AREAS DISTURBED ON SITE NOT NOTED FOR WETLAND SEED MIX SHALL RECEIVE SHORT GRASS PRairie SEED MIX

**EROSION CONTROL PLAN**  
Scale 1" = 40'0"

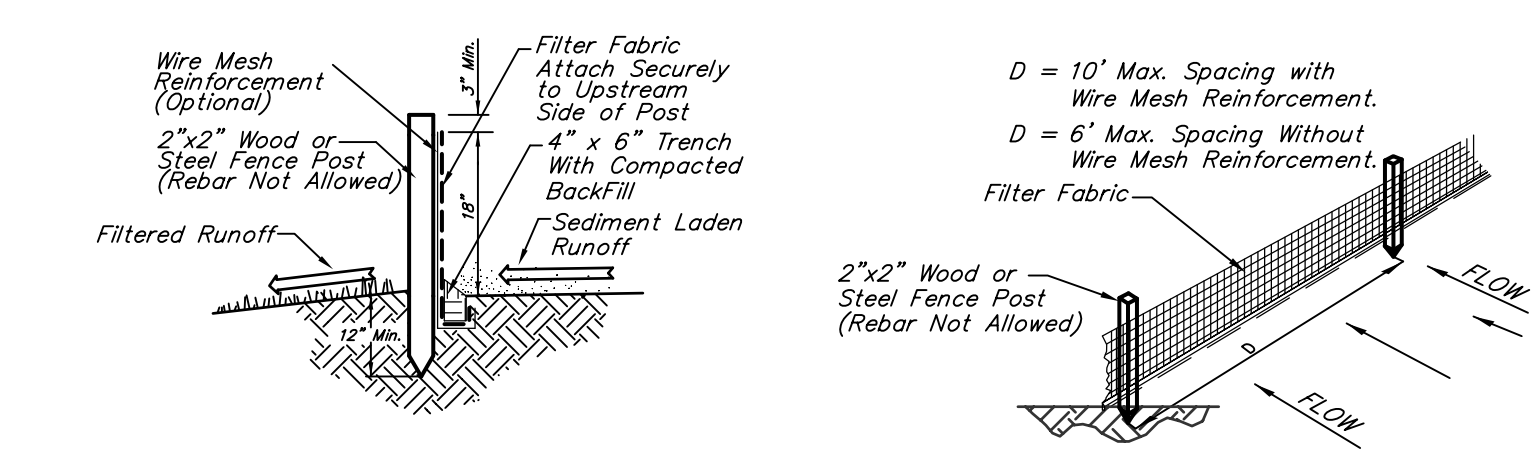

**SILT FENCE DETAIL**  
NOT TO SCALE

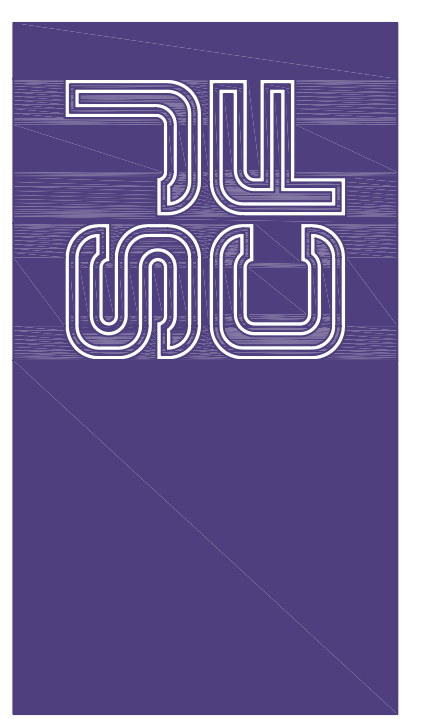

SCHAEFER JOHNSON COX FREY ARCHITECTURE  
Empire Center  
287 N. Broadway  
Wichita, KS 67202-2317  
Ph: 316.884.0171  
Fax: 316.884.8888  
architect@sjcf.com

BAUGHMAN COMPANY, P.A.  
CIVIL ENGINEERS  
DUDLEY WILLIAMS & ASSOCIATES, P.A.  
STRUCTURAL ENGINEERS  
MIDWEST ENGINEERING, INC.  
MECHANICAL ENGINEERS  
JOHNSON ENGINEERING  
ELECTRICAL ENGINEERS

EARHART ENVIRONMENTAL MAGNET  
ELEMENTARY SCHOOL  
UNIFIED SCHOOL DISTRICT #259  
4401 N. ARKANSAS AVENUE  
WICHITA, KS 67204

©2007  
Schaefer Johnson Cox Frey & Associates, P.A.  
All Rights Reserved

These drawings and their contents, including, but not limited to, all concepts, designs, & ideas are the exclusive property of Schaefer Johnson Cox Frey (SJCF), and may not be used or reproduced in any way without the express consent of SJCF.

**Revisions**

5.02.07	△
	△
	△
	△
	△

**Project Number**  
SJCF 2907.00  
USD259 07-42547

**Date**  
23 MARCH 2007

**EROSION CONTROL PLAN**

1" = 40'0"  
**C22.3**

**Baughman**  
ENGINEERING | SURVEYING | PLANNING  
LANDSCAPE ARCHITECTURE  
Baughman Company, P.A.  
315 E. 11th - Wichita, KS 67211  
P: 316.262.7271 F: 316.262.0149  
E: Earhart\_Elem@Sjcf.com  
BAUGHMAN JOB NO: 07-02-E754  
DESIGN/DRAWN: BT/BKB  
CHECKED: NBW