

GENERAL NOTES

1. THE EROSION CONTROL DEVICES SHOWN ON THIS SHEET ARE CONSIDERED MINIMUM STANDARDS. WHENEVER SEDIMENT ENTERS THE STREETS, STORM SEWERS, DITCHES, OR PONDS, CONTRACTOR WILL INSTALL ADDITIONAL DEVICES, AS NEEDED, TO CORRECT THE PROBLEM.
2. THE EROSION CONTROL DEVICES SHOWN HEREON MUST BE IN PLACE AT ALL TIMES DURING CONSTRUCTION UNTIL SUCH TIME AS THE SITE IS REESTABLISHED WITH PAVING OR GRASS. TEMPORARY OR PERMANENT AND MULCH WILL BE INSTALLED WHEN EARTHWORK ACTIVITIES CEASE IN AN AREA FOR 14 DAYS OR MORE.
3. BACK OF CURB PROTECTION: AS SHOWN ON CITY STANDARD DETAILS. THESE DEVICES MUST REMAIN IN PLACE UNTIL THE AREA BETWEEN THE CURB AND RIGHT-OF-WAY LINE HAS BEEN PERMANENTLY STABILIZED.
4. ANY MUD INADVERTENTLY TRACKED ONTO ANY STREET WILL BE CLEANED UP BY THE CONTRACTOR, AT THE END OF EACH DAY'S WORK.
5. CONTRACTOR TO FURNISH A TRUCK WASH-OUT PIT TO BE PLACED AT A CONVENIENT LOCATION THAT DOES NOT CONFLICT WITH CONSTRUCTION. CONTRACTOR SHALL CLEAN OUT AND BACKFILL PIT PRIOR TO FINAL INSPECTION.

LEGEND

- x— Silt Fence Barrier
- ⊙ Area Inlet Protection
- Curb Inlet Protection
- ▨ Back of Curb Protection
- ▩ Pond Slope Protection

SCALE: 1"=100'




Center of Sec. 30, T26S, R1W Found Stone 30" Deep Reset 3/4" Pipe w/PEC Cap

E 1/4 Corner, Sec. 30 Twp. 26S, R1W Found #4 Bar w/ Moehring Cap


N.E. Cor., SE 1/4, SE 1/4 Sec. 30, T26S, R1W No Monument Found

S.E. Corner Sec. 30, T26S, R1W Found 1 1/2" Rebar w/ Moehring Cap

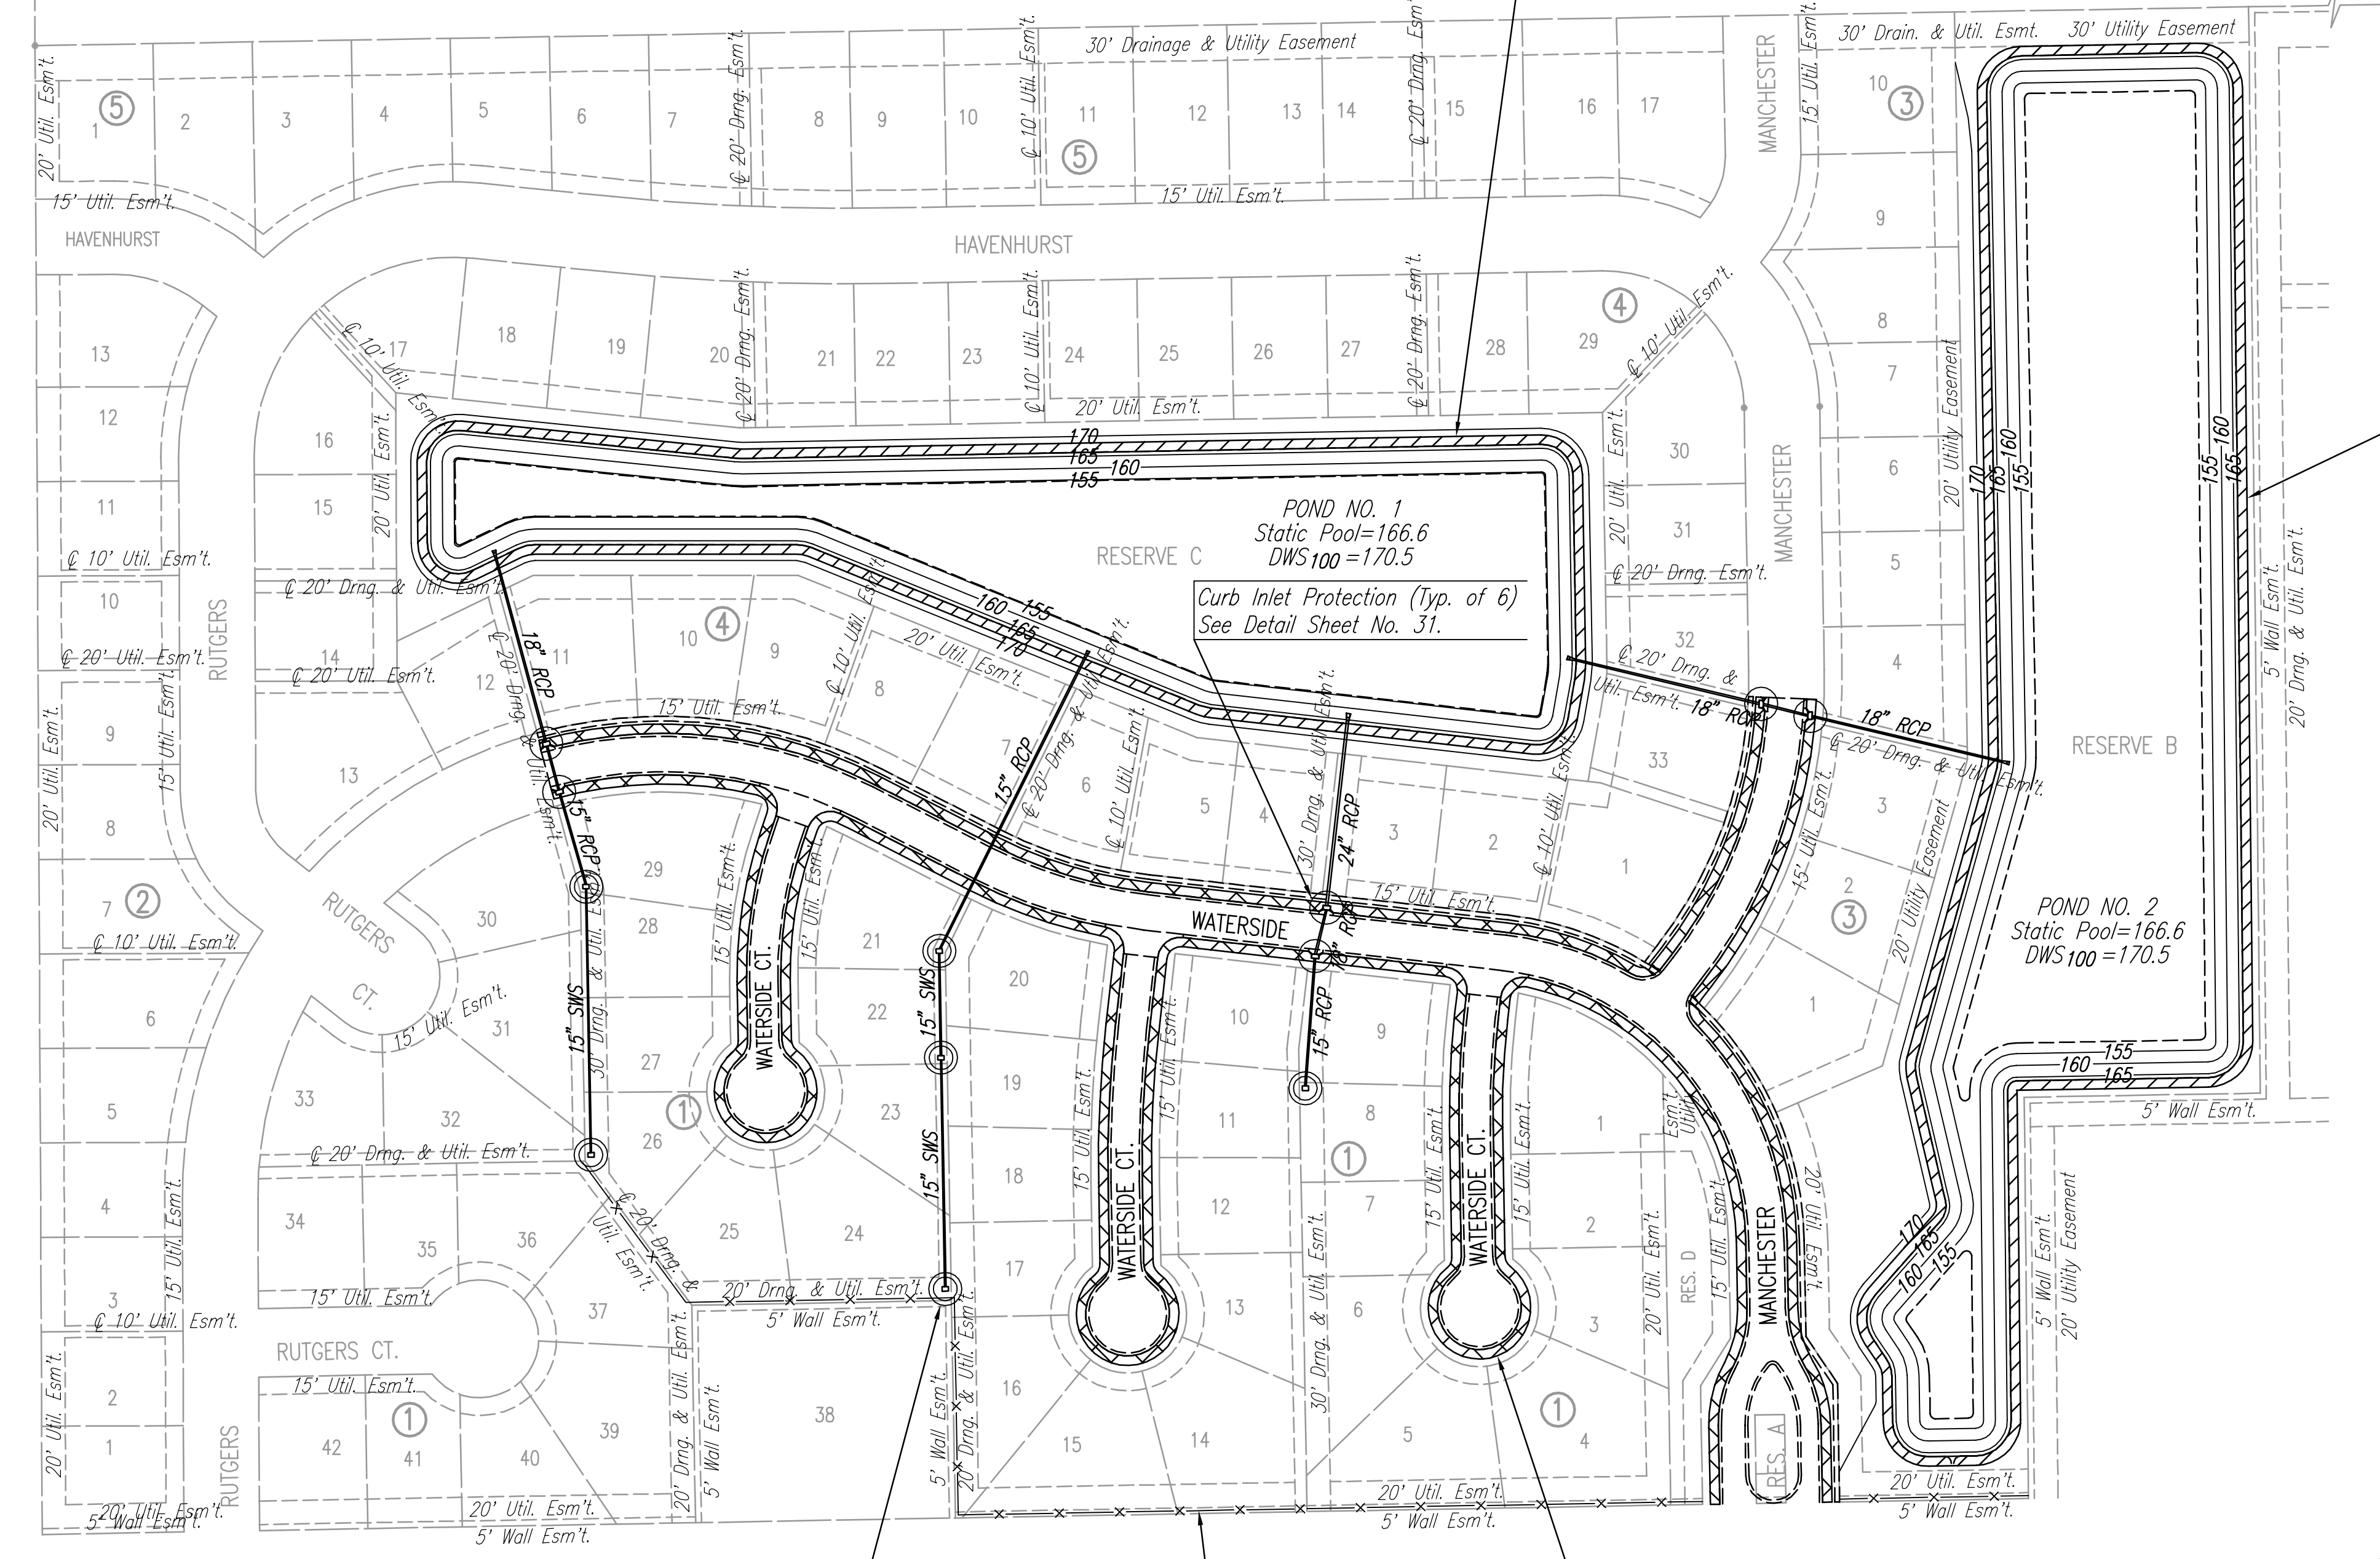


Install Pond Slope Protection Along Full Pond Perimeter. (See Detail, This Sheet)

Install Pond Slope Protection Along Full Pond Perimeter. (See Detail, This Sheet)

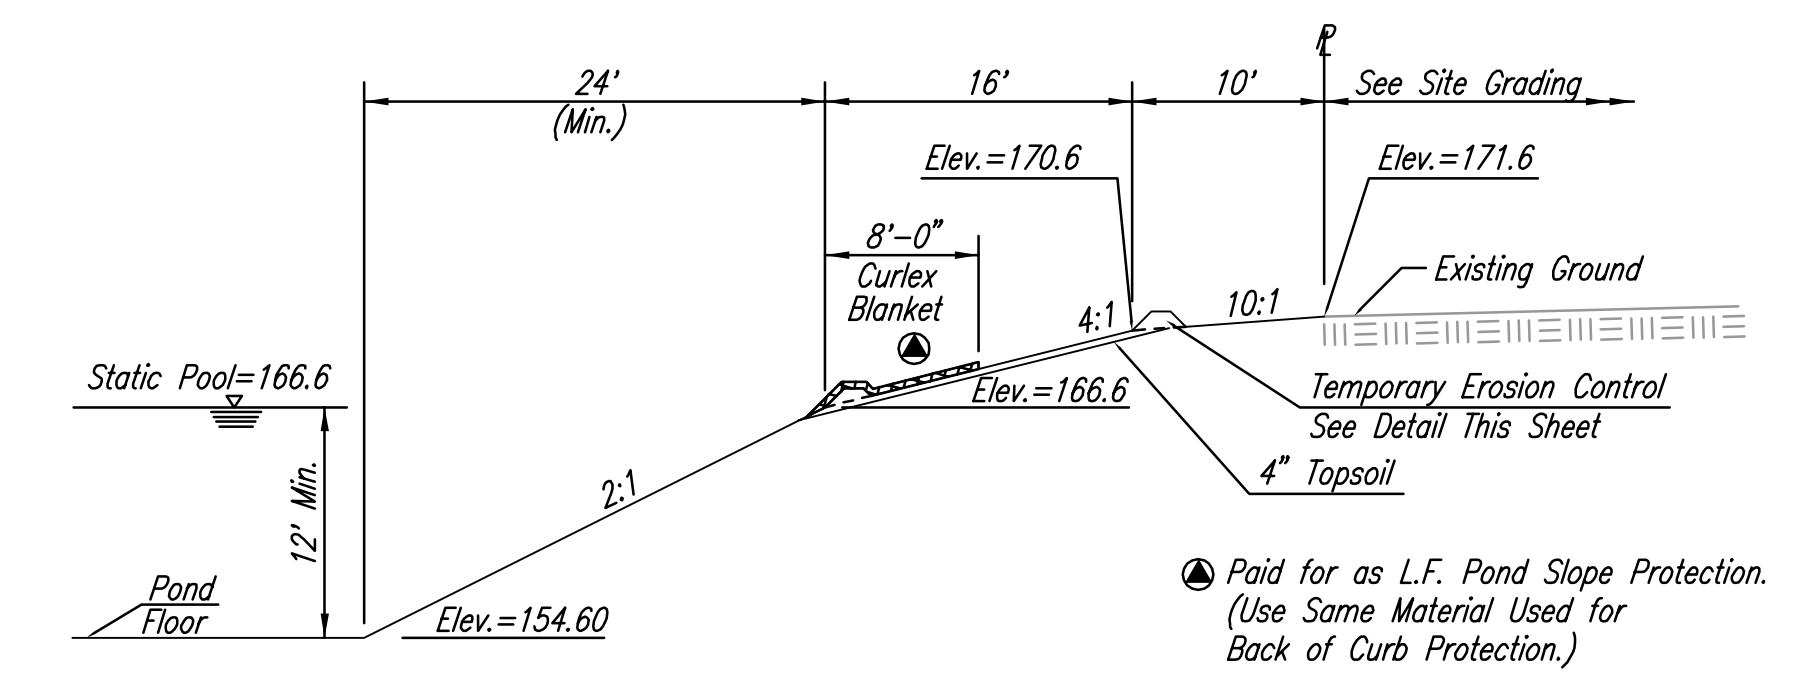

TYPICAL POND #1 SECTION (Showing Slope Protection)

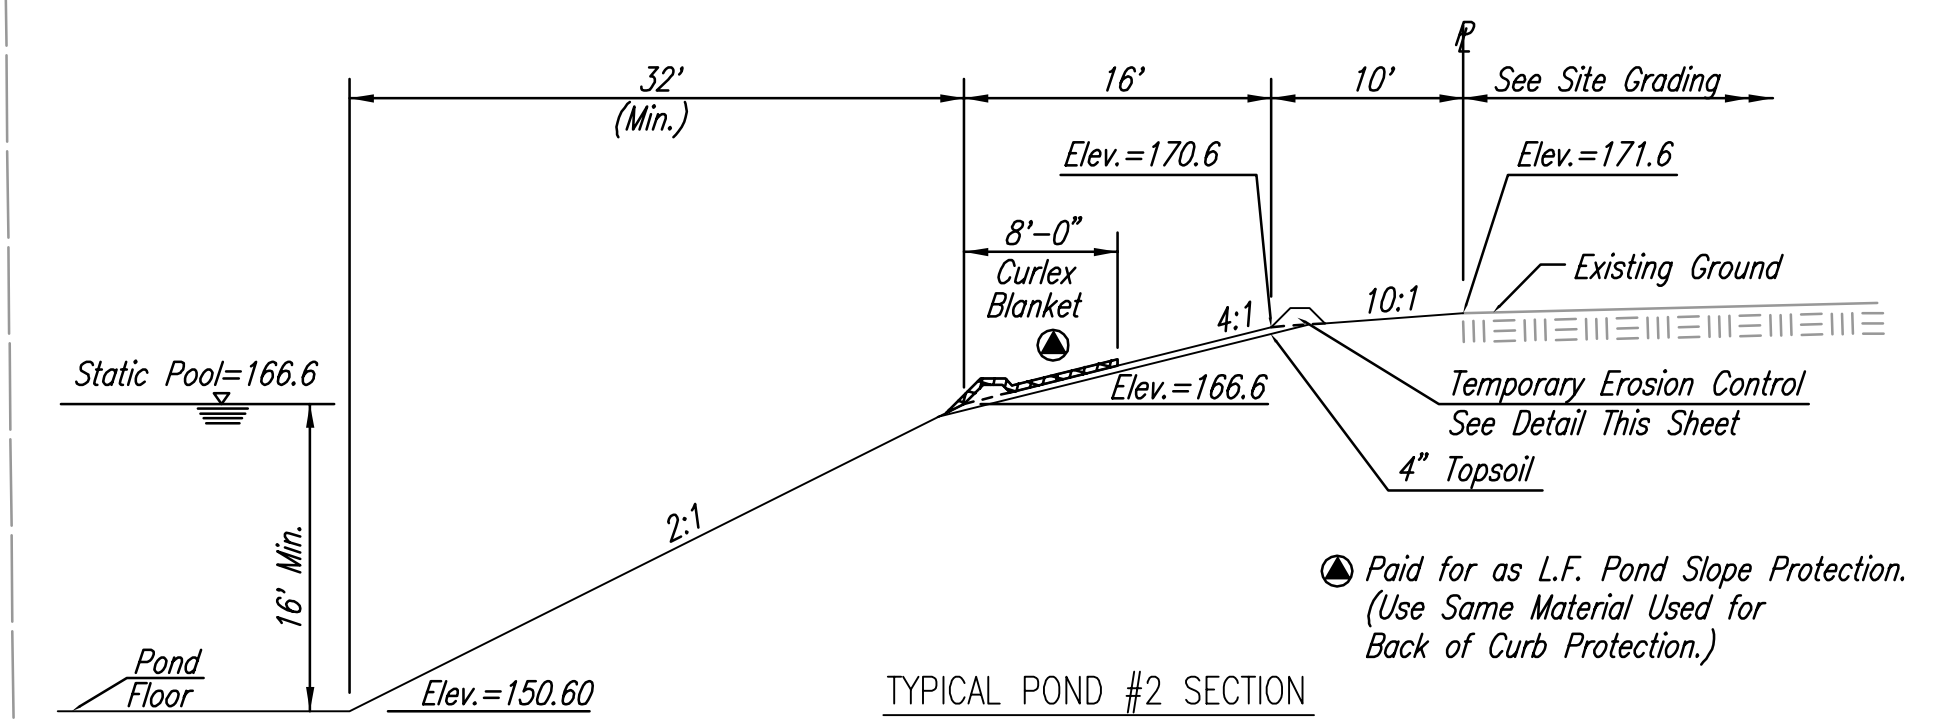

TYPICAL POND #2 SECTION (Showing Slope Protection)

DSNR: BDB OPER: BJS SCALE: 1"=100.00 08-11-2004 02:54:31 pm

S.W. Cor. SE 1/4 of Sec. 30, Twp. 26S, R1W Found 1" Iron Pipe

Area Inlet Protection (Typ. of 6) See Detail Sheet Nos. 29 & 30.

Silt Fence Barrier See Detail Sheet No. 29.

Back of Curb Protection See Detail Sheet No. 28.

No.	Revision	By	Date
PRAIRIE POINTE-PHASE 1			
<b>EROSION CONTROL (BMP) PLAN</b>			
JAMES L. ARMOUR, P.E.-ACTING CITY ENGINEER CITY OF WICHITA PROJECT NO. 472-84023			
<b>Professional Engineering Consultants, P.A.</b> 303 S. TOPEKA • WICHITA, KANSAS 67202 316-262-2691 • FAX 316-262-3003			
Designed by	BDB, BLB	Job No.	35-04171-000
Drawn by	BJS	Date	May 2002
			Sheet 27 of 50

