


STREET REHABILITATION FOR
17TH STREET BETWEEN HILLSIDE & OLIVER
WICHITA, KS

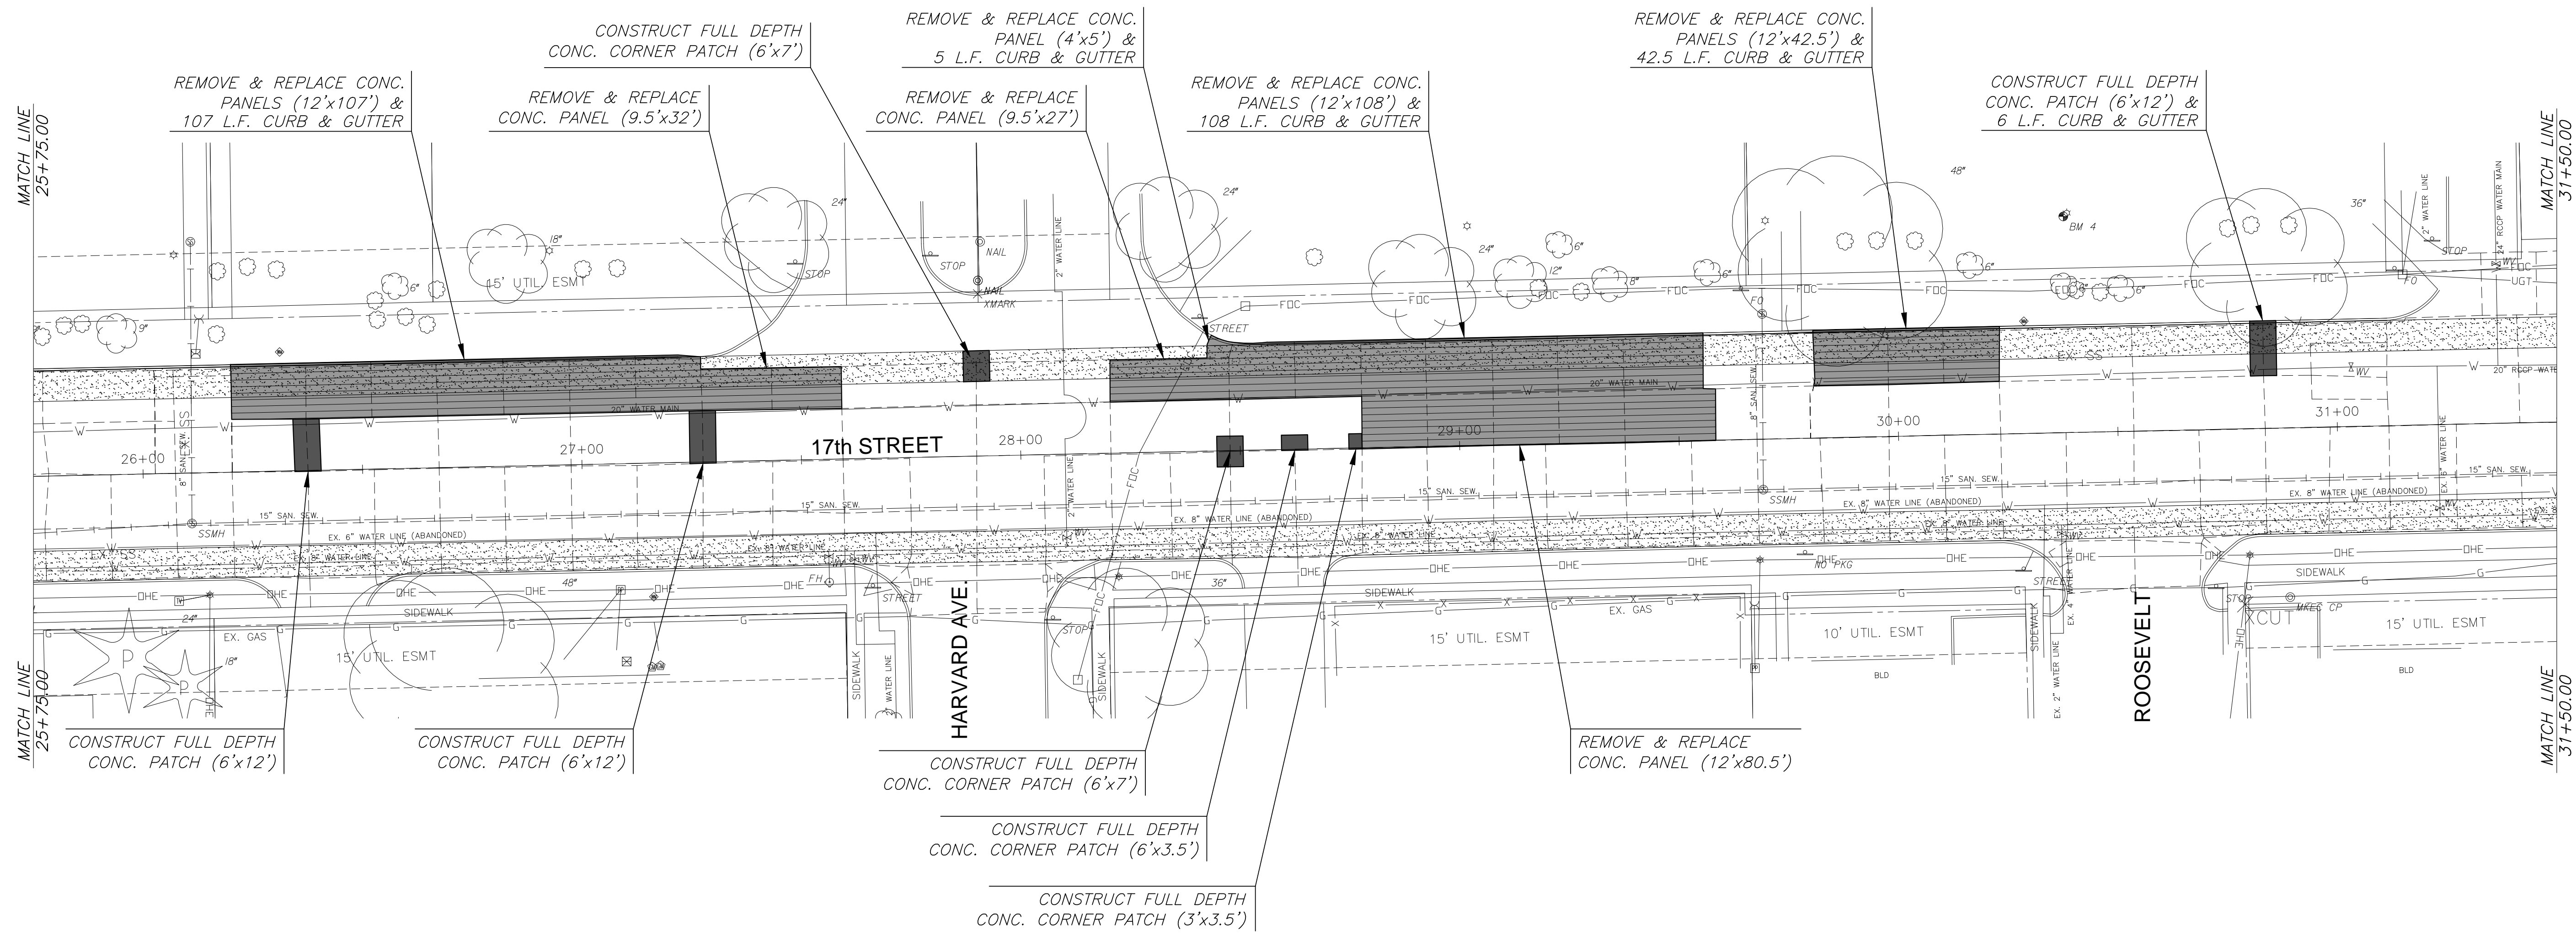


Utility Adjustments				
Station	Offset	Exist. Elev.	Prop. Elev.	Description
26+10.88	11.52' Rt.	1385.60	1385.77	SSMH Adjusted
27+55.79	22.16' Rt.	1386.82	1386.87	WV Adjusted
27+61.62	23.02' Rt.	1386.88	1386.88	WV Adjusted
28+10.06	19.02' Rt.	1387.47	1387.58	WV Adjusted
29+68.95	11.52' Rt.	1390.15	1390.32	SWMH Adjusted/w New Ring & Cover
30+36.67	23.01' Rt.	1391.14	1391.17	WV Adjusted
31+03.41	13.56' Lt.	1391.92	1392.09	WV Adjusted
31+22.96	19.01' Rt.	1392.25	1392.38	WV Adjusted

* CONCRETE CURB, MONO EDGE (6" & 1 1/2") WILL ALSO BE INCLUDED IN SOME OF THESE AREAS.
** CONCRETE CURB, MONO EDGE (SPECIAL) AND CRUSHED ROCK BASE 6", REINFORCED WILL ALSO BE INCLUDED IN SOME OF THESE AREAS.

LEGEND

-  CONCRETE PAVEMENT REMOVED & REPLACED (>16.0 S.Y.) *
-  CONCRETE PAVEMENT REMOVED & REPLACED (≤16.0 S.Y.) *
-  CONCRETE CURB, MONO EDGE, REMOVED & REPLACED
-  CONCRETE SIDEWALK REMOVED & REPLACED
-  PAVEMENT REMOVED & CONCRETE PAVEMENT 9" (REINF.) **
-  CONCRETE PAVEMENT, COLD MILLED
-  REMOVE & REPLACE CONCRETE DRIVEWAY

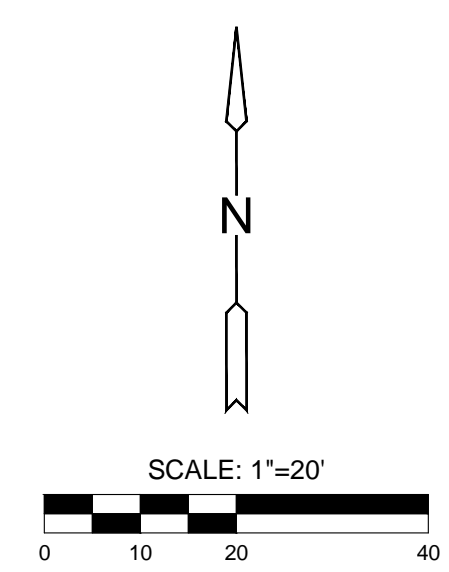

©2017 MKEC Engineering All Rights Reserved www.mkec.com
These drawings and their contents, including, but not limited to, all concepts, designs, & ideas are the exclusive property of MKEC Engineering (MKEC), and may not be used or reproduced in any way without the express consent of MKEC.

PAVING PLAN

PROJECT NO.	472-85215	
DATE	5/3/2017	
SCALE	1"=20'	
DESIGNED	DRAWN	CHECKED
JRA	BKS	BLB
NO.	REVISION	DATE
SHEET NO.		

PLOTTED: Tuesday, May 02, 2017 @ 08:14PM
J:\PROJECTS\2017\1501040177_COW_17TH STREET REHAB_1501040177_CADSHOTS\06_CIVIL\PAV\15177EPA3.DWG