


PLOTTED: Wednesday, January 02, 2019 @ 10:58AM



J:\PROJECTS\2017\17010143_LANES_STEEPLE BAY_17143_CADD\SHS\08_ELECTRICAL LIGHTING\2-03_ELECTRICAL PLANS.DWG

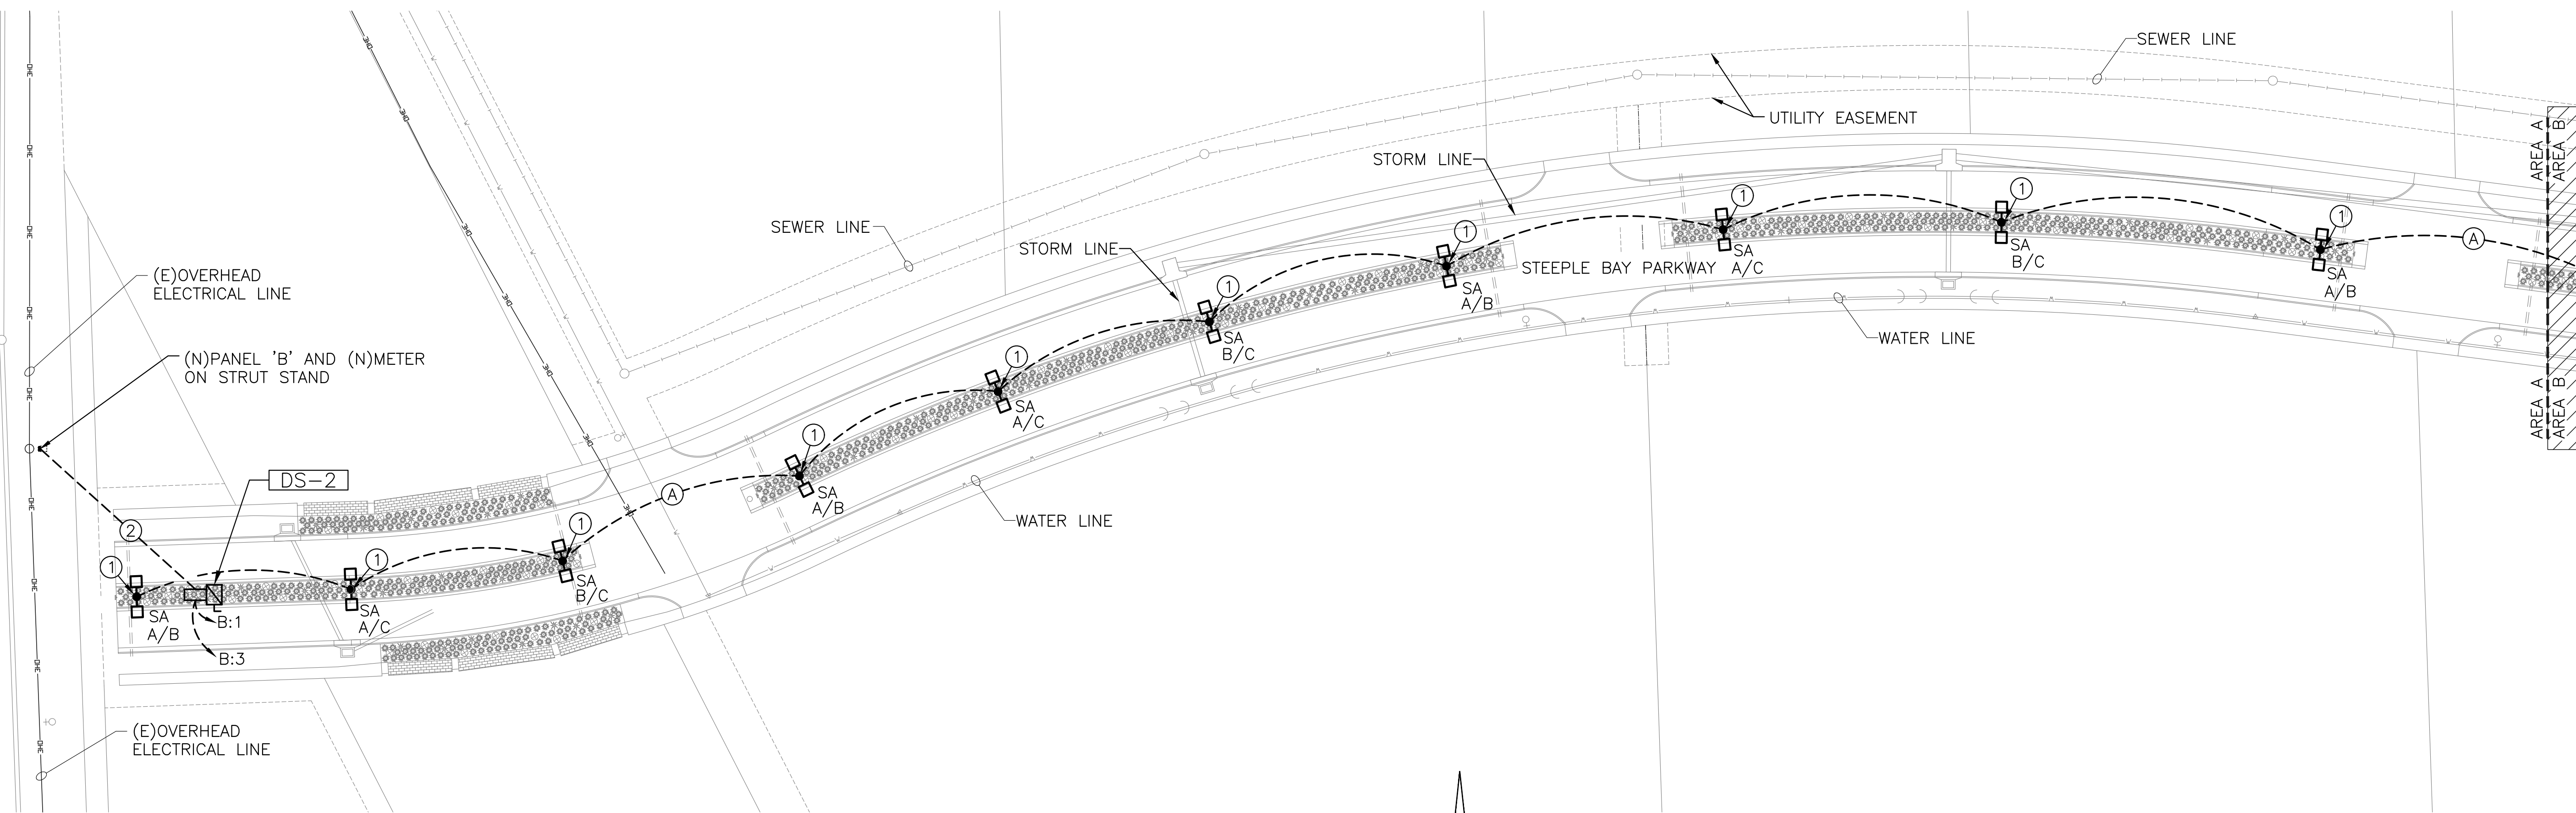

- KEYED NOTES**
1. PROVIDE AND INSTALL POLE BASE PER DETAIL 2/05.
 2. ROUTE (2) 120V FEEDERS FROM PANEL 'B' TO SIGNAGE LOCATION. ROUTE EACH FEEDER WITH (2)-#12, (1)-#12 IN 1" C. PROVIDE FINAL CONNECTION TO SIGN. COORDINATE WITH SIGN VENDOR.

- FEEDER SCHEDULE**
- (A) (3)-#10, (1)-#10 GND IN 1" C. FOR ENTIRE CIRCUIT. CONDUCTORS UPSIZED FOR VOLTAGE DROP.

ELECTRICAL PLAN - AREA A
 SCALE: 1"=40'
 0 40 80

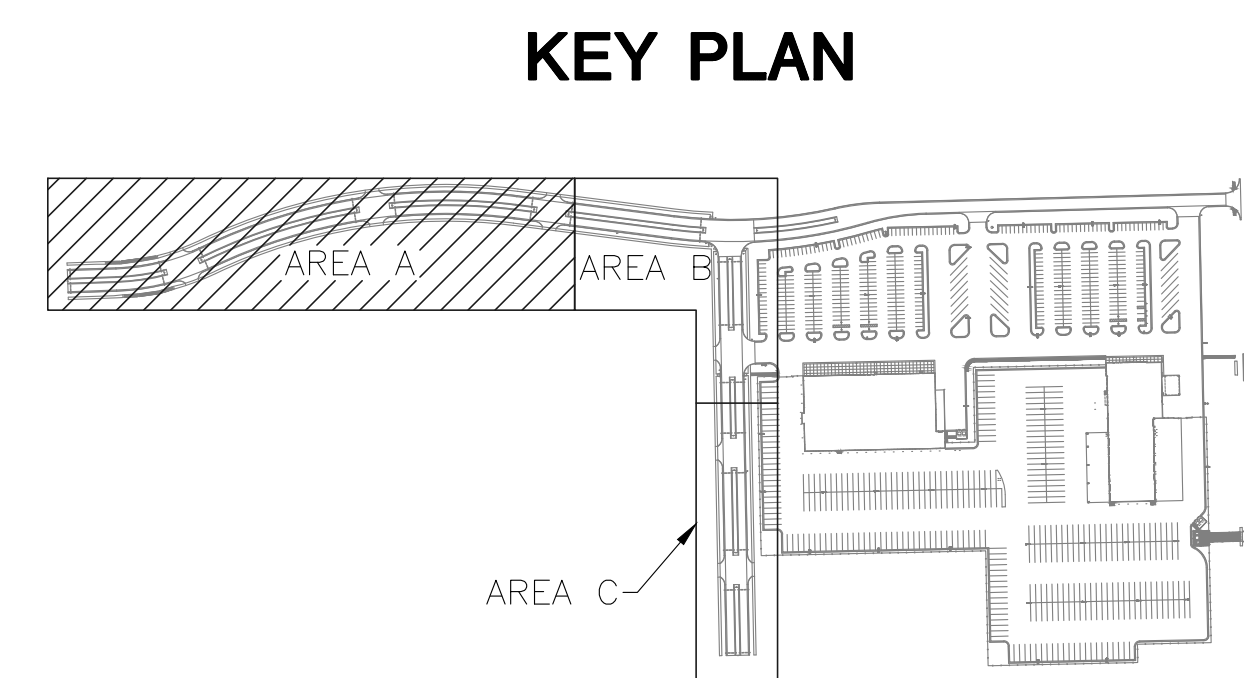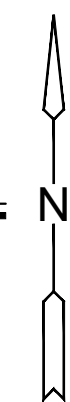

PART A: LIGHTING & LANDSCAPE PLANS FOR
STEEPLE BAY ADDITION
 WICHITA, KANSAS



©2019 MKEC Engineering All Rights Reserved www.mkec.com
 These drawings and their contents, including, but not limited to, all concepts, designs, & ideas are the exclusive property of MKEC Engineering (MKEC), and may not be used or reproduced in any way without the express consent of MKEC.

ELECTRICAL PLANS

PROJECT NO.	472-85453	
DATE	DEC 2018	
SCALE	1"=40'-0"	
DESIGNED	DRAWN	CHECKED
CNG	ECW	JRBW
NO.	REVISION	DATE
SHEET NO.		
03 OF 07		