



PLOTTED: Sunday, July 09, 2017 @ 03:09PM

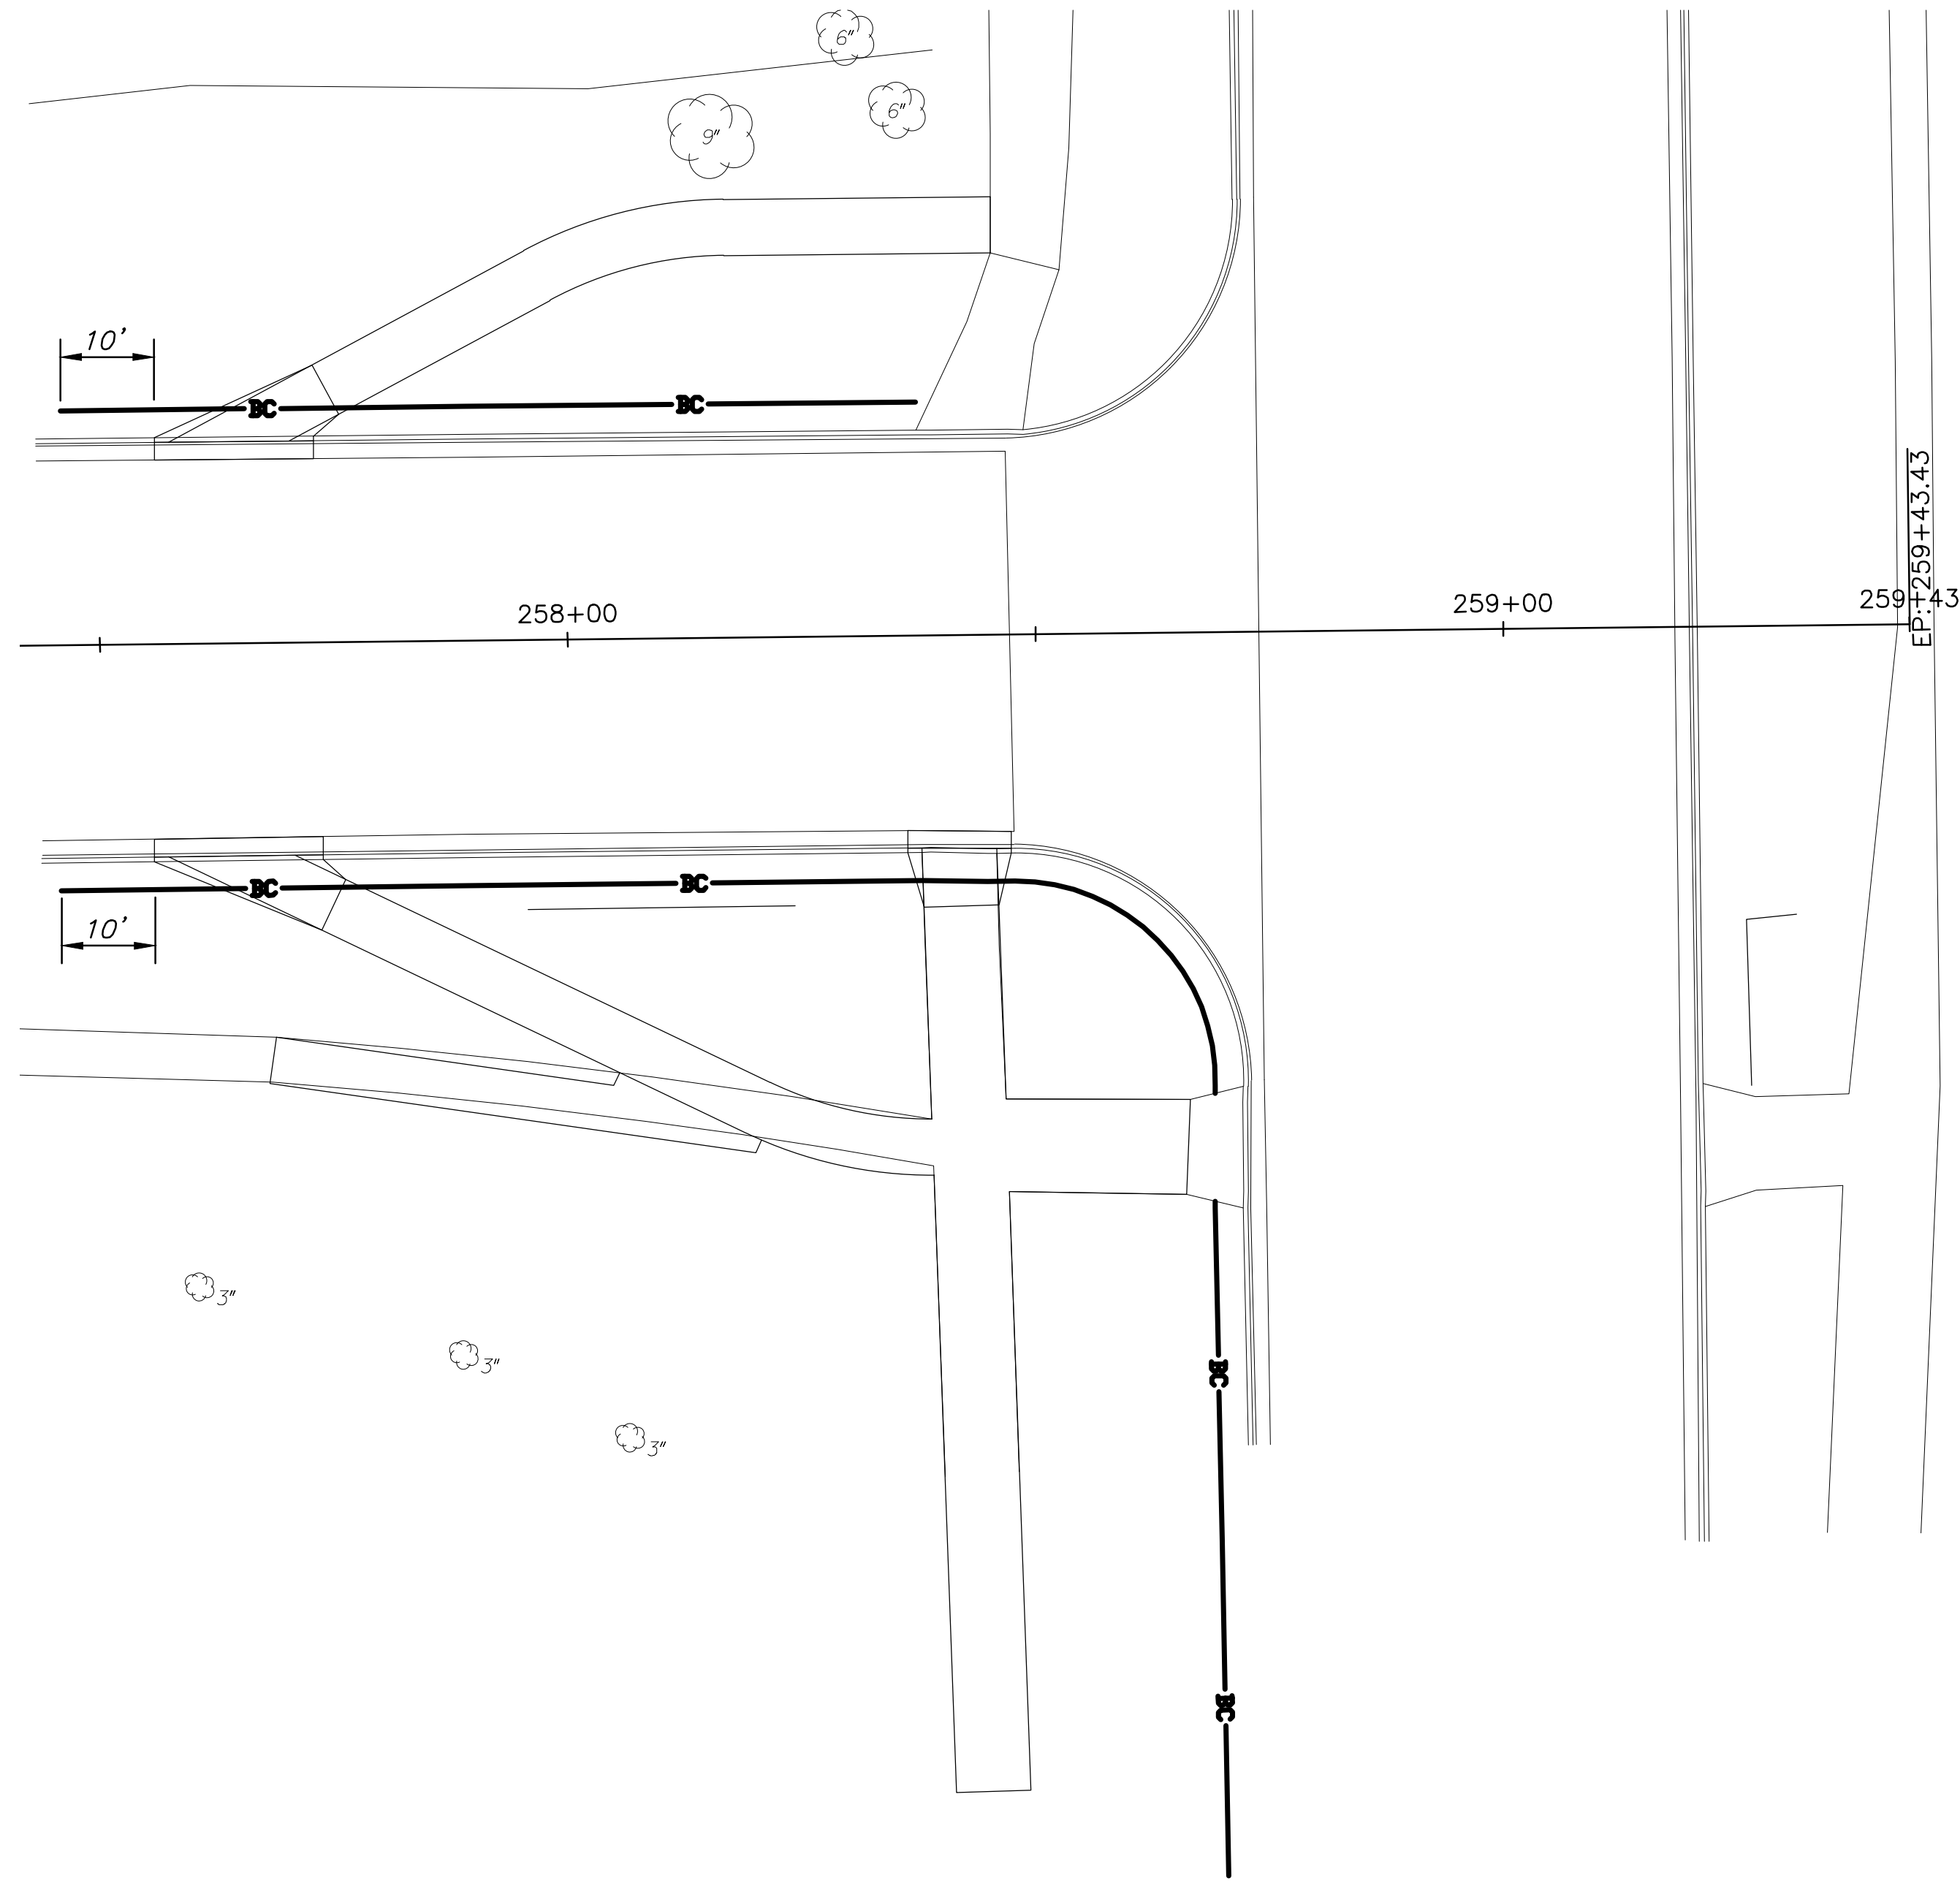

EXISTING SECTION - MT. VERNON

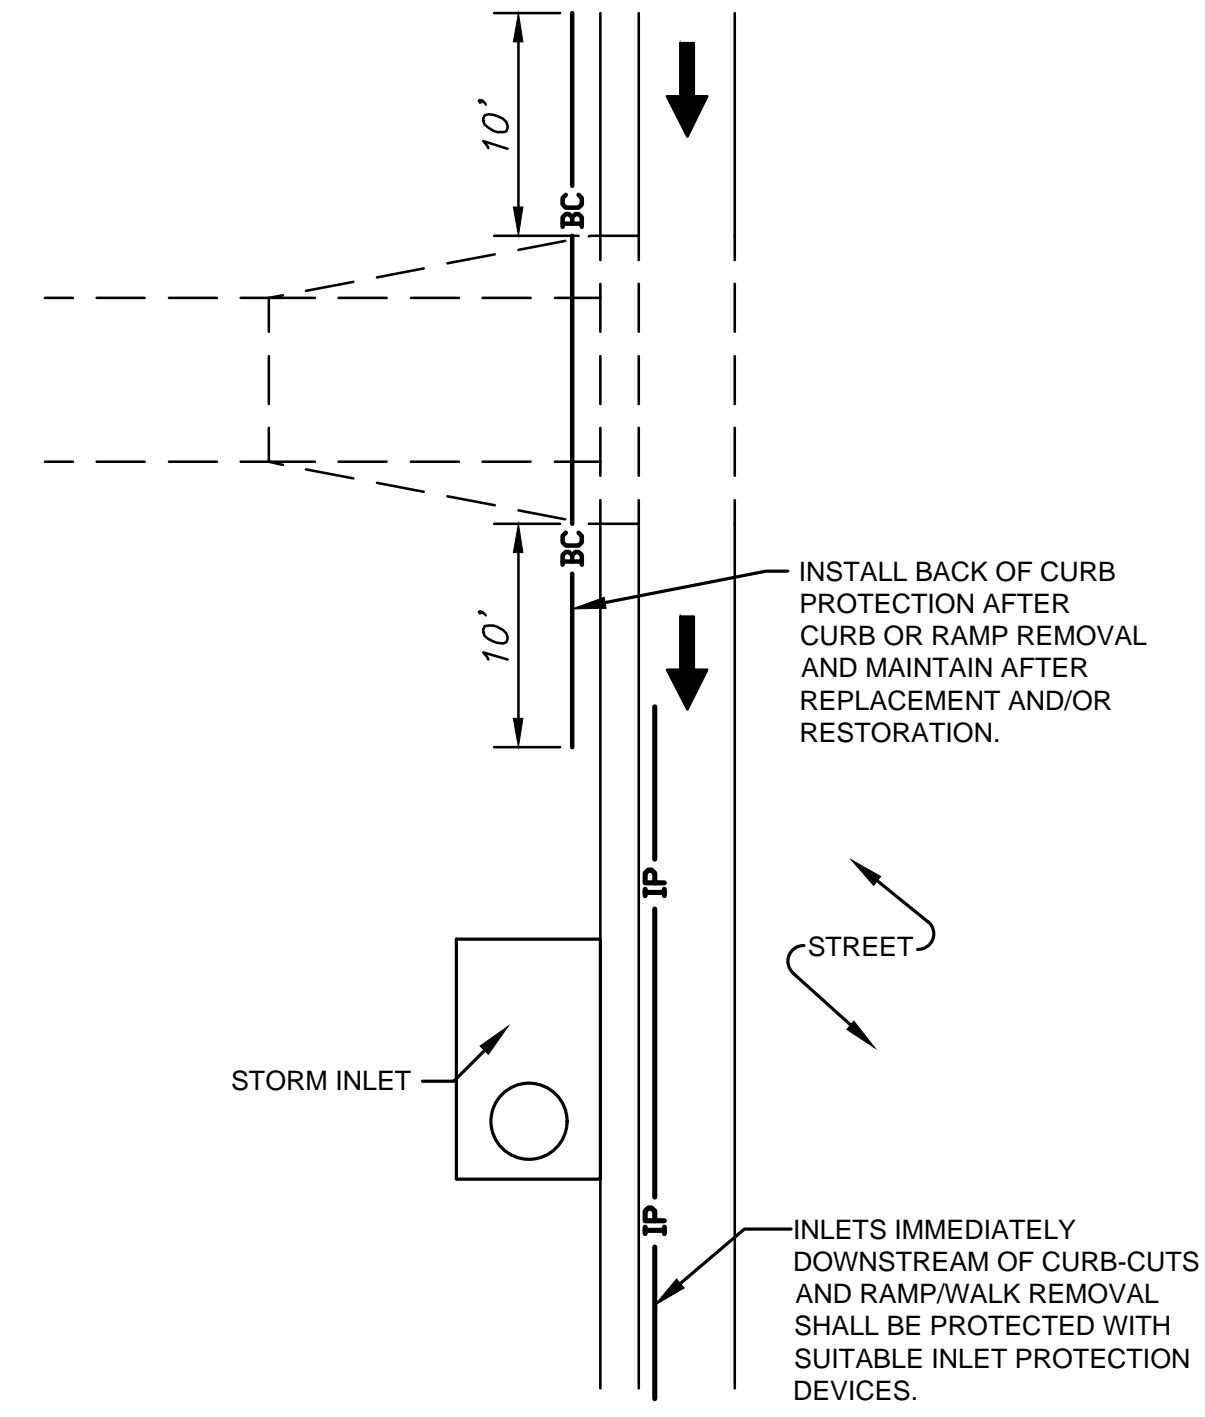

BACK OF CURB PROTECTION - CURB CUT

NOT TO SCALE

EROSION CONTROL/SEEDING NOTES

1. THIS PROJECT WILL DISTURB < 1.0 ACRES.
2. REFER TO CITY OF WICHITA STANDARDS FOR BMP INSTALLATION, INSPECTION, AND MAINTENANCE DETAILS AND SPECIFICATIONS.
3. COST FOR EACH EROSION AND SEDIMENT CONTROL ITEM SHALL INCLUDE MAINTENANCE, INSPECTION, AND EVENTUAL REMOVAL. BESIDES KEEPING EACH DEVICE IN WORKING ORDER, MAINTENANCE SHALL INCLUDE, AT A MINIMUM, SEDIMENT REMOVAL BEFORE 50% OF THE DEVICE'S CAPACITY IS REACHED.
4. CONTRACTOR SHALL ADJUST EROSION AND SEDIMENT CONTROL PLANS TO CONFORM TO ACTUAL CONSTRUCTION OPERATIONS. ALL CHANGES TO PLAN SHALL BE APPROVED BY THE CITY.
5. SMALL AND INTERIM STOCK PILES NOT IMMEDIATELY HAULED OFF-SITE SHOULD BE ENCLOSED AND PROTECTED WITH SILT BARRIERS AROUND THE ENTIRE CIRCUMFERENCE OF THE STOCK PILE. INSTALLING AND MAINTAINING THIS FENCE SHALL BE CONSIDERED SUBSIDIARY TO THE BID ITEM "EROSION CONTROL BMP (SILT BARRIER)".

EROSION CONTROL BMP SUMMARY

ITEMS	QUANTITY	UNIT
BMP, Back of Curb Protection	2500	L.F.
BMP, Curb Inlet Protection	7	Each
BMP, Silt Fence	100	L.F.

LEGEND

- FLOW ARROW
- BACK OF CURB PROTECTION
- DROP INLET PROTECTION

J:\PROJECTS\2017\1301040541_Mt_Vernon_Bike_Lanes\CAD\EROSION\13541_IP.DWG

©2017
MKEC Engineering
All Rights Reserved
www.mkec.com
These drawings and their contents, including, but not limited to, all concepts, designs, & ideas are the exclusive property of MKEC Engineering (MKEC), and may not be used or reproduced in any way without the express consent of MKEC.

EROSION CONTROL PLAN

PROJECT NO. 472-85295

DATE JULY 7, 2017

SCALE 1"=15'

DESIGNED JRA DRAWN RAM CHECKED JRA

NO. REVISION DATE

SHEET NO.