


PLOTTED: Wednesday, August 28, 2019 @ 12:24PM

J:\PROJECTS\2017\170101043_LANGLAGE_STEEPLE BAY_17143_CADD\SHS10 BUILDING MEP\BRIDGE PLANS\1 - ELECTRICAL POWER PLAN.DWG

KEYED NOTES

1. SEE CIVIL SHEETS FOR FIXTURE MOUNTING ON COLUMN AND SPECIFICATIONS.
2. SEE CIVIL SHEETS FOR RECEPTACLE MOUNTING ON COLUMN.
3. ROUTE CIRCUIT THROUGH NEW CONTACTOR 'LC-1.' REFER TO DETAIL #1/E2.
4. ROUTE CIRCUIT THROUGH NEW CONTACTOR 'RC-1.' REFER TO DETAIL #2/E2.
5. CONTACTORS SHALL BE PROVIDED IN NEMA 3R ENCLOSURES WITH TIME CLOCKS. MOUNT PHOTOCELL TO UNISTRUT STAND FACING NORTH.

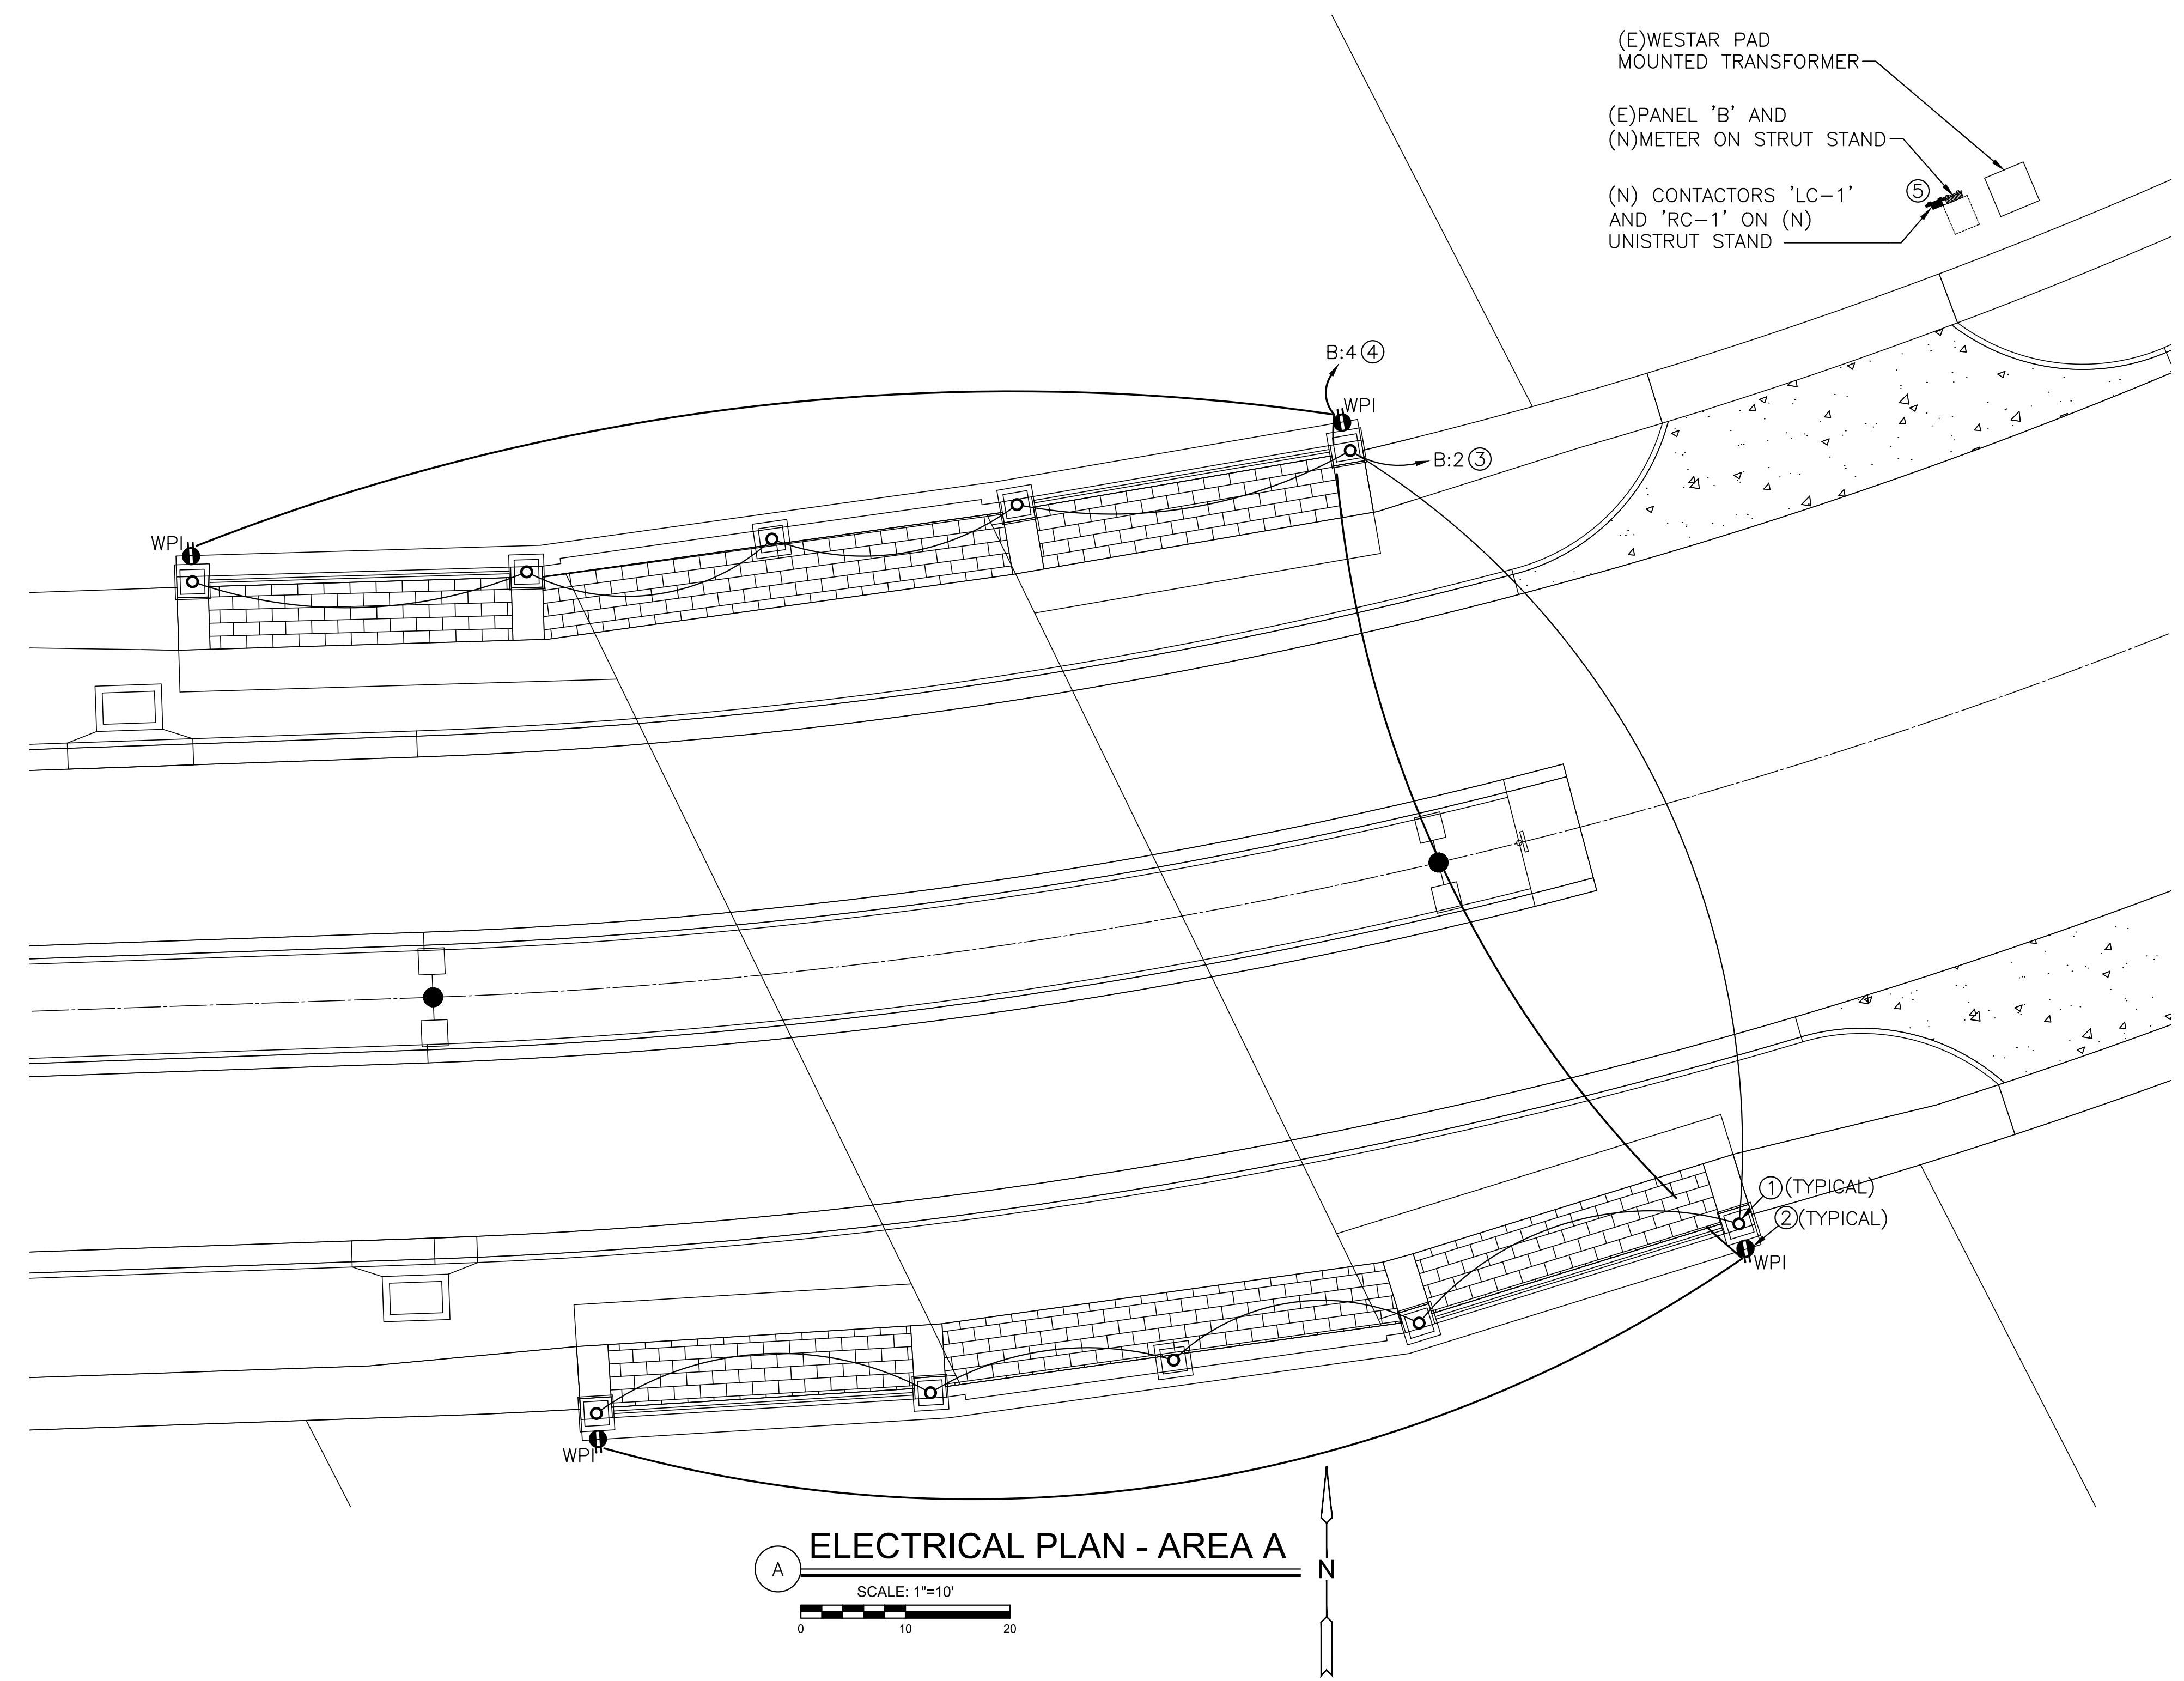

©2019
MKEC Engineering
All Rights Reserved
www.mkec.com
These drawings and their contents, including, but not limited to, all concepts, designs, & ideas are the exclusive property of MKEC Engineering (MKEC), and may not be used or reproduced in any way without the express consent of MKEC.

ELECTRICAL POWER PLAN

PROJECT NO.	472-85452	
DATE	AUGUST 2019	
SCALE	1" = 10'	
DESIGNED	DRAWN	CHECKED
MKEC	MKEC	JRBW

NO.	REVISION	DATE

SHEET NO.
11 OF 12

A ELECTRICAL PLAN - AREA A

