


PLOTTED: Friday, July 26, 2019 @ 02:10PM

J:\PROJECTS\2018\1801010315\_COW\_2ND ST. BRIDGE AT BROOKSIDE\180316 CAD\SHS\05 CIVIL\EROSION\18315\_FR01.DWG

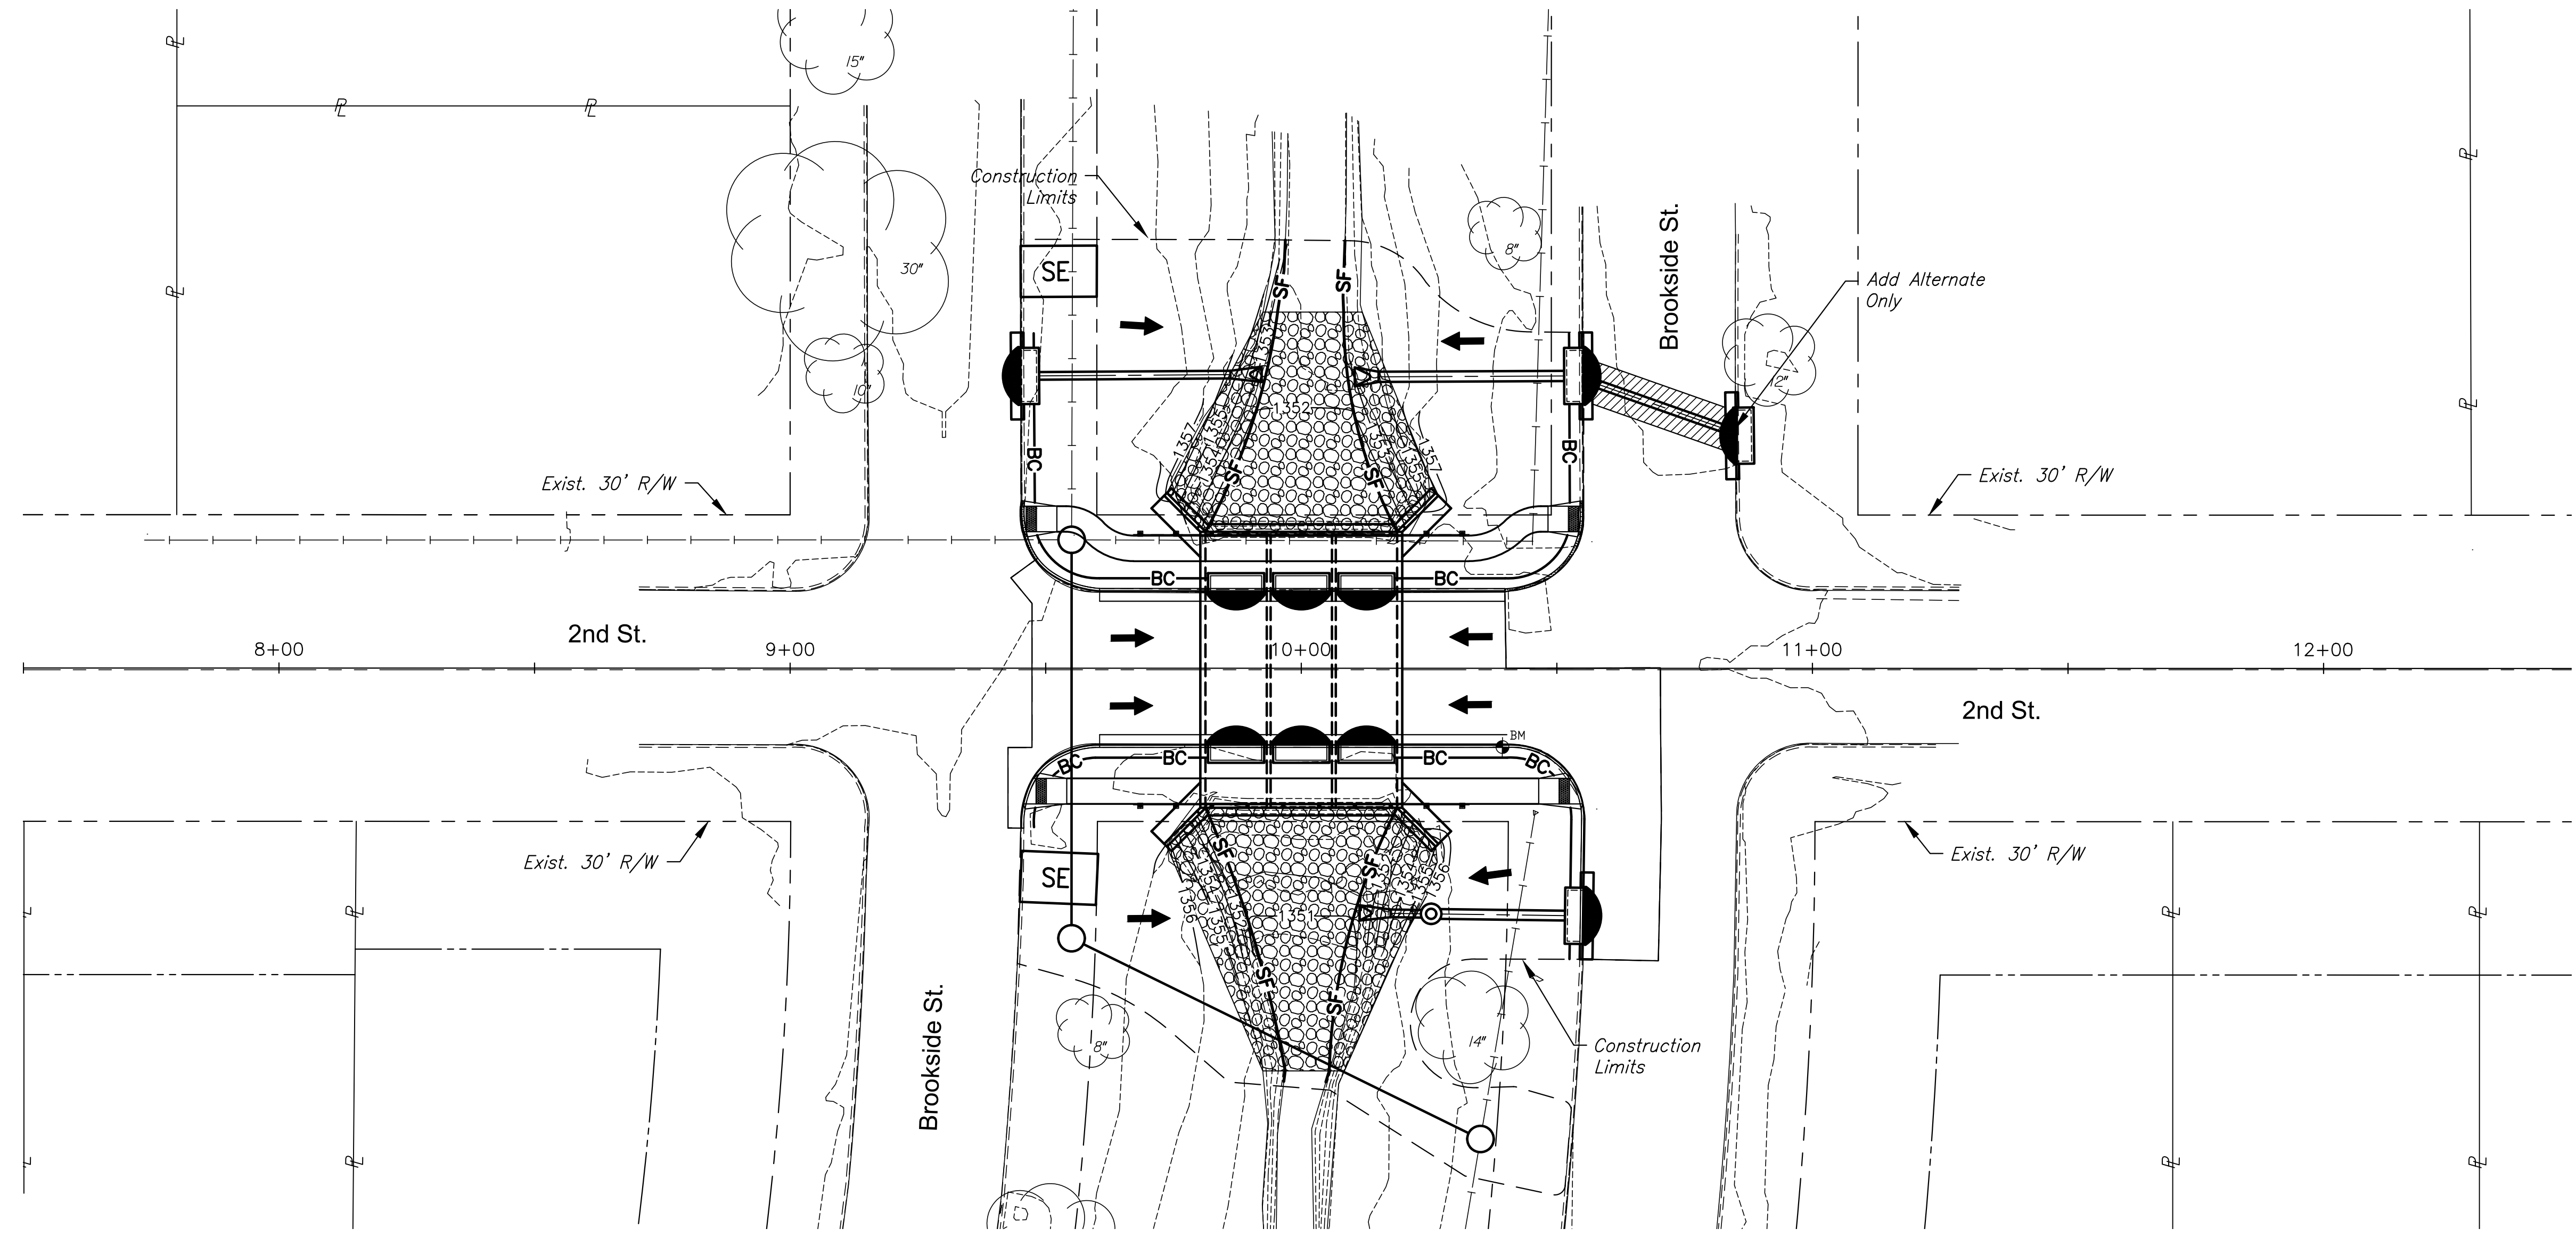

**EROSION CONTROL NOTES**

This project will not disturb more than 0.40 acres area within construction limits.

Refer to City of Wichita standards for bmp installation, inspection and maintenance details and specifications.

Cost for each erosion and sediment control item shall include maintenance, inspection and eventual removal. besides keeping each device in working order, maintenance shall include, at a minimum, sediment removal before 50% of the device's capacity is reached.

Contractor shall adjust erosion and sediment control plans to conform to actual construction operations. all changes to plan shall be approved by the city.

Stabilized entrances shall be provided as directed by the city. 2 total entrances are anticipated on the project.

Stockpiling of excavated material on the project site is generally prohibited. small and interim stock piles not immediately hauled off-site should be enclosed and protected with silt barrier around the entire circumference of the stock pile. installing and maintaining this fence shall be considered Subsidiary to the bid item "bmp, silt fence". The bid quantities do not account for fence for this purpose.

Erosion control devices will need to be installed as applicable for the appropriate construction phase. contractor shall adjust erosion and sediment control plan to conform to actual construction operations. once installed, the devices shall remain in-place and continue to be maintained until no longer necessary as determined by the city.

All areas disturbed by construction that are adjacent to developed properties shall be restored with sod to match existing turf type. restoration of disturbed areas shall include but not be limited to, top soil preparation and sodding. all sodding work shall be in accordance with city standard specifications and the city administrative regulation no. ar6.5, which governs cleanup and restoration or replacement following construction. the "recapitulation of quantities" shows the estimated square yards of sodding, with a bid item for the same. when the weather/season prevents the installation of sod, the contractor shall be responsible for installing erosion control blanket (curlex i, or approved equal) at the back of curb ( 8" wide minimum). all cost for erosion mat installation shall be subsidiary to "site restoration".

The contractor shall reseed all undeveloped areas disturbed by construction with a mixture of ryegrass (applied at a rate of 200 lbs. per acre) and buffalo grass, depending on the soil conditions (applied at a rate of 200 lbs. per acre) and buffalo grass, depending on the soil conditions (applied per standard specifications). pure nitrogen fertilizer shall also be applied at a rate of 1.5 lbs. per thousand square feet. the seed shall be watered with a deep soaking every two (2) weeks during dry periods until a mature stand of grass is obtained. the "recapitulation of quantities" shows the estimated square yards of disturbed area to be seeded, with a bid item for the same. the permanent seeding may be omitted only if sodding is required. the contractor shall be responsible for installing erosion control blanket (curlex i, or approved equal) at the back of curb, to and including the limits of all seeded areas. all costs for this work shall be subsidiary to the seeding bid items.

EROSION CONTROL BMP SUMMARY		
ITEMS	QUANTITY	UNIT
BMP, Back of Curb Protection	205	L.F.
BMP, Silt Fence	231	L.F.
BMP, Curb Inlet Protection	9	Each
BMP, Construction Entrance	2	Each

ADD ALTERNATE SUMMARY		
ITEMS	QUANTITY	UNIT
BMP, Curb Inlet Protection	1	Each

**LEGEND**

- FLOW ARROW
- BACK OF CURB PROTECTION
- SILT FENCE
- CURB INLET PROTECTION
- DROP INLET PROTECTION
- CONST. LIMITS
- STABILIZED ENTRANCE



CONSTRUCTION PLANS FOR  
**2ND STREET BRIDGE AT BROOKSIDE**  
 WICHITA, KS

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**EROSION CONTROL PLAN**

PROJECT NO.	472-85435	
DATE	JULY 2019	
SCALE	1"=20'	
DESIGNED	DRAWN	CHECKED
JRA	RAM	JRA
NO.	REVISION	DATE
SHEET NO.		
32 OF 48		