




BASE FOR STANDARD CATCH BASIN
TYPE B

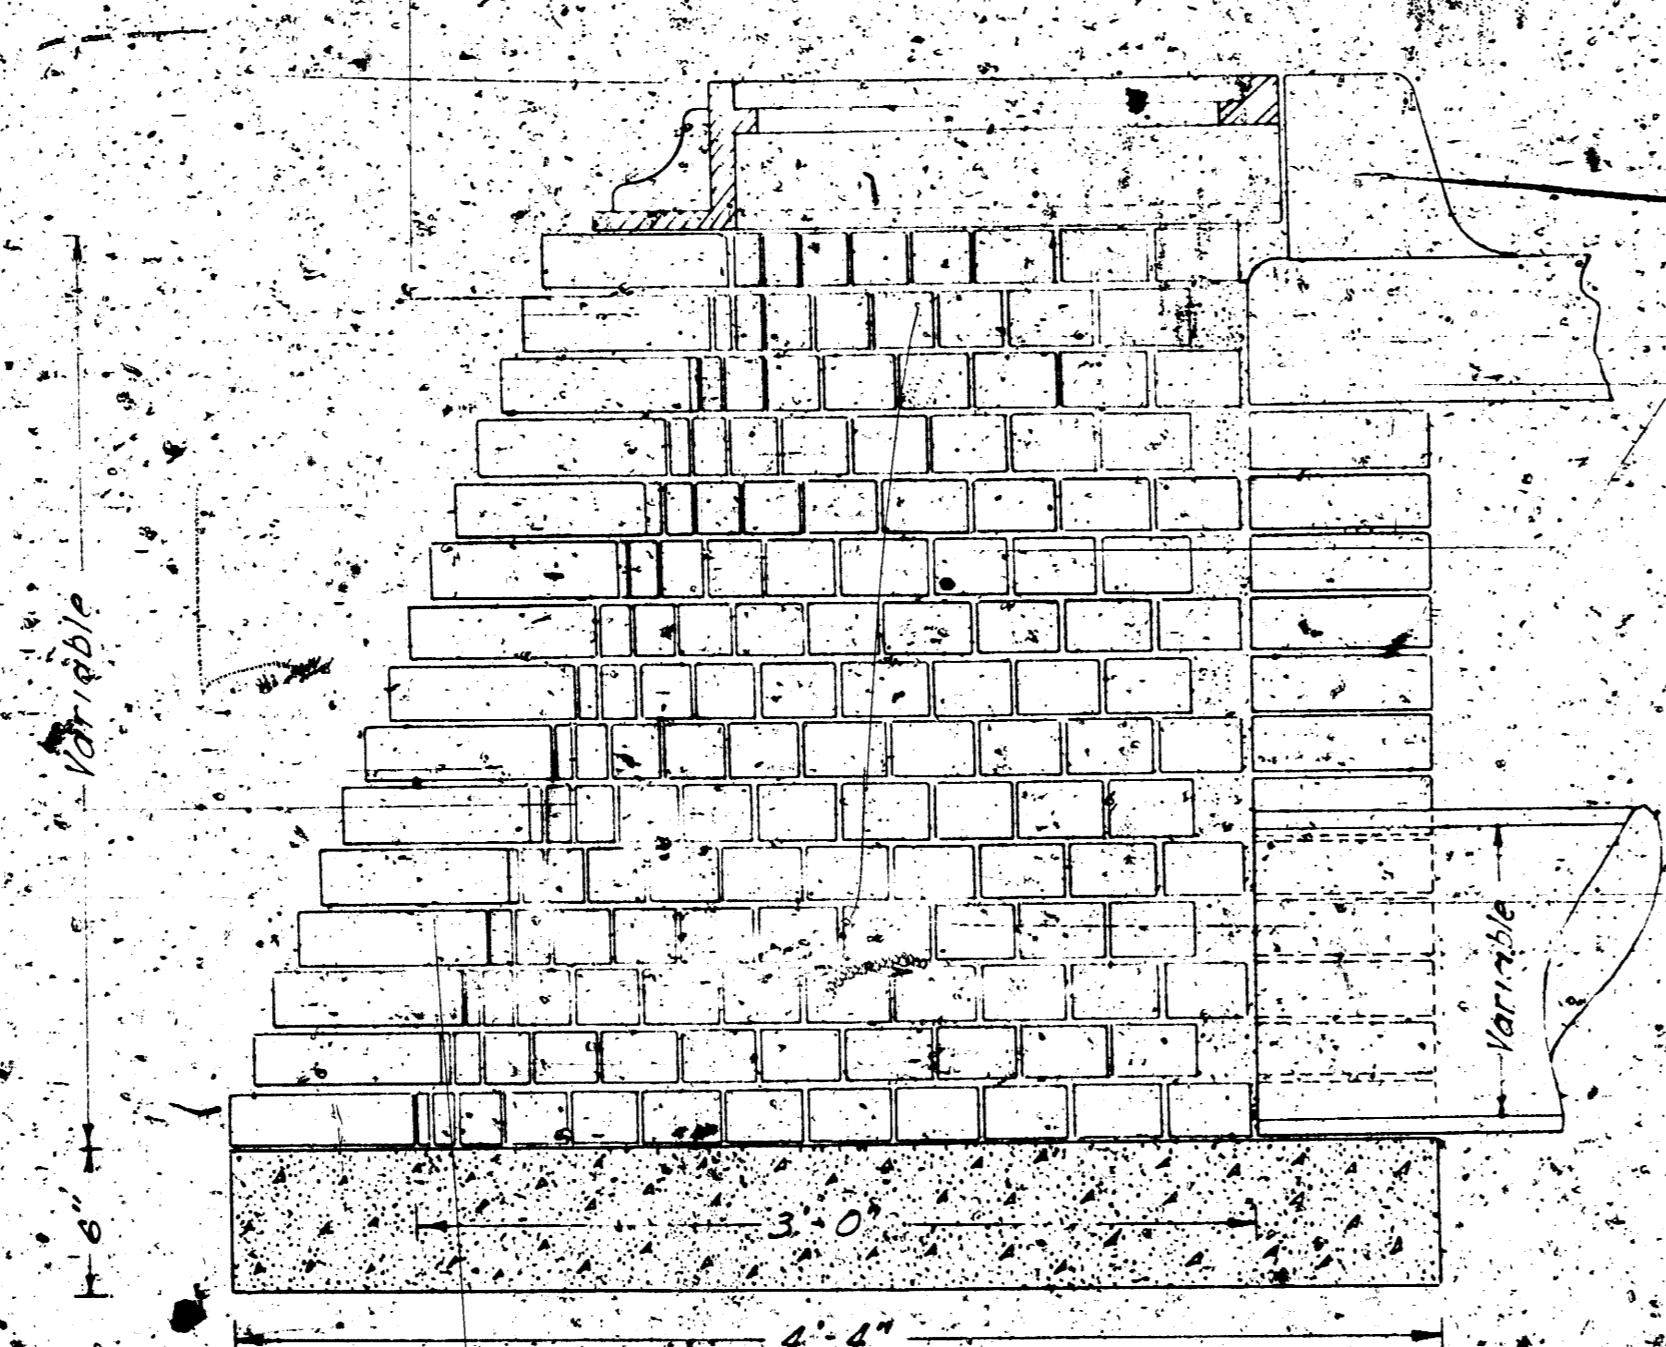


CROSS SECTION OF STANDARD CATCH BASIN
TYPE B

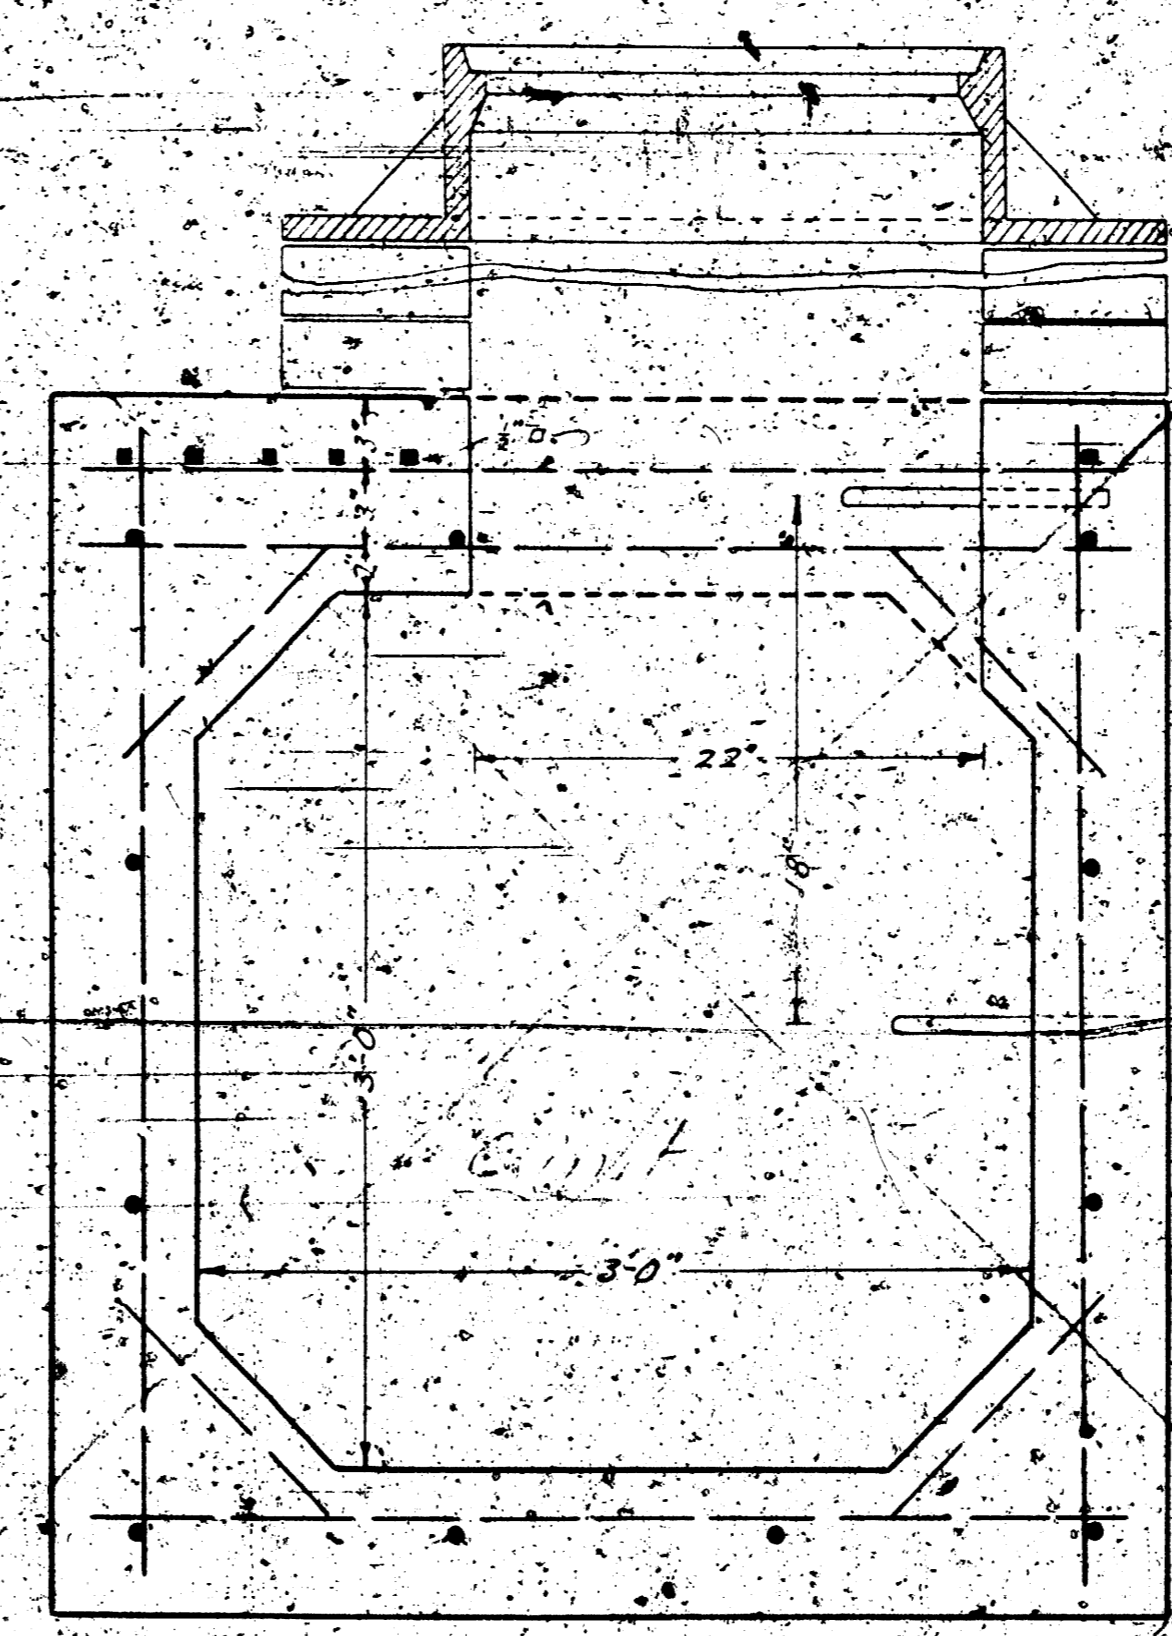


CROSS SECTION OF CONCRETE BOX
SHOWING MANHOLE CONSTRUCTION

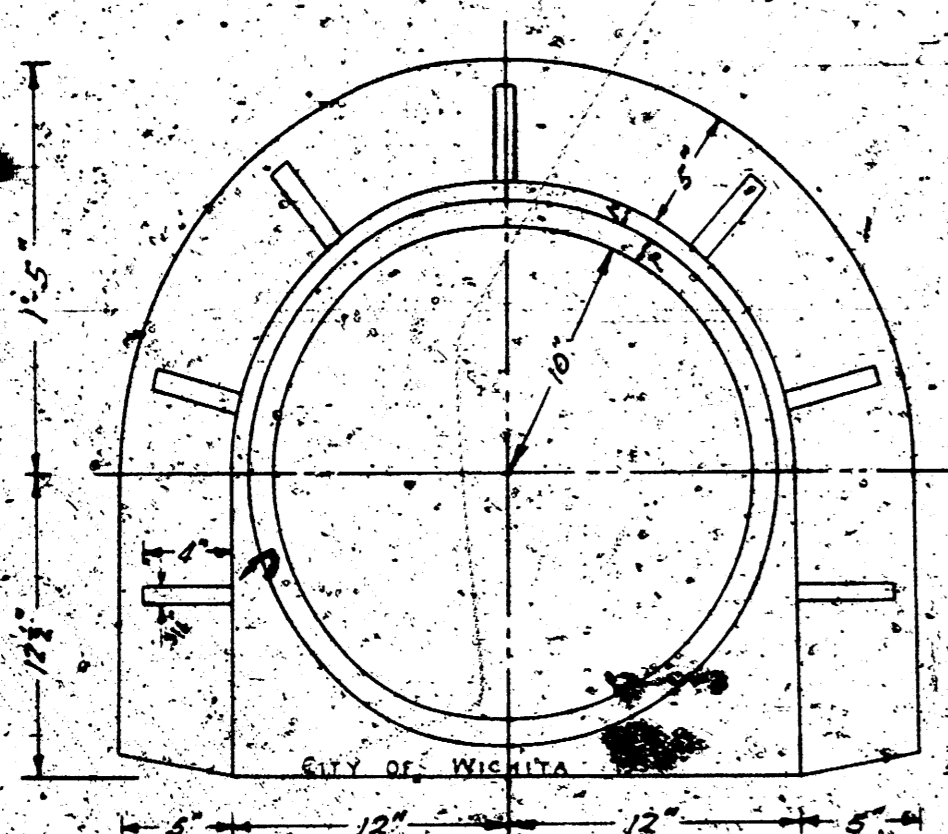


PLAN OF CATCH BASIN FRAME
TYPE B

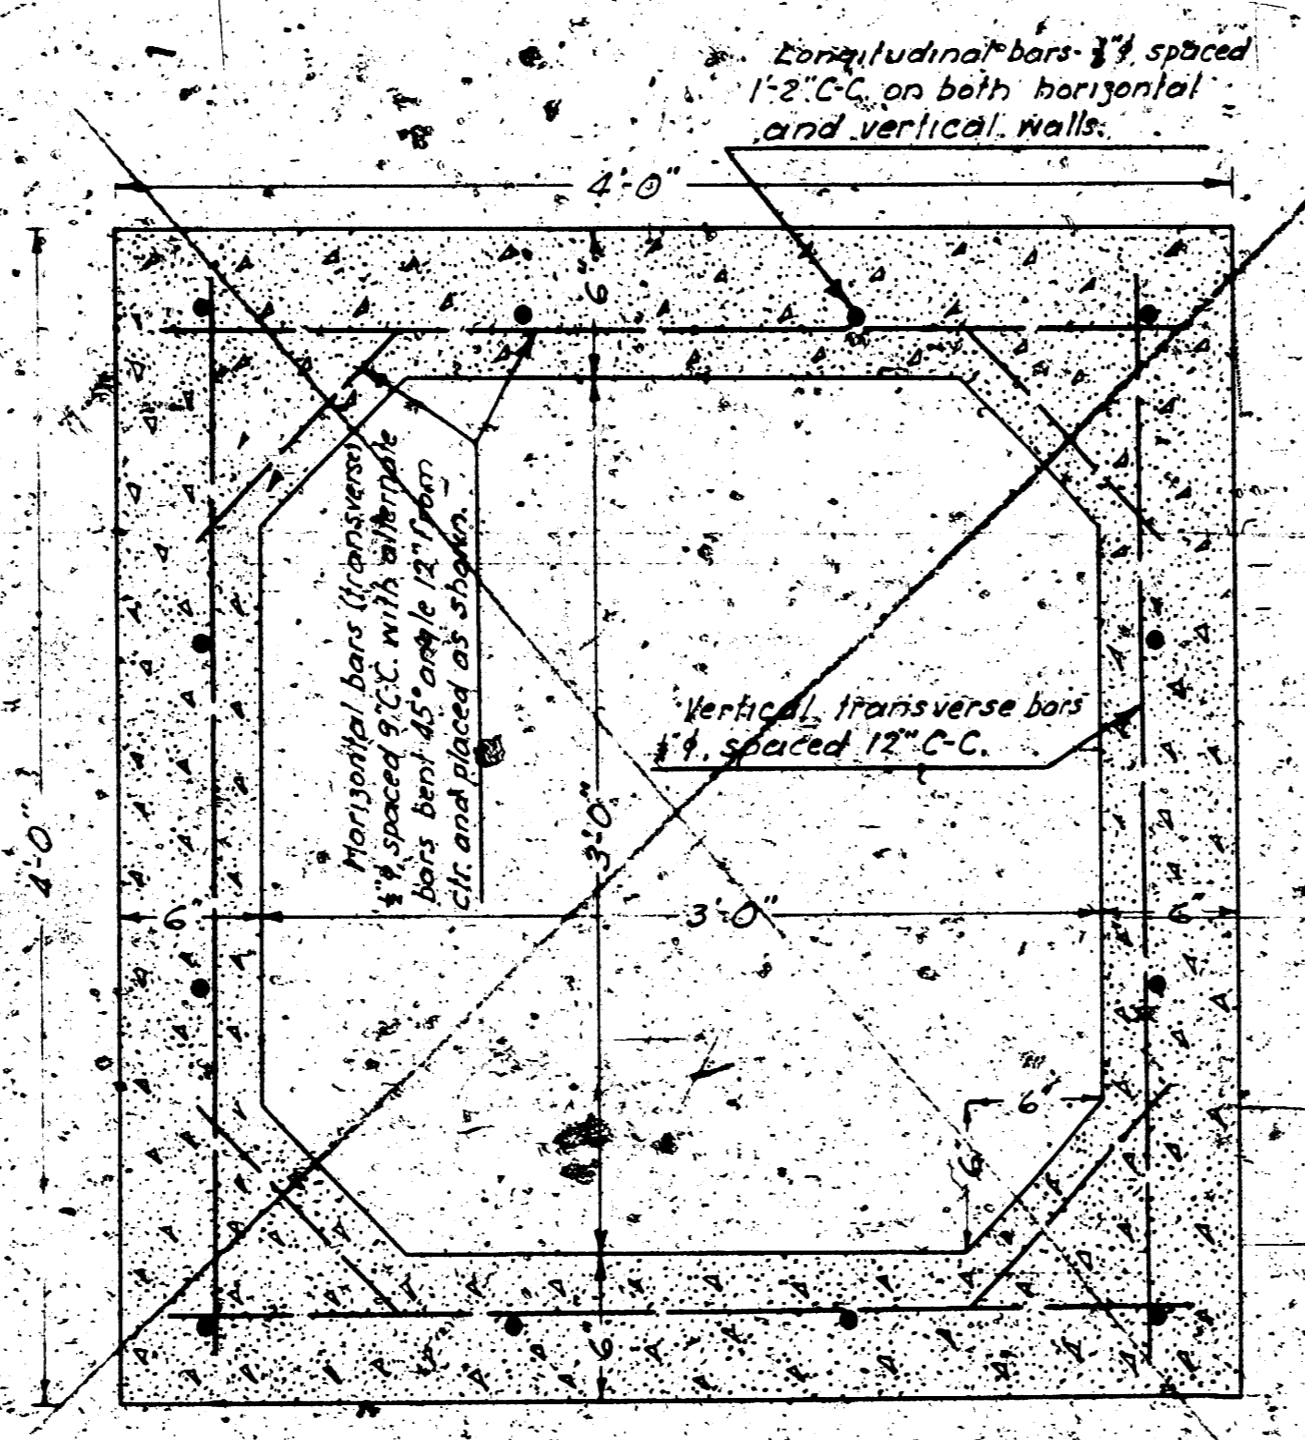


CROSS SECTION OF CONCRETE BOX
576 D12-78 Sep. 13-02

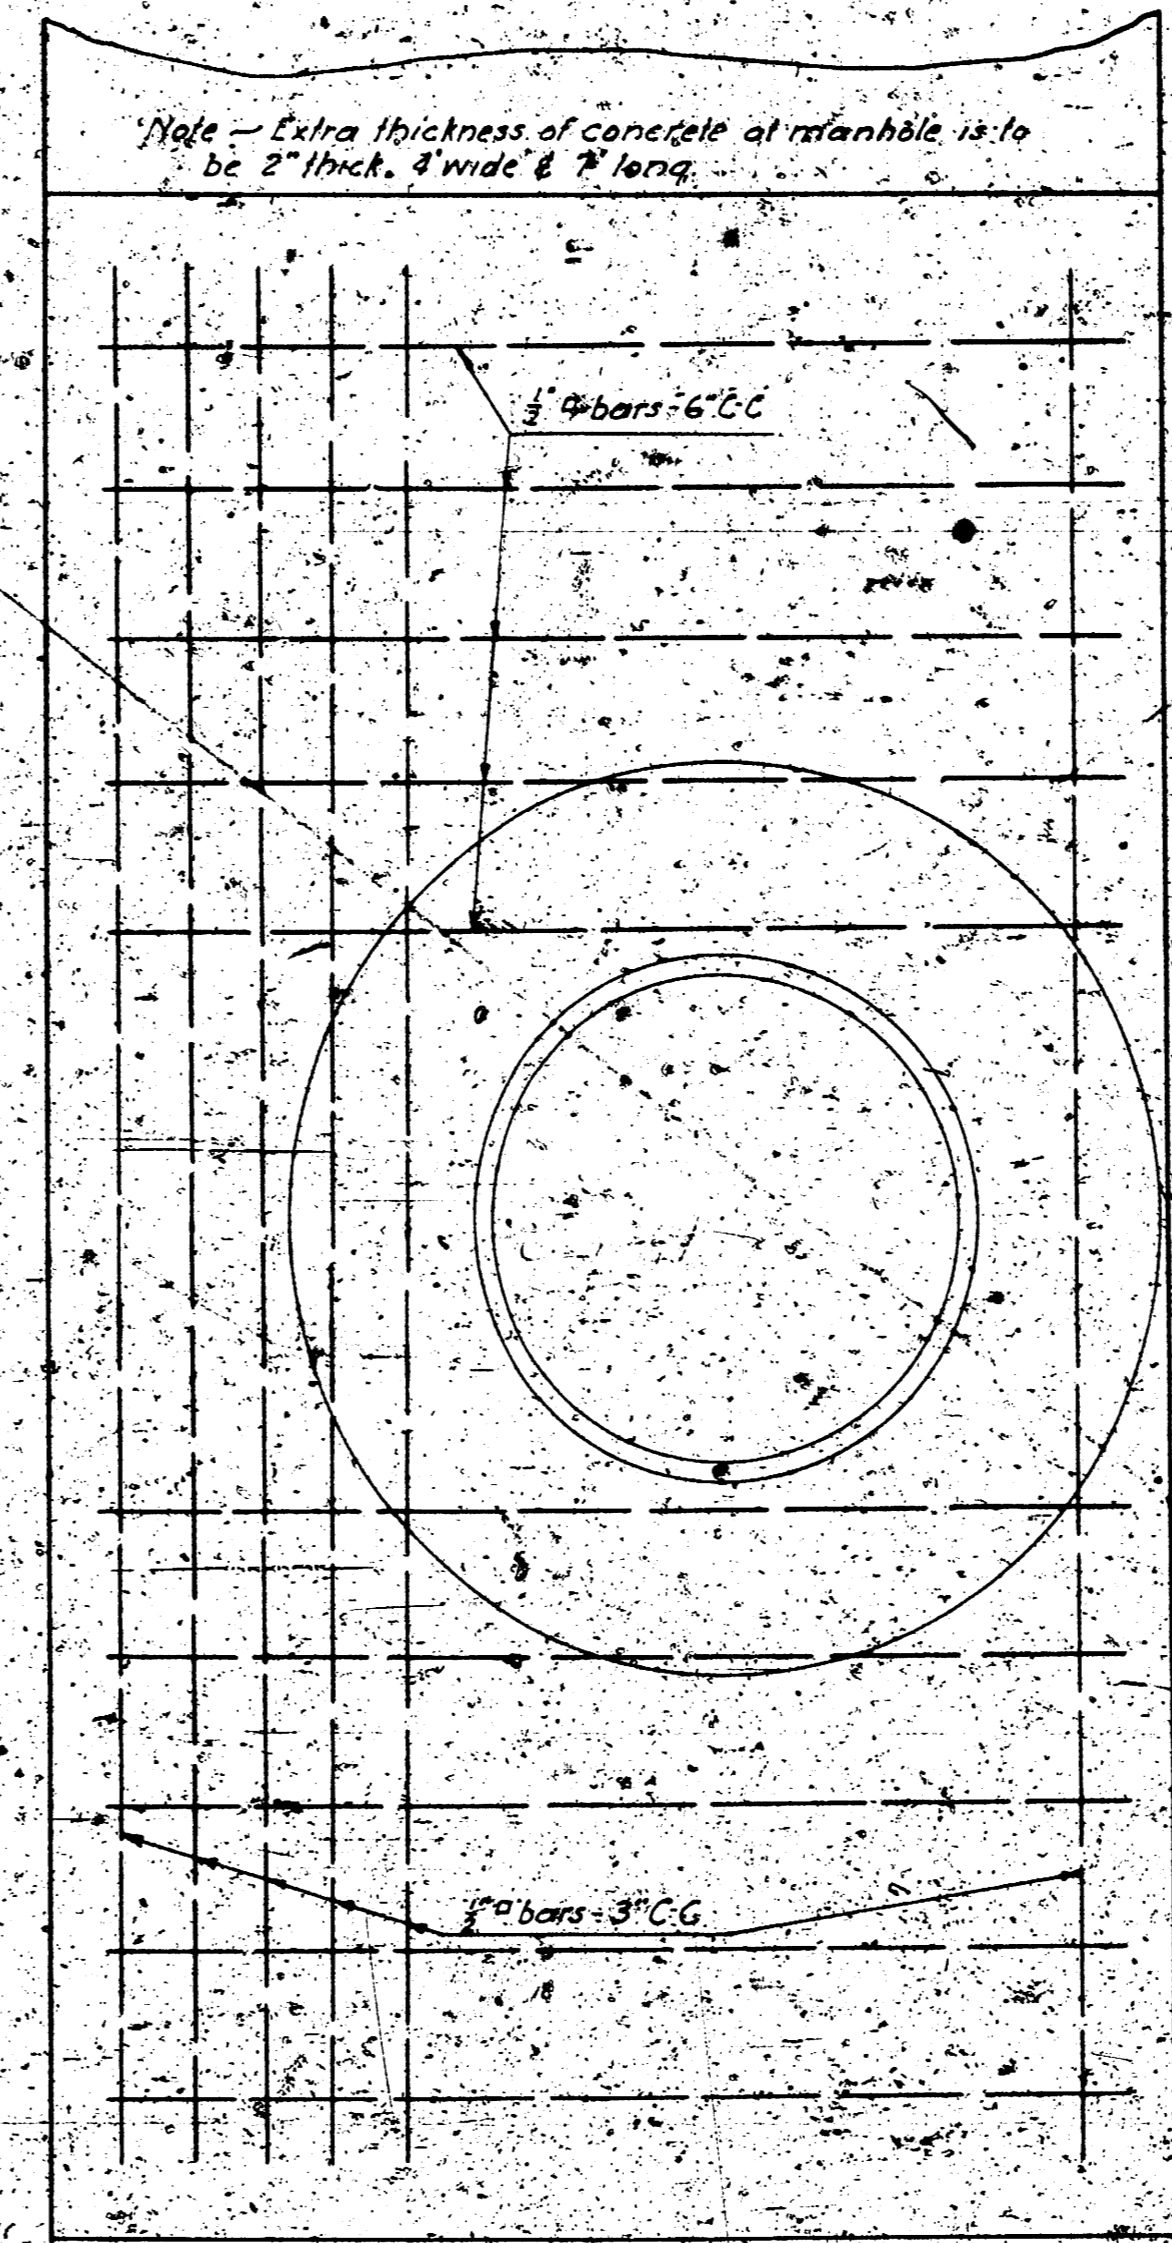


PLAN OF EXTRA REINFORCING AT MANHOLE

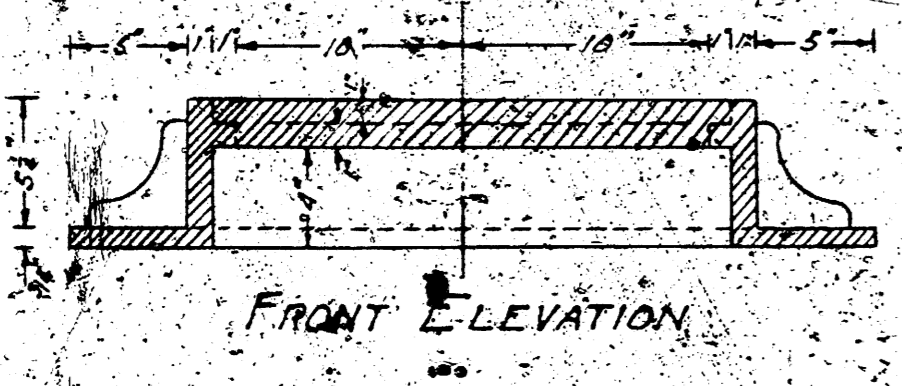

FRONT ELEVATION

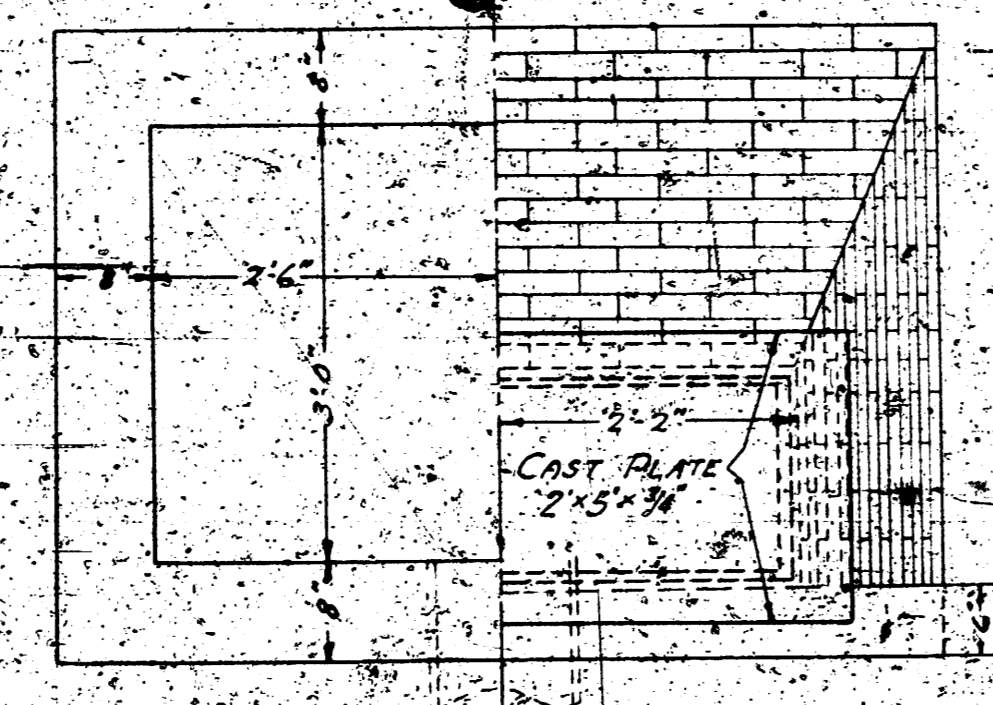


ONE-HALF PLAN OF TYPE A INLET
SCALE 1/4" = 1'-0"

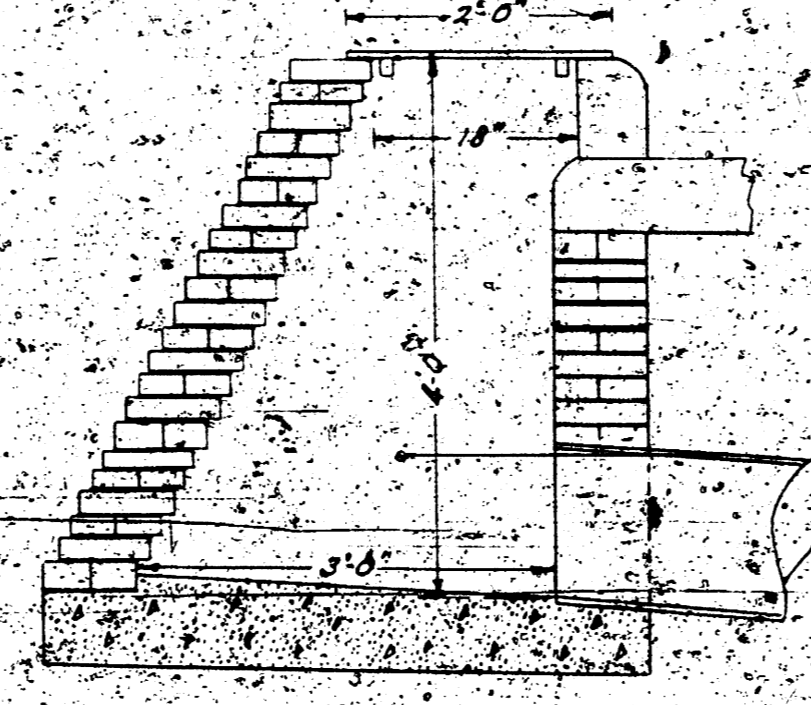


SIDE VIEW OF TYPE A INLET
SCALE 1/4" = 1'-0"

PLAN
 DRAWN BY: [illegible]
 CHECKED BY: [illegible]
 DATE: [illegible]

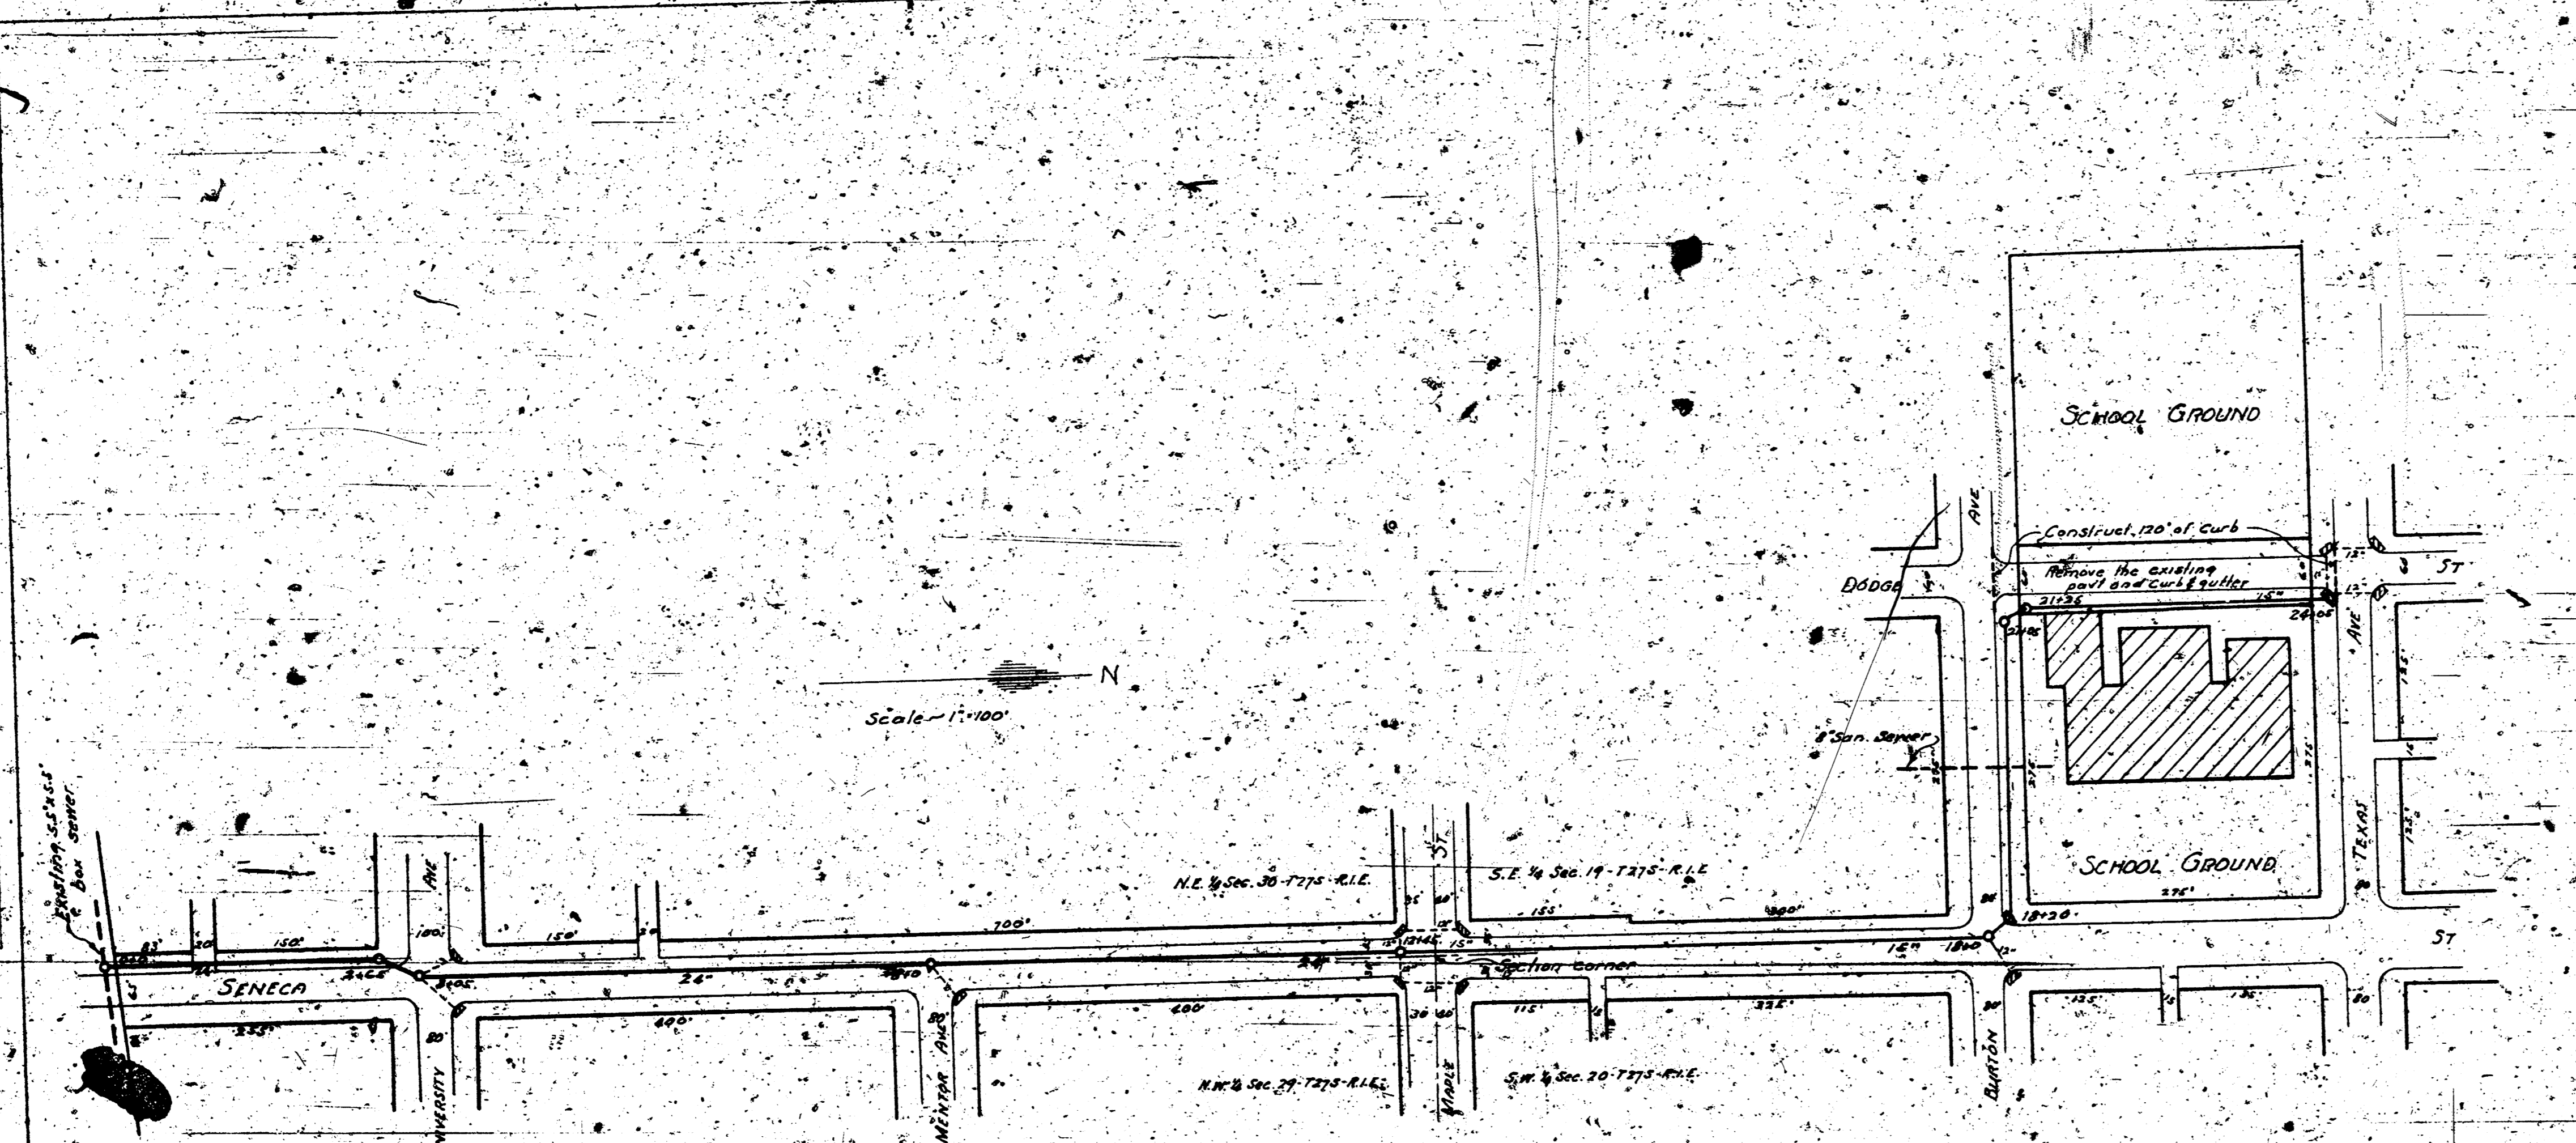

Engineering Department
 City of Wichita, Kansas
 P. C. Strickland, City Engineer

PROFILE
 DRAWN BY: [illegible]
 CHECKED BY: [illegible]
 DATE: [illegible]

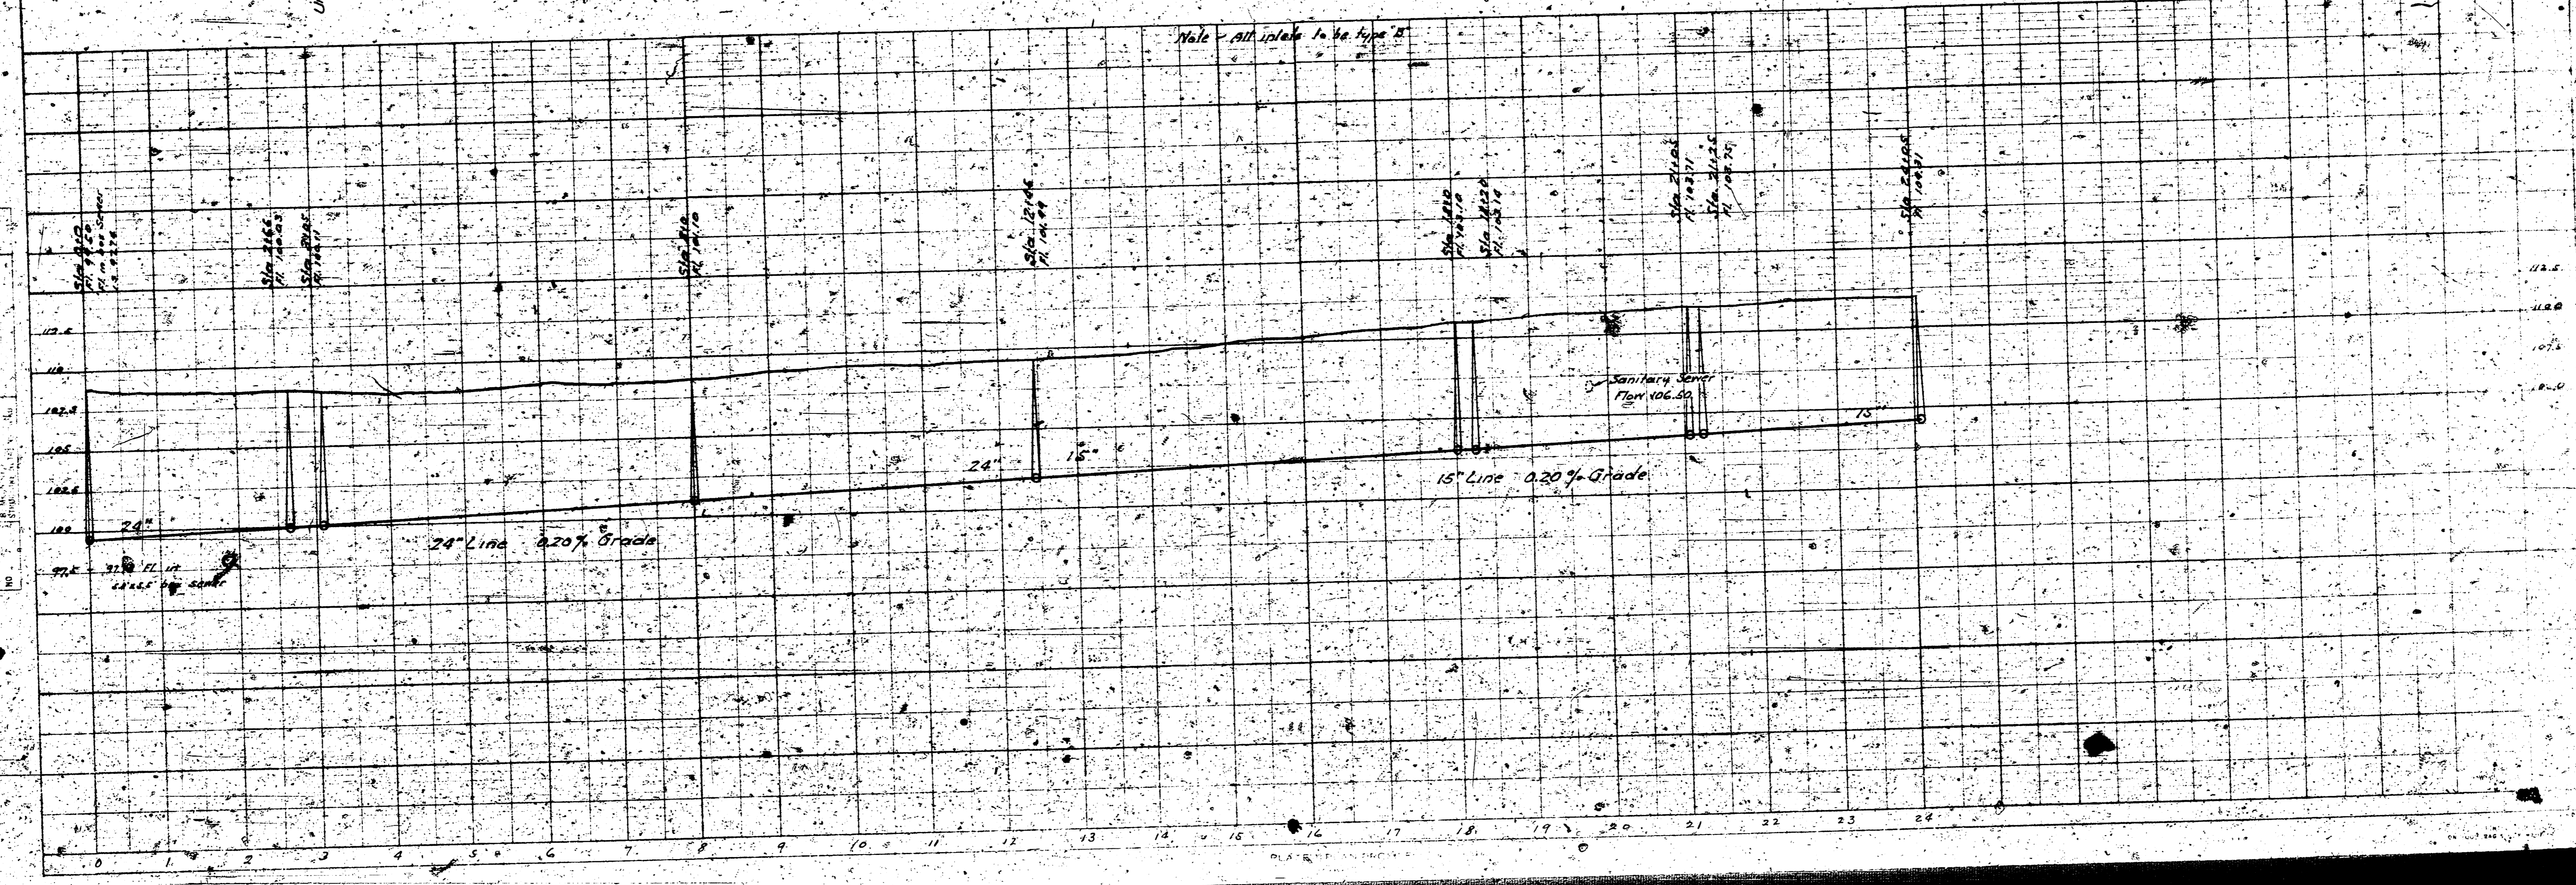

STORM WATER SEWER AND SURFACE DRAINAGE CITY OF WICHITA

Sheet 1 of 2

