




SITE PLAN
PRIVATE STORM SEWER
7TH SERVE
TANGLEWOOD APTS.
WICHITA, KANSAS

MOHRING & ASSOC.
314 BOONVILLE BLVD.
WICHITA, KANSAS
REGISTERED ENGINEER

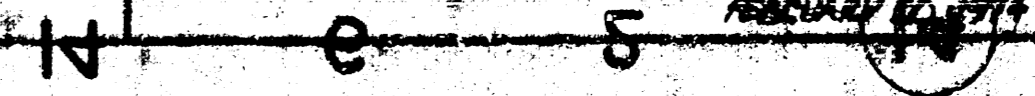

DATE: _____
 BY: _____
 CHECKED: _____
 IN CHARGE: _____
 PROJECT: _____
 SHEET NO. _____ OF _____
 TITLE: _____

DATE: _____
 BY: _____
 CHECKED: _____
 IN CHARGE: _____
 PROJECT: _____
 SHEET NO. _____ OF _____
 TITLE: _____

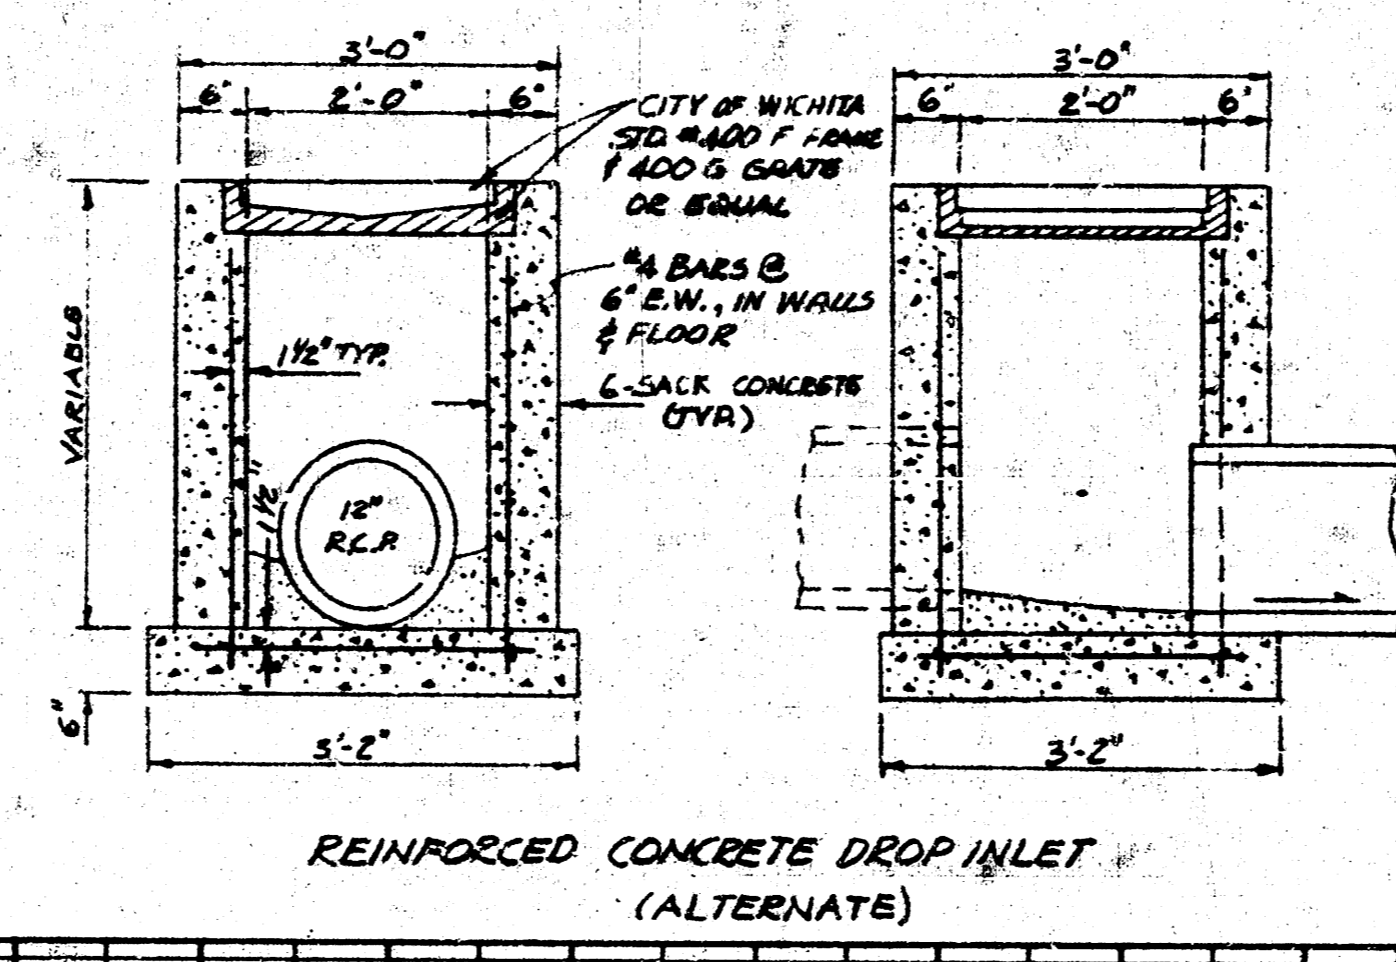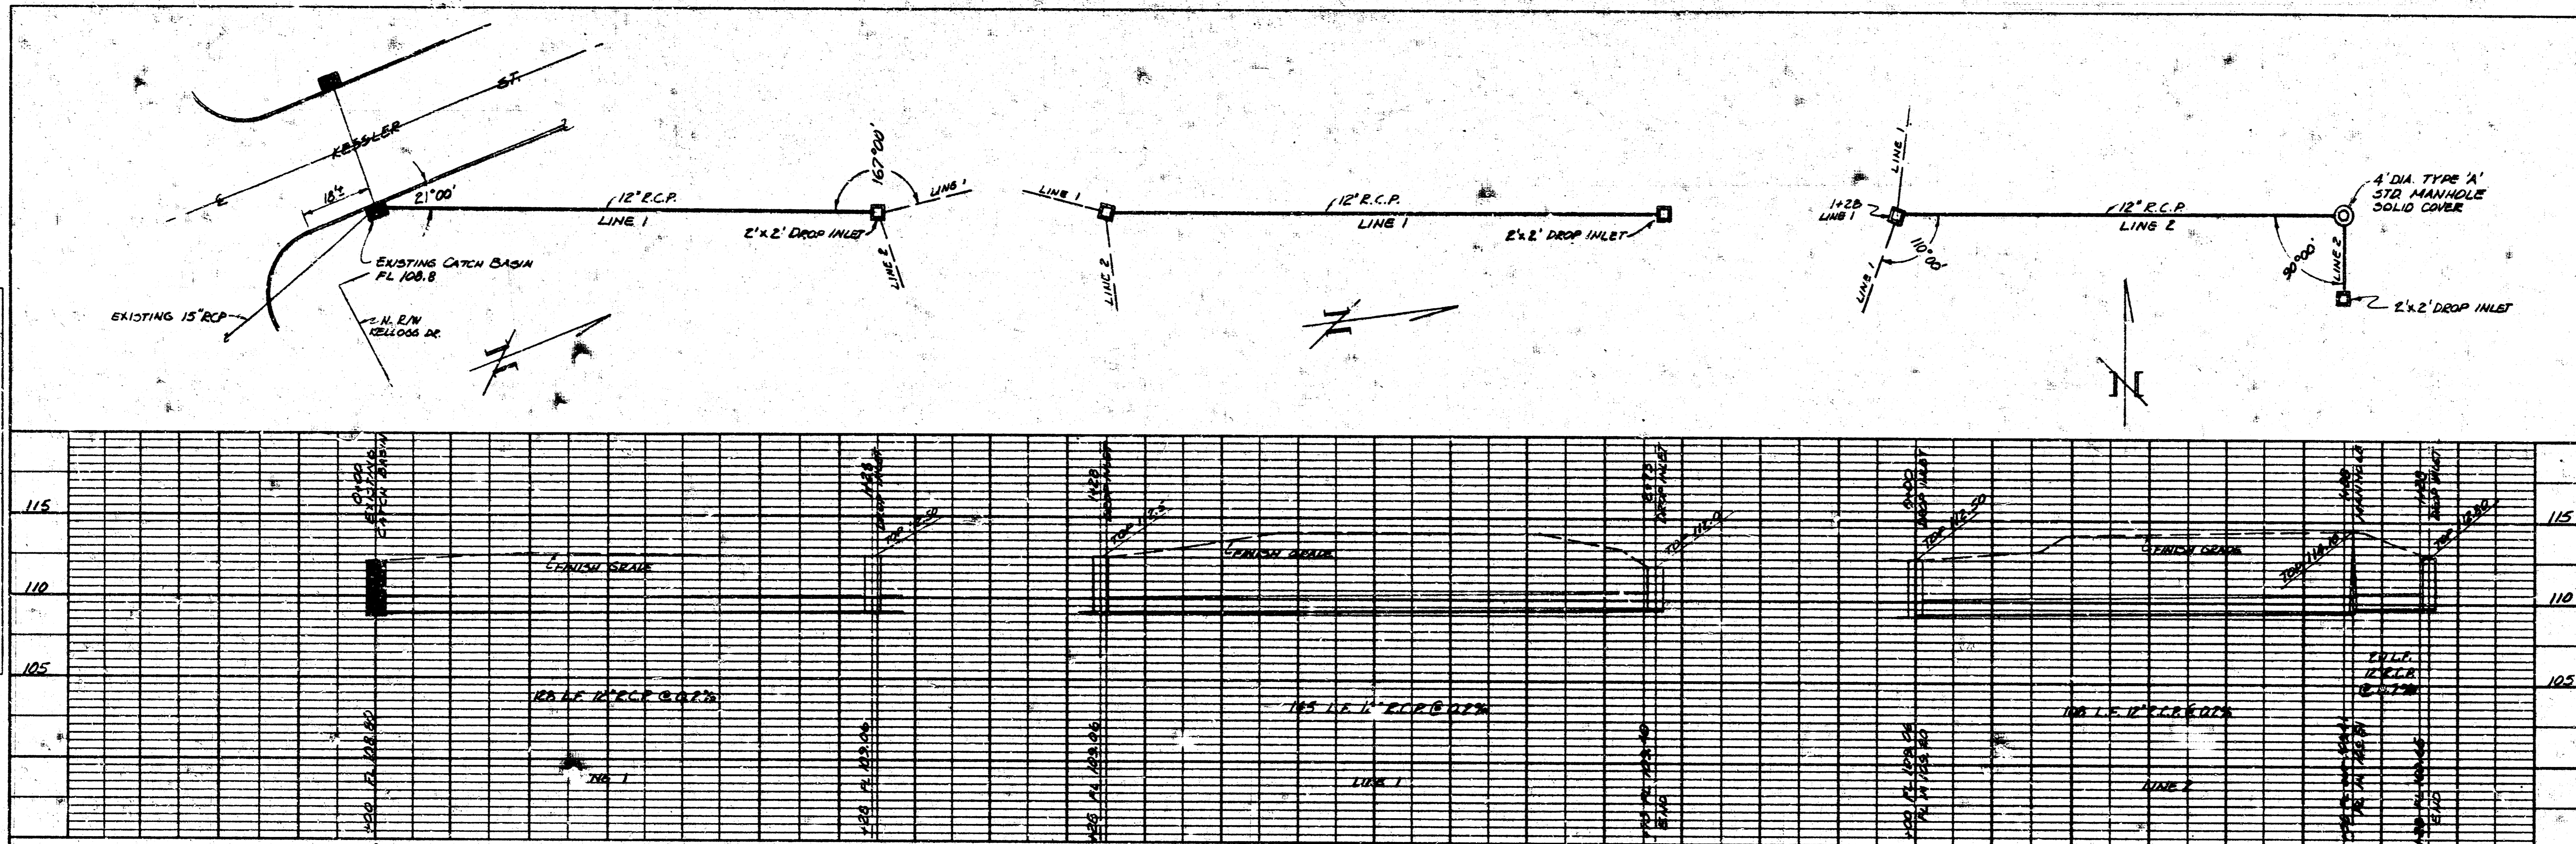


REINFORCED CONCRETE DROP INLET
 (ALTERNATE)

NOTES:
 1. MANHOLE TO BE 4' DIA. BRICK, CITY OF WICHITA STANDARD DESIGN.
 2. DROP INLET CATCH BASINS TO BE CITY OF WICHITA STANDARD DESIGN BRICK, OR (ALTERNATE) CATCH BASINS MAY BE 8'x8' REINFORCED CONCRETE 1/2\"/>

2/21/74
 James Tandy

SCALE
 1" = 20' HORIZ.
 1" = 5' VERT.

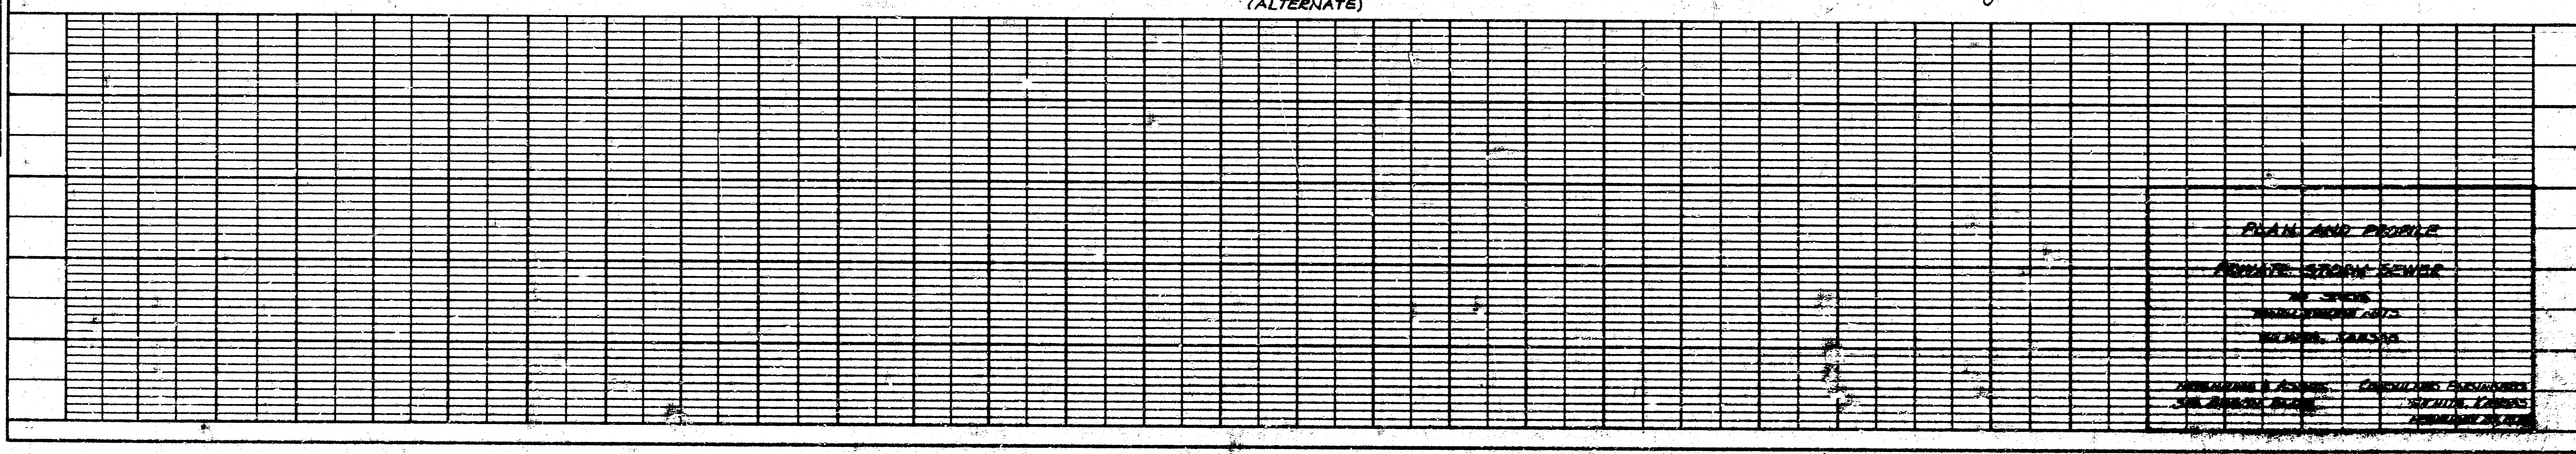

PLAN AND PROFILE
 STORM SEWER
 PROJECT: _____
 SHEET NO. _____ OF _____