


Scale: 1"=20'

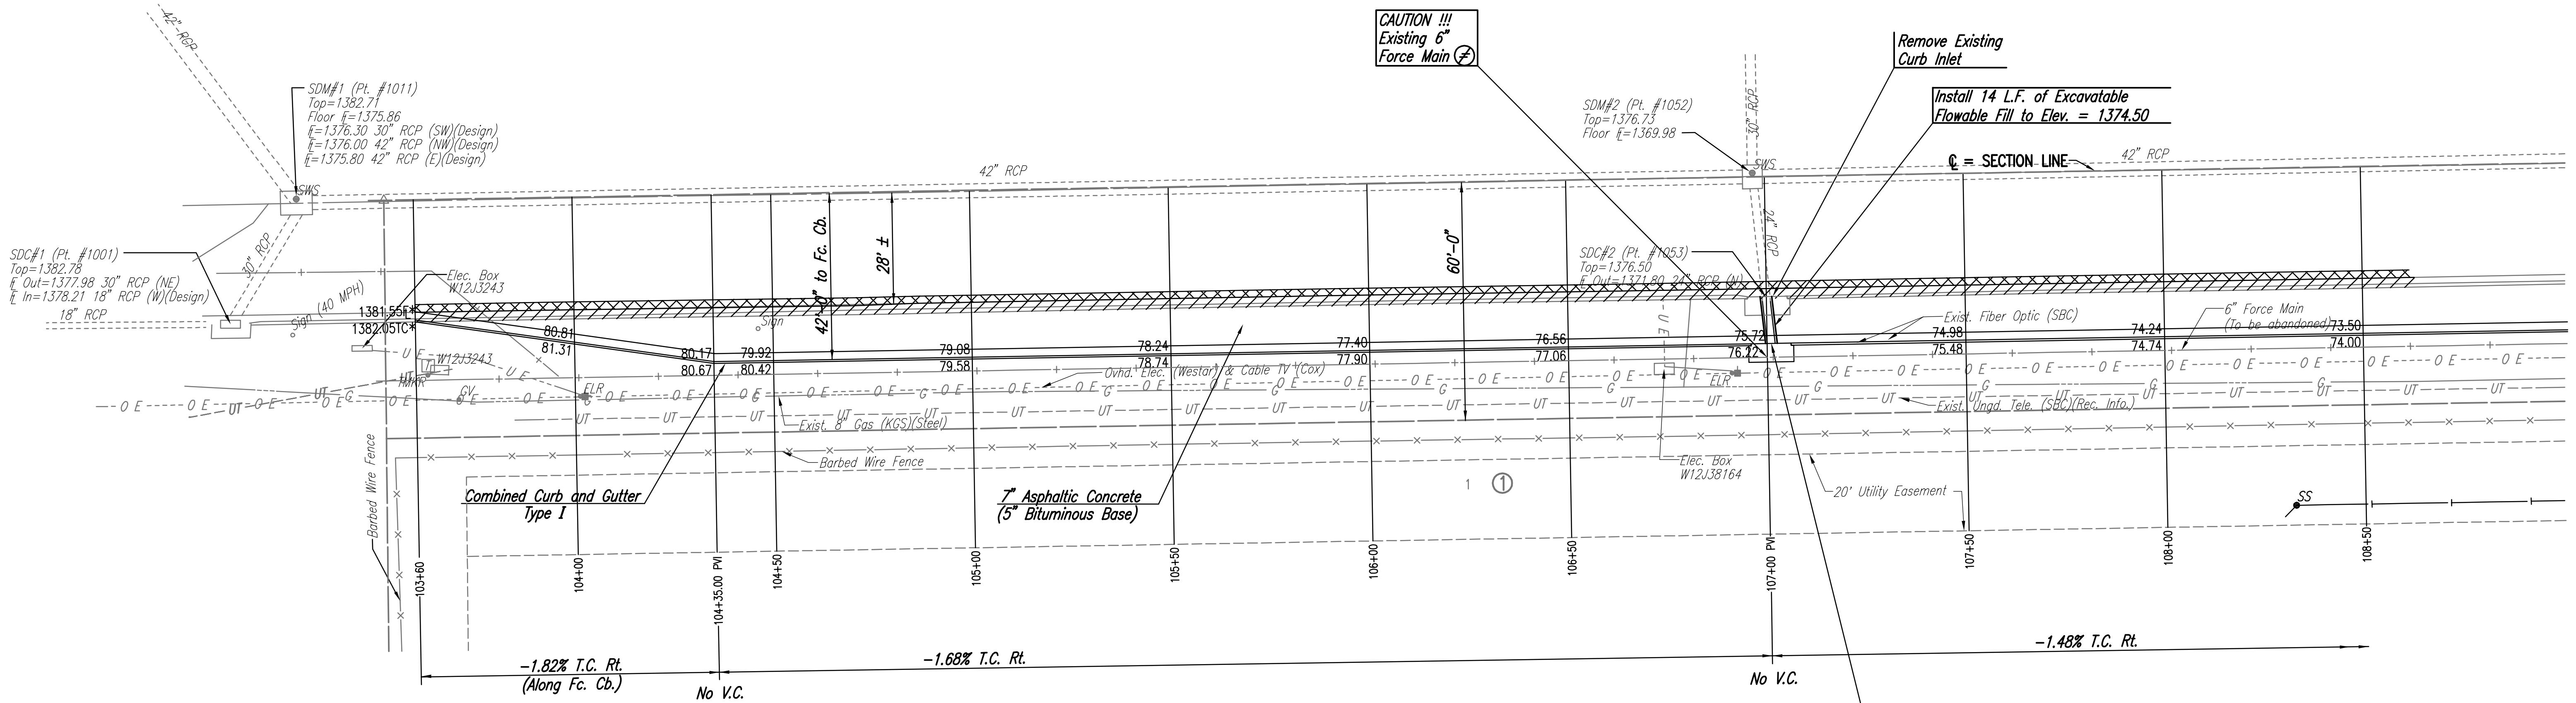

Sta. 107+01 Construct
 Std. Type I Curb Inlet 40' Rt.
 L=10'-0", W=4'-0"
 Top Elev.=1376.22
 I_o Out (N)=1371.90
 See Detail Sheet No. 12.
 Install 16.0 L.F. 18" RCP (N)
 Connect to Existing SWS.


Saw Cut, Remove and Replace Asphalt Surface (Subsidiary to 7" A.C. Pavt.)

Remove Combined Curb and Gutter

* Match Existing

⊗ Prior to construction, Contractor shall contact the Engineer to confirm that the force main is out of service and ready to be abandoned.

Saved: 05-05-2006 9:21:46 AM by BCL
 Plot: Scale: 1:20 05-05-2006 5:14:02 PM by BCL
 J:\SENTOU\2004\04688\003\2006-06-05 to City of Wichita.DWG 05-PAVING PLAN STA103+00-108+50

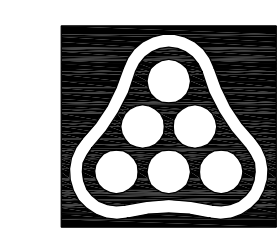

No.	Revision	By	Date
OAK CREEK - PHASE 1 21ST ST. N. DECEL LANE PAVING PLAN 103+60 TO 108+50 JAMES L. ARMOUR, P.E. - CITY ENGINEER CITY OF WICHITA PROJECT NO. 472-84206 Professional Engineering Consultants, P.A. 303 S. TOPKA • WICHITA, KANSAS 67202 316-262-2691 • FAX 316-262-3003			
Designed by	BDB, BLB	Job No.	35-04688-003
Drawn by	BJS, JMU	Date	October 2004
			Sheet 5 of 28