

UTILITY LEGEND

= Fire Hydrant	= Flag Pole
= Water Meter	= SS Manhole
= Water Valve	= SWS Manhole
= Gas Meter	= Sign
= Gas Valve	= Misc. Post
= Telephone Riser	= Guy Anchor
= Mailbox	= Power Pole
= Deciduous Tree or Shrub	= Light Pole
= Existing Fence	
= Right of Way Line	
= Underground Telephone	
= Underground Electric	
= Overhead Electric	
= Water Line	
= Sanitary Sewer	
= Kansas Gas Line	
= Cable TV or Fiber Optic	


- Proposed 5" A.C. Pavement on 5" Crushed Rock Base
- Proposed Concrete Curb & Gutter / Concrete Drive Entrance
- Exist. Road Gravel To Be Removed
- Propose Pavement Removal
- Propose Driveway Grading (Exist. Gravel To Be Saved & Relayed After Grading.)

UTILITIES SHOWN REPRESENT THE BEST INFORMATION AVAILABLE FOR DESIGN. ADDITIONAL UTILITIES MAY BE PRESENT ON THIS PROJECT. THE CONTRACTOR SHALL BE RESPONSIBLE FOR DETERMINING THE EXACT LOCATION, DEPTH AND SIZE OF ALL UNDERGROUND UTILITIES PRIOR TO CONSTRUCTION. THE CONTRACTOR SHALL BE LIABLE FOR ANY DAMAGE CAUSED BY THE FAILURE TO DO SO.

PAVING PLANS FOR
EVERGREEN LANE
 WICHITA, SEDGWICK COUNTY, KS
 CED PROJ. NO.: 20081661

CERTIFIED ENGINEERING DESIGN, P.A.
 810 WEST DOUGLAS, SUITE C
 WICHITA, KANSAS 67203
 PH.(316)262-8808 FAX.(316)262-1669

DESIGNED: HDF	SCALE: 1"=20'	SHEET 6
DRAWN: JDT	DATE: 06-08	
CHECKED: HDF	CED FILE: CED-1XXX	TOTAL 33

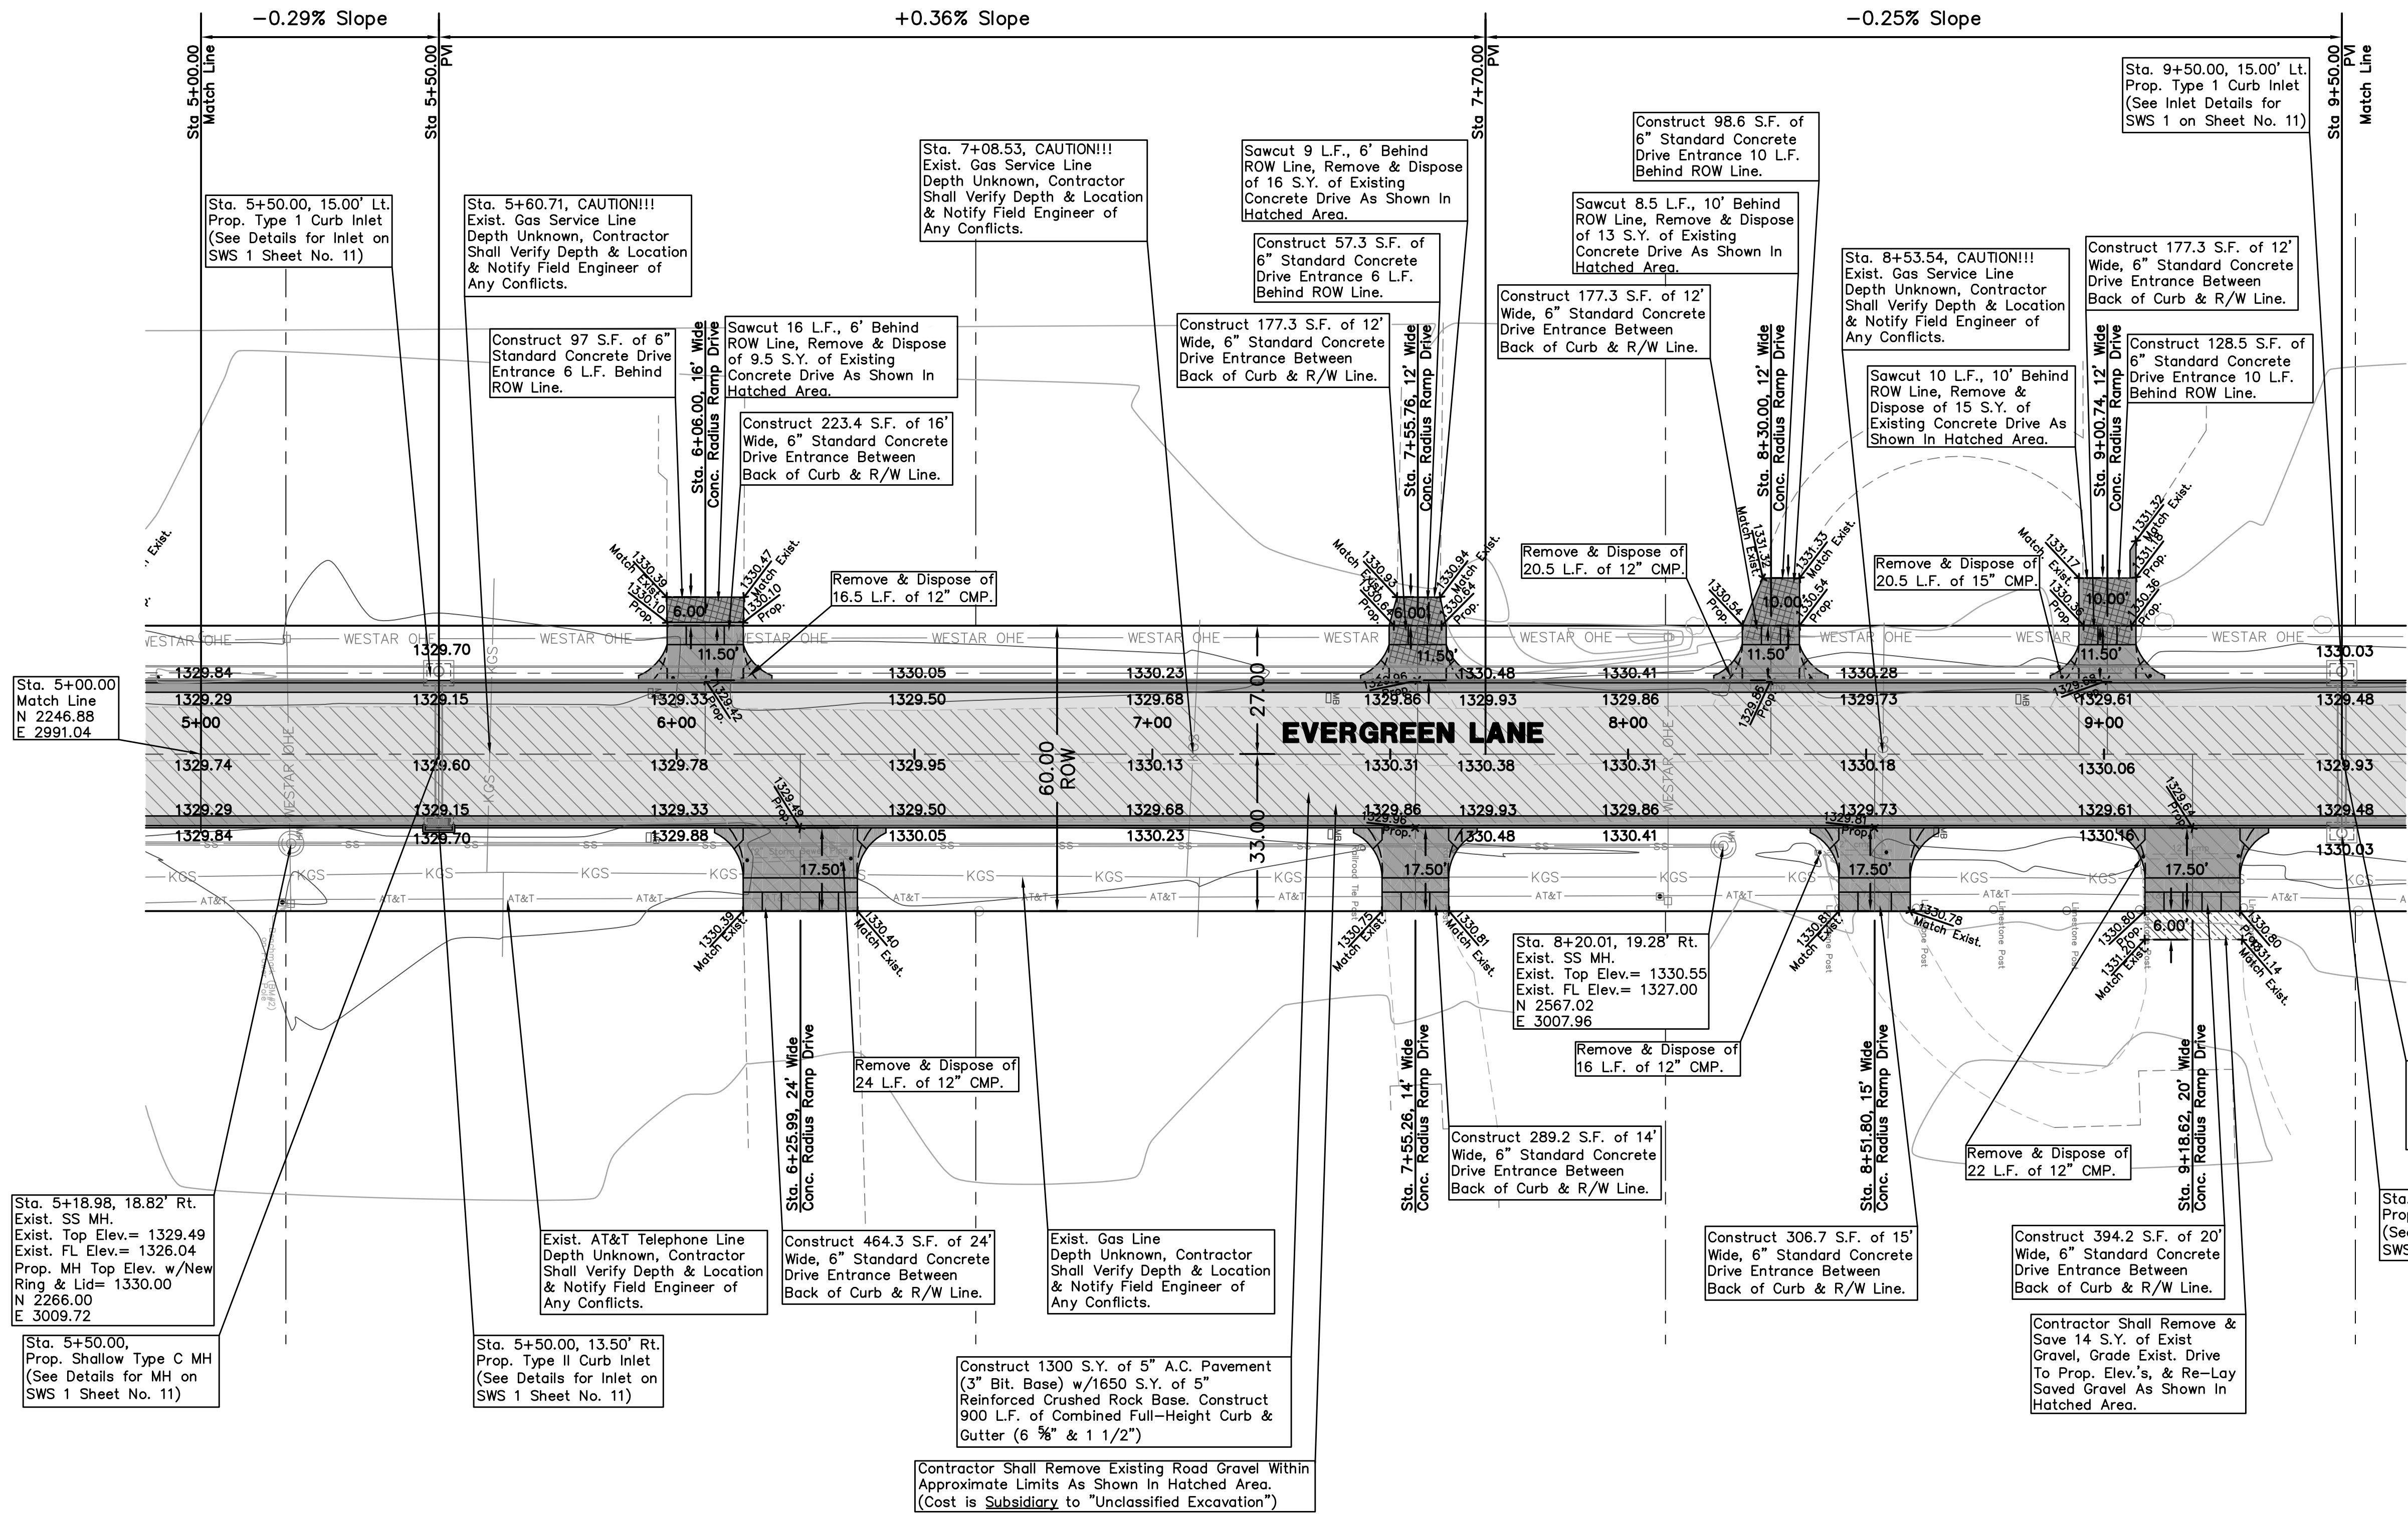

Costs for Existing Gravel Driveway Removal & Replacement Shall Be "Subsidiary" To Concrete Entrance Pavement (6").

SEE GENERAL NOTE 15 ON TITLE SHEET FOR MAILBOX RELOCATIONS.

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