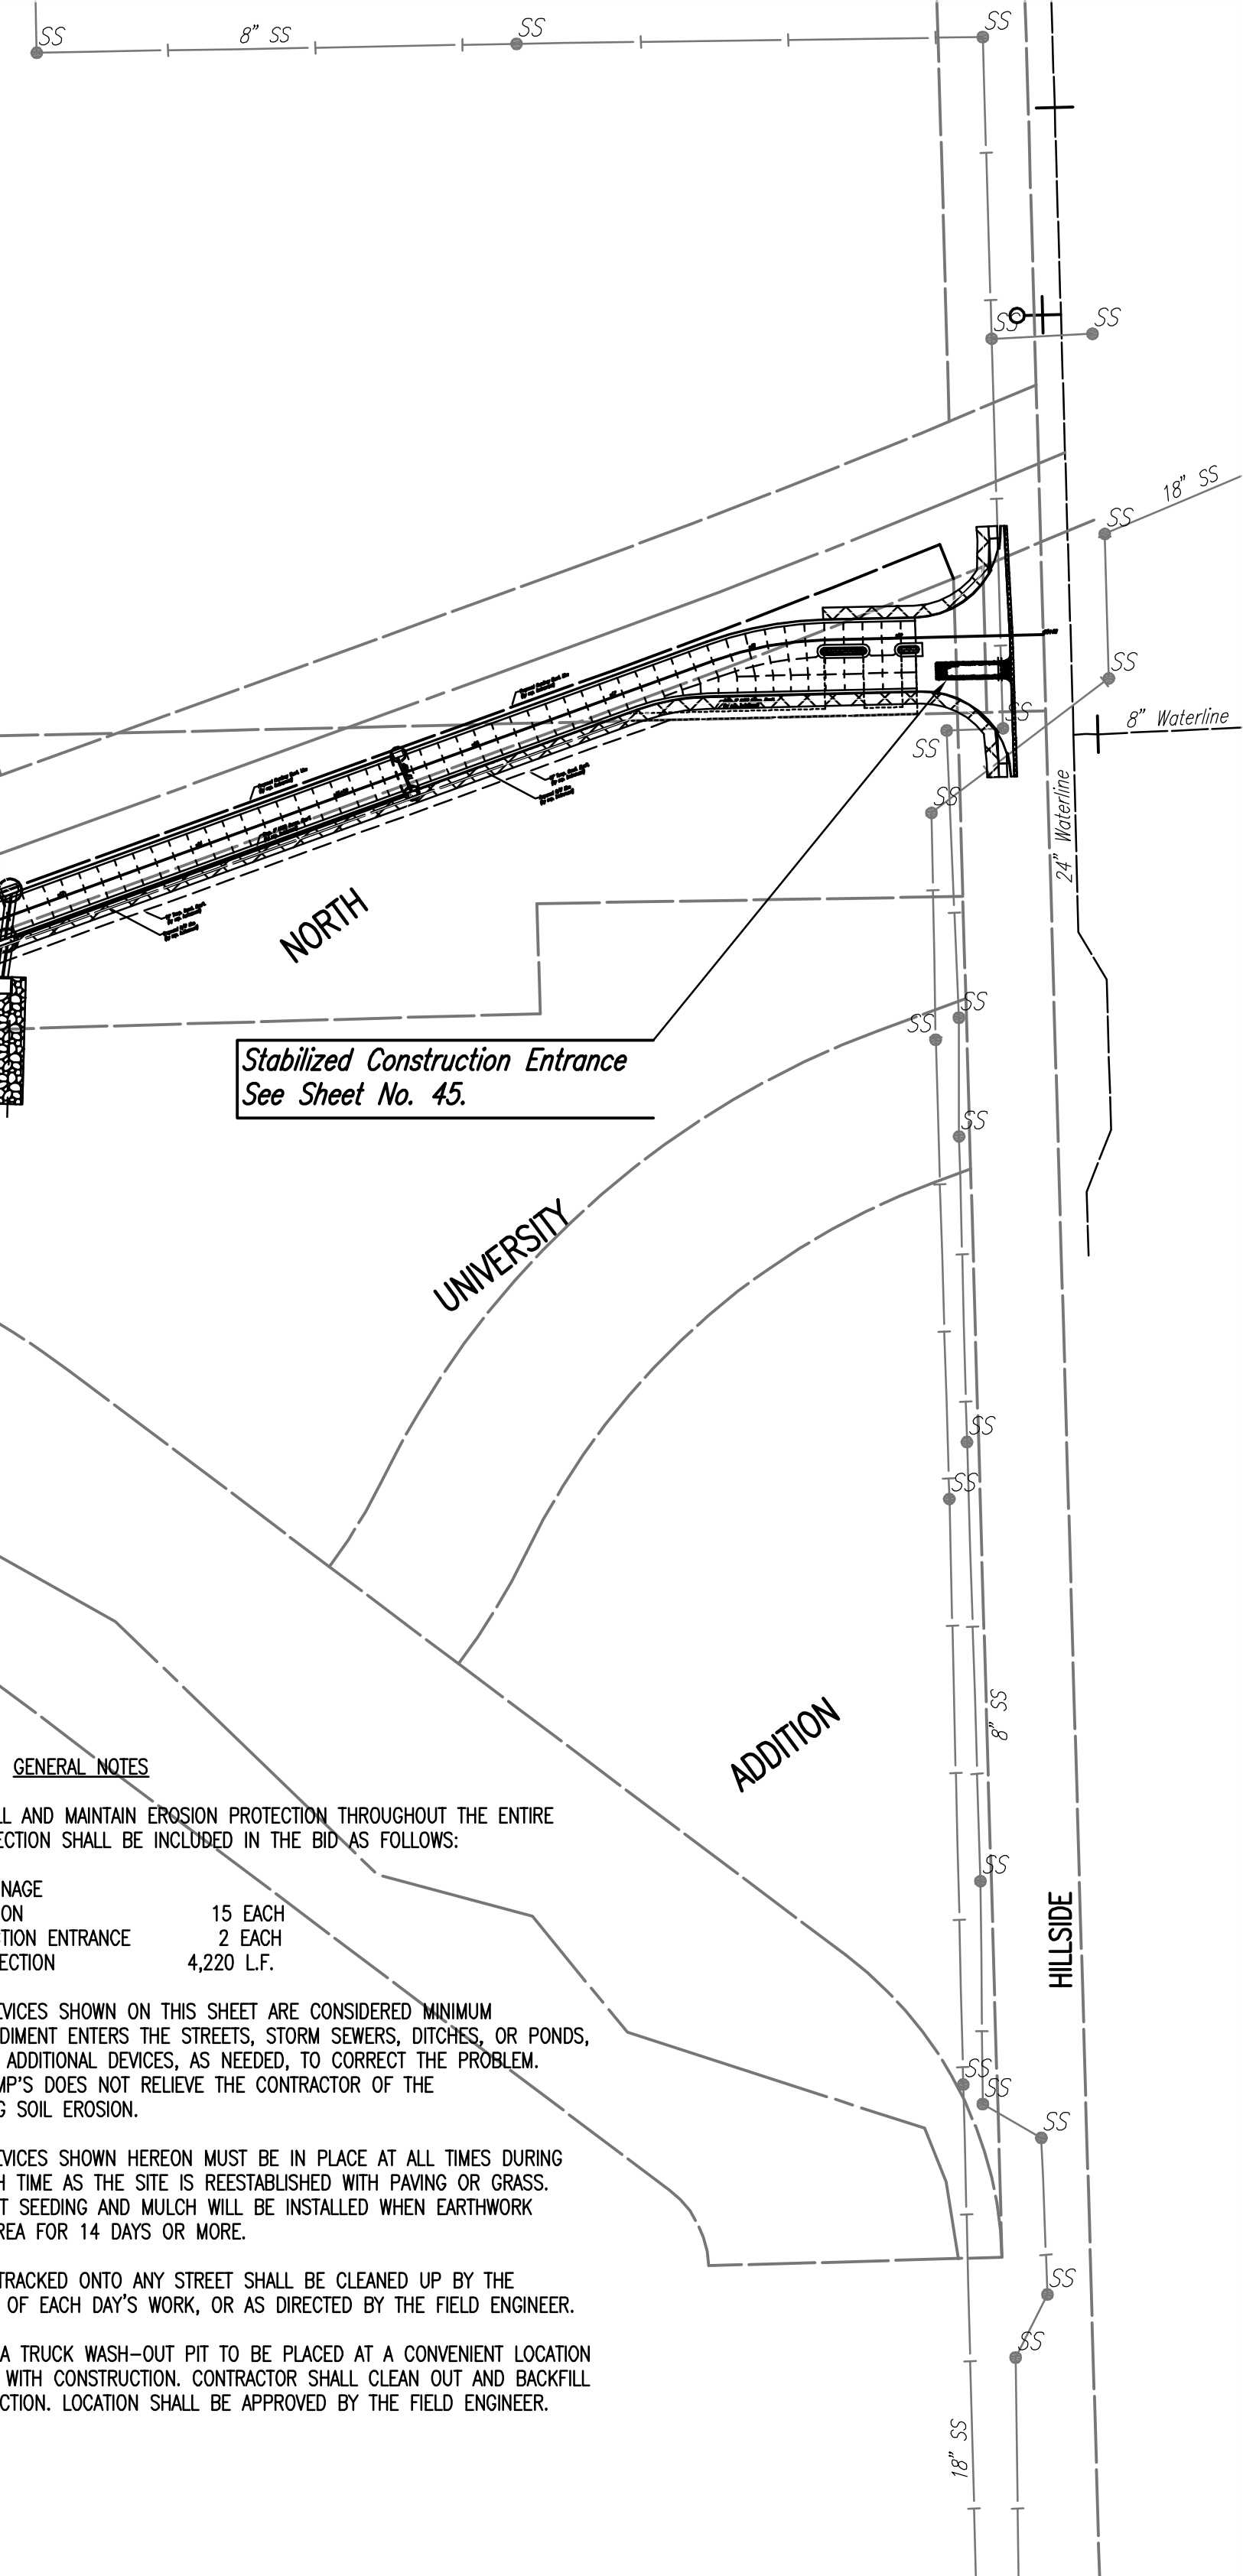
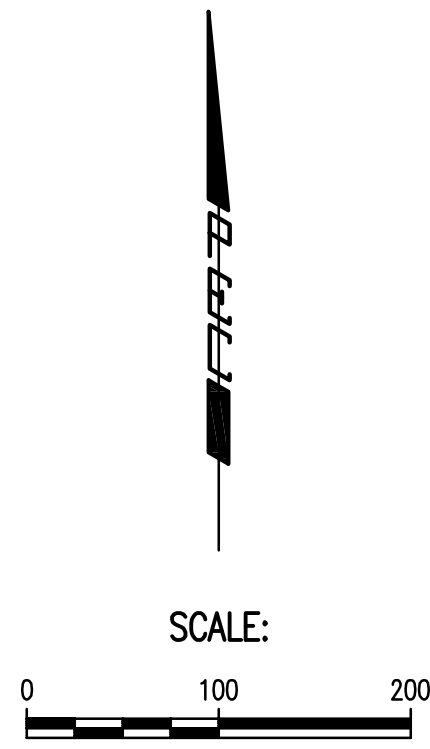
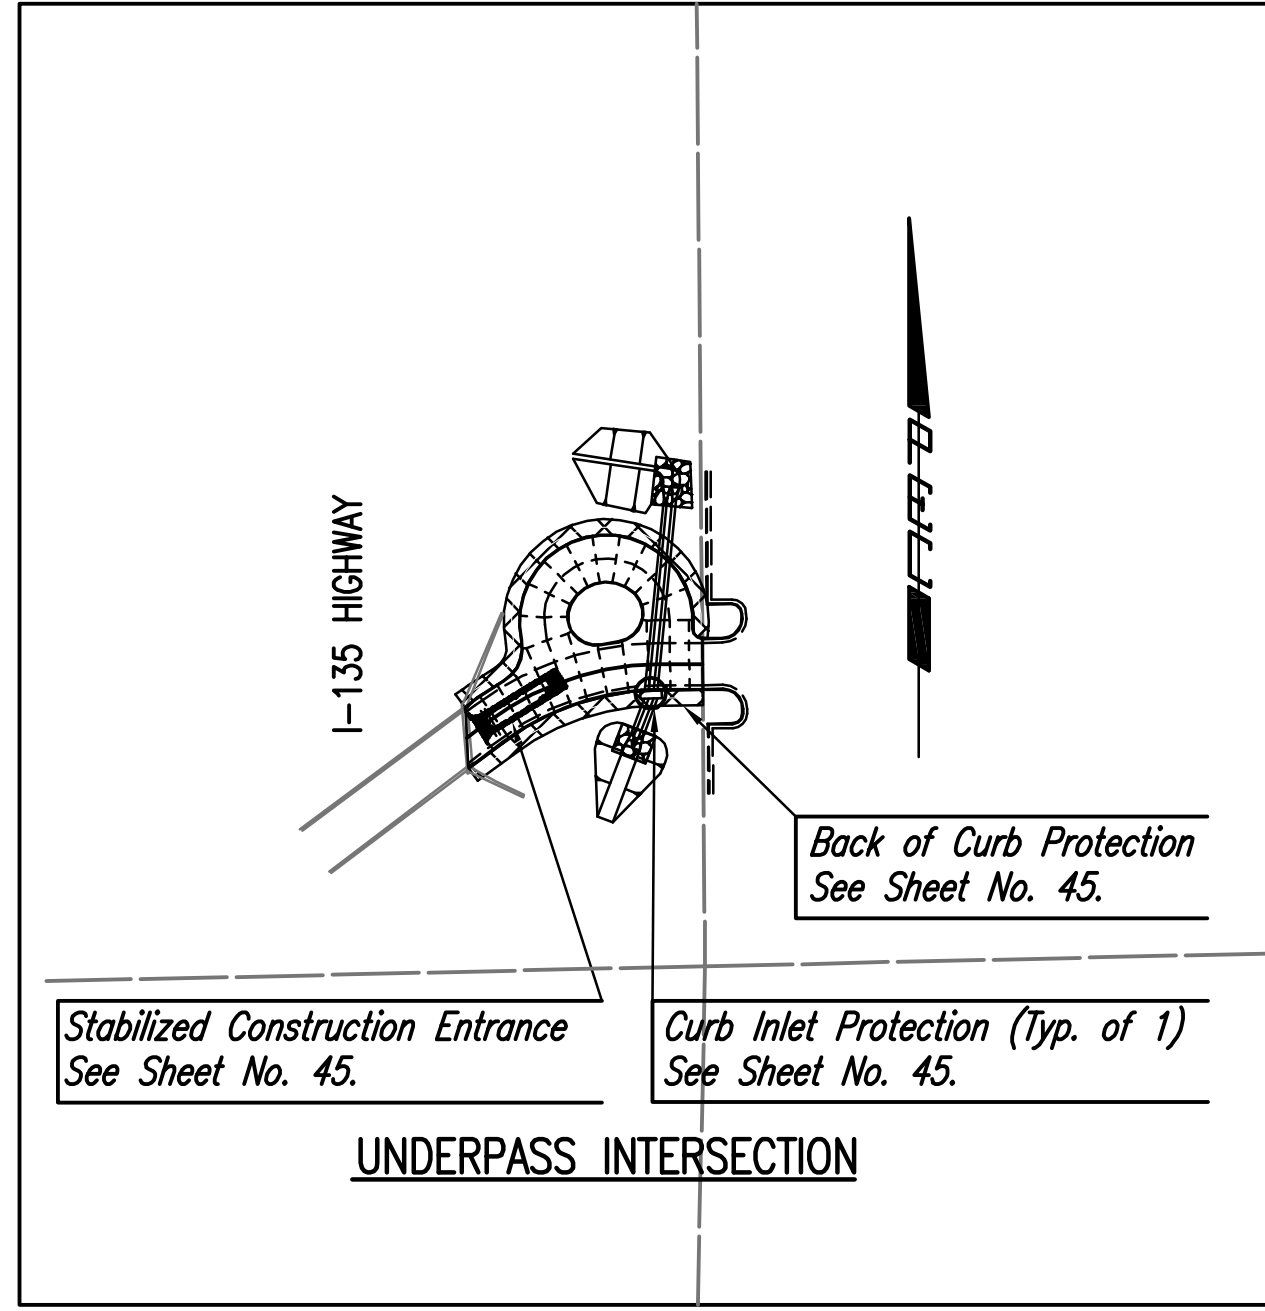


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 Plot Scale: 1:100 01-17-2011 2:51:26 PM by BILL J. SEKSON  
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Stabilized Construction Entrance  
See Sheet No. 45.

Curb Inlet Protection (Typ. of 1)  
See Sheet No. 45.

UNDERPASS INTERSECTION


Curb Inlet Protection (Typ. of 14)  
See Sheet No. 45.

Back of Curb Protection  
See Sheet No. 45.

- LEGEND**
- STABILIZED CONSTRUCTION ENTRANCE
  - BACK OF CURB PROTECTION
  - CURB INLET PROTECTION
  - EXISTING STORM WATER SEWER
  - PROPOSED STORM WATER SEWER
  - EXISTING STORM WATER SEWER w/MANHOLE

- GENERAL NOTES**
- CONTRACTOR SHALL INSTALL AND MAINTAIN EROSION PROTECTION THROUGHOUT THE ENTIRE PROJECT. EROSION PROTECTION SHALL BE INCLUDED IN THE BID AS FOLLOWS:  

PAVING & INCIDENTAL DRAINAGE	
CURB INLET PROTECTION	15 EACH
STABILIZED CONSTRUCTION ENTRANCE	2 EACH
BACK OF CURB PROTECTION	4,220 L.F.
  - THE EROSION CONTROL DEVICES SHOWN ON THIS SHEET ARE CONSIDERED MINIMUM STANDARDS. WHENEVER SEDIMENT ENTERS THE STREETS, STORM SEWERS, DITCHES, OR PONDS, CONTRACTOR WILL INSTALL ADDITIONAL DEVICES, AS NEEDED, TO CORRECT THE PROBLEM. INSTALLATION OF THESE BMP'S DOES NOT RELIEVE THE CONTRACTOR OF THE RESPONSIBILITY OF ABATING SOIL EROSION.
  - THE EROSION CONTROL DEVICES SHOWN HEREON MUST BE IN PLACE AT ALL TIMES DURING CONSTRUCTION UNTIL SUCH TIME AS THE SITE IS REESTABLISHED WITH PAVING OR GRASS. TEMPORARY OR PERMANENT SEEDING AND MULCH WILL BE INSTALLED WHEN EARTHWORK ACTIVITIES CEASE IN AN AREA FOR 14 DAYS OR MORE.
  - ANY MUD INADVERTENTLY TRACKED ONTO ANY STREET SHALL BE CLEANED UP BY THE CONTRACTOR, AT THE END OF EACH DAY'S WORK, OR AS DIRECTED BY THE FIELD ENGINEER.
  - CONTRACTOR TO FURNISH A TRUCK WASH-OUT PIT TO BE PLACED AT A CONVENIENT LOCATION THAT DOES NOT CONFLICT WITH CONSTRUCTION. CONTRACTOR SHALL CLEAN OUT AND BACKFILL PIT PRIOR TO FINAL INSPECTION. LOCATION SHALL BE APPROVED BY THE FIELD ENGINEER.

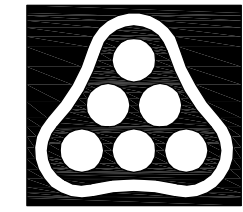

No.	Revision	By	Date
HEARTLAND PREPAREDNESS CENTER PAVING AND DRAINAGE IMPROVEMENTS <b>EROSION CONTROL PLAN</b> JAMES L. ARMOUR, P.E. - CITY ENGINEER CITY OF WICHITA PROJ. NO. 472-84898 <b>Professional Engineering Consultants, P.A.</b> 303 S. TOPEKA • WICHITA, KANSAS 67202 316-262-2691 • FAX 316-262-3003			
Designed by	BMM	Job No.	35-09307
Drawn by	BJS	Date	December 2009