



SWD 321
KRUG SOUTH ADDITION
PHASE 2

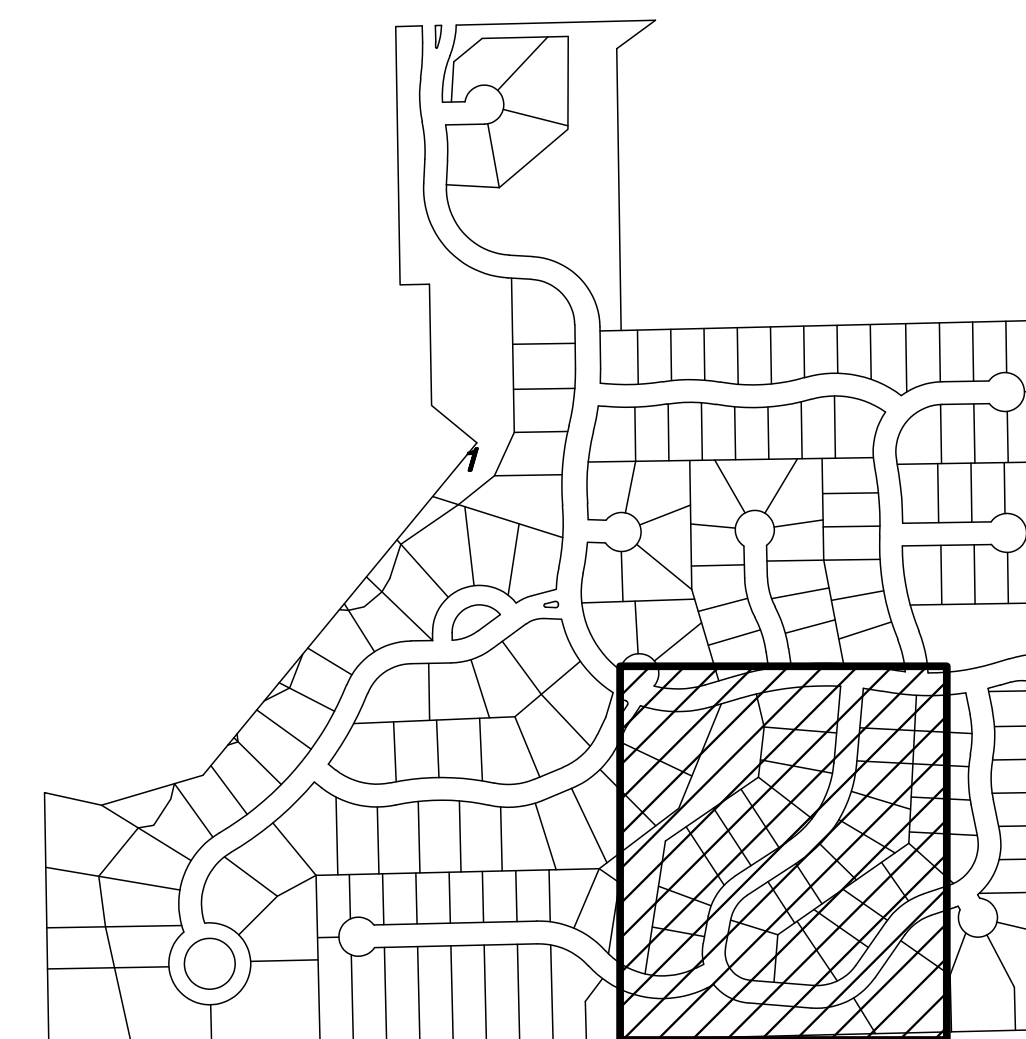

VICINITY MAP



SCALE: 1"=60'
60 30 0 60

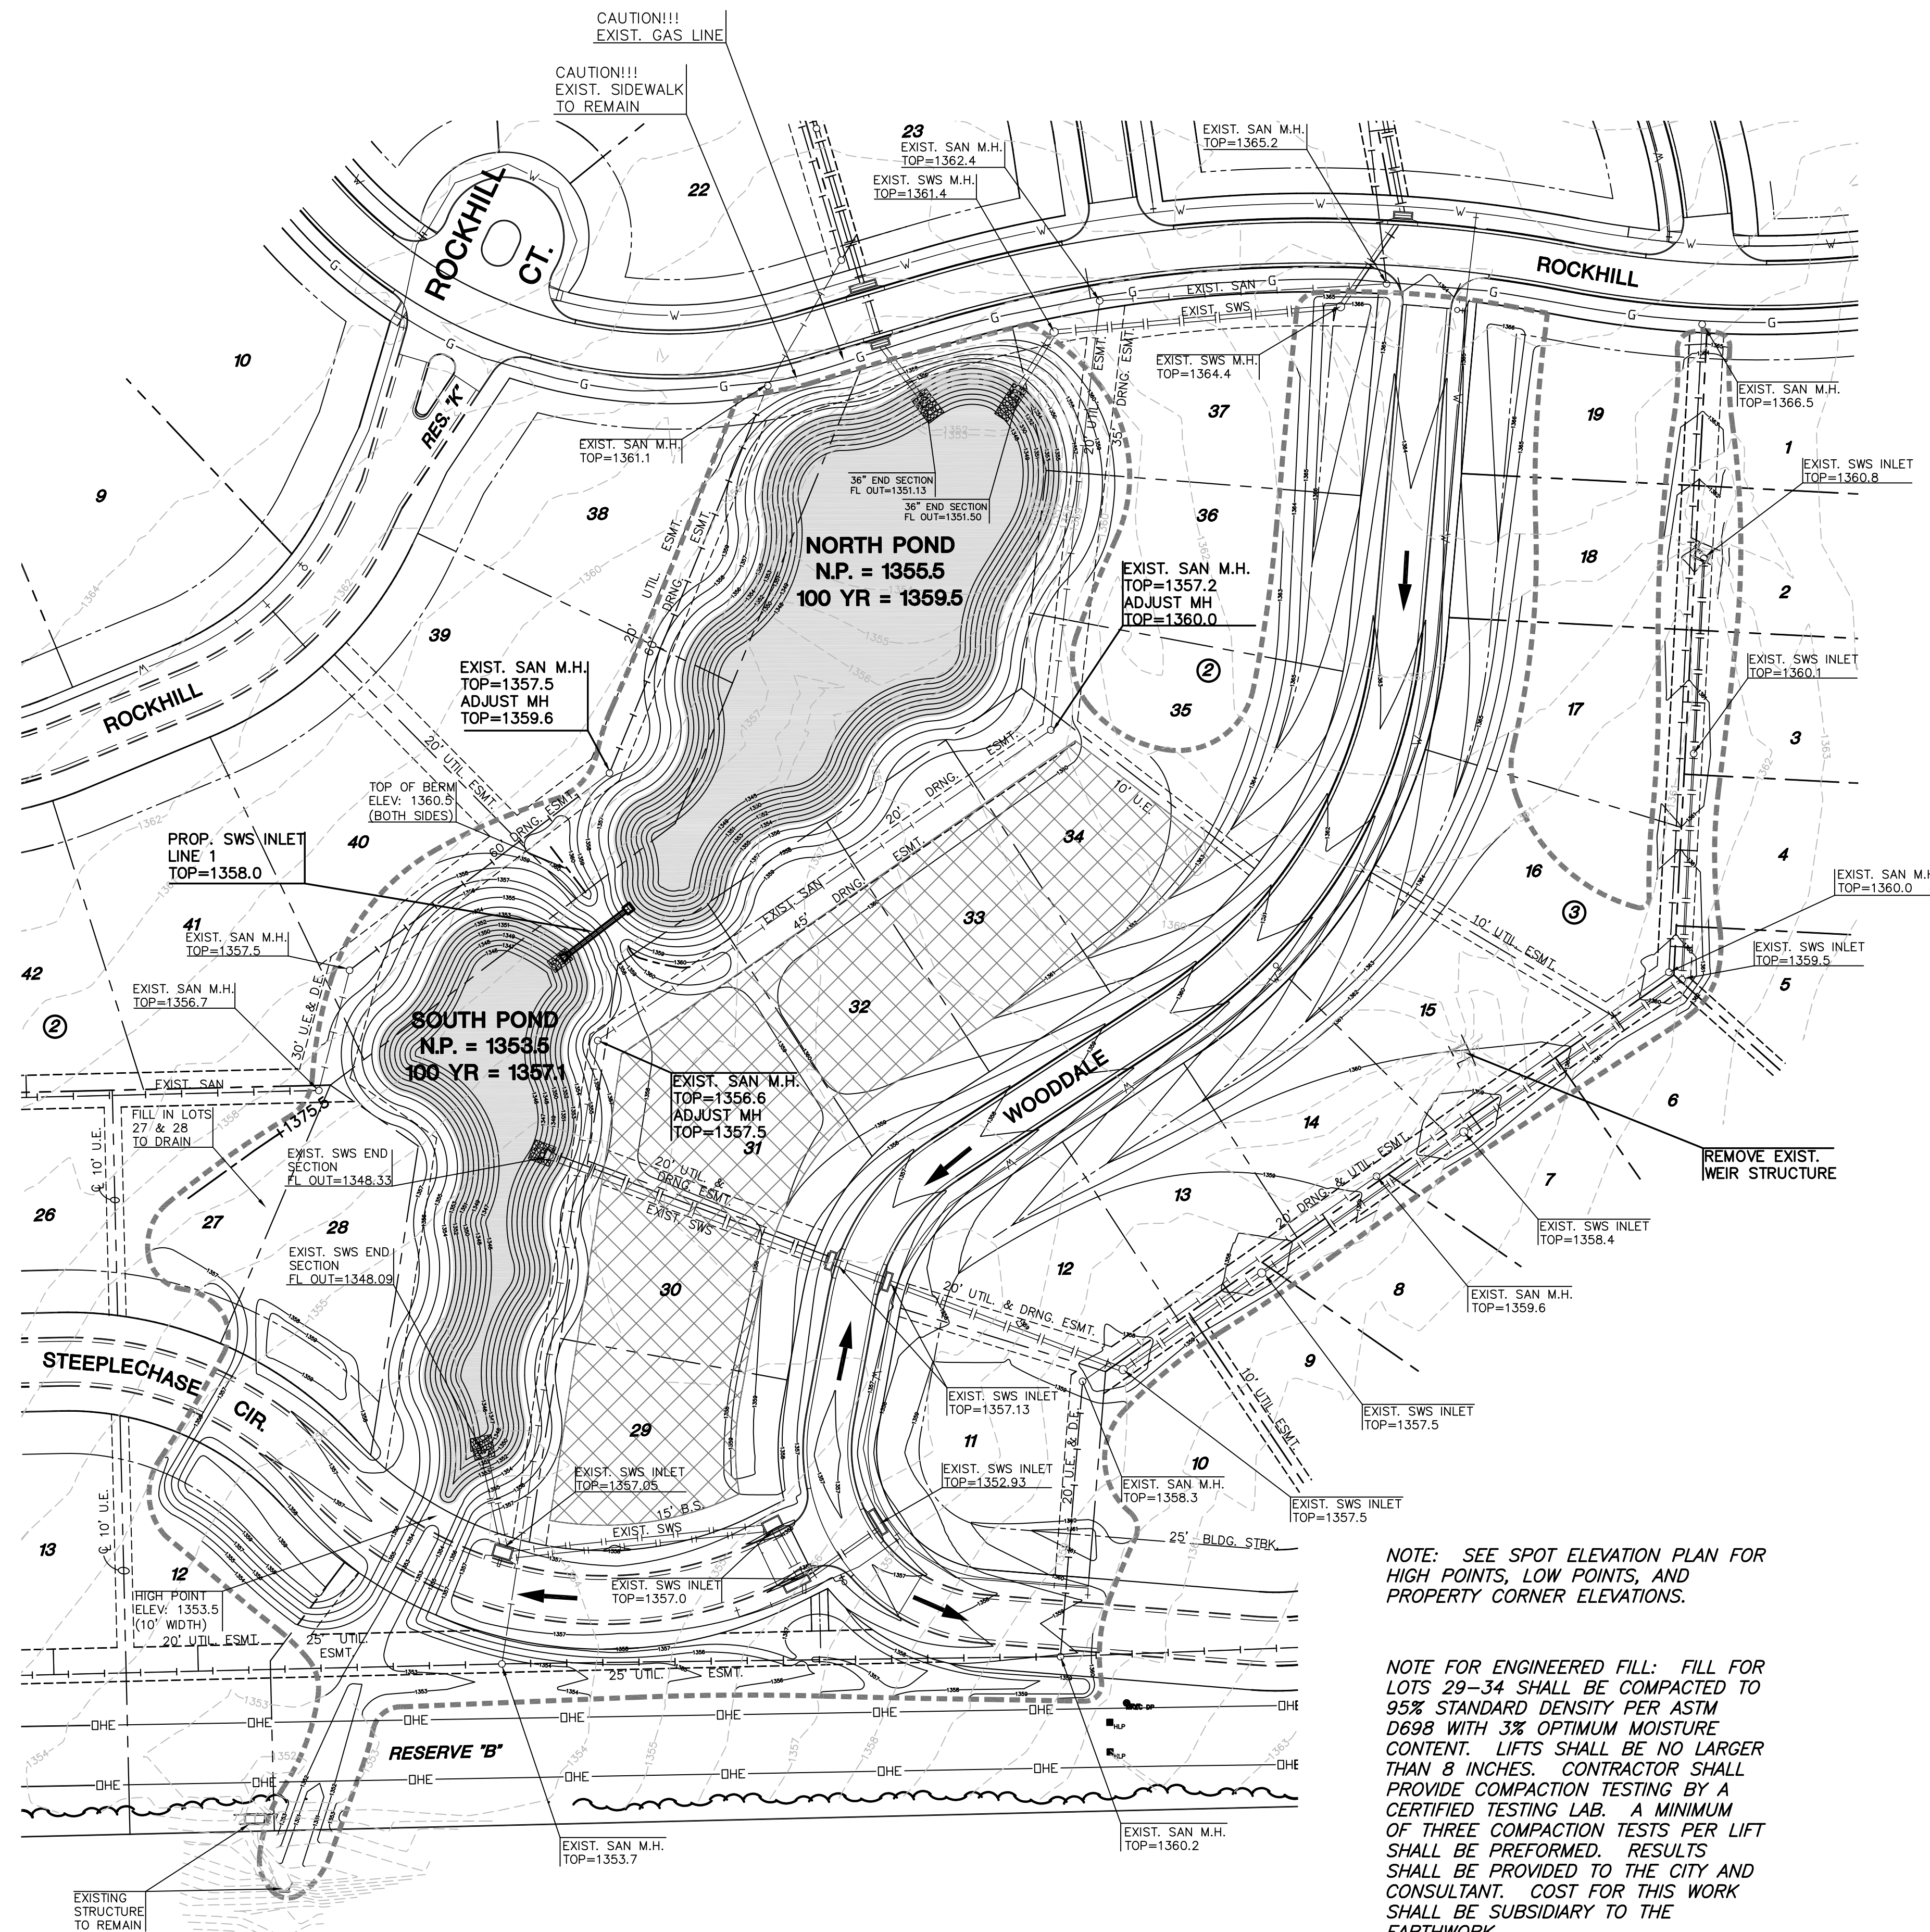

LEGEND

- DHE — — EXISTING OVERHEAD ELECTRIC LINE
- G — — EXISTING GAS LINE
- W — — EXISTING WATER LINE
- S — — EXISTING STORMWATER SEWER LINE
- SS — — EXISTING SANITARY SEWER LINE
- - - 1359 - - - EXISTING CONTOURS
- - - 1360 - - - PROPOSED CONTOURS
- ▬▬▬▬▬ — LIMITS OF GRADING
- — NORMAL POOL
- ➔ — DRAINAGE ARROWS
- ▨ — ENGINEERED FILL

NOTE: SEE SPOT ELEVATION PLAN FOR HIGH POINTS, LOW POINTS, AND PROPERTY CORNER ELEVATIONS.

NOTE FOR ENGINEERED FILL: FILL FOR LOTS 29-34 SHALL BE COMPACTED TO 95% STANDARD DENSITY PER ASTM D698 WITH 3% OPTIMUM MOISTURE CONTENT. LIFTS SHALL BE NO LARGER THAN 8 INCHES. CONTRACTOR SHALL PROVIDE COMPACTION TESTING BY A CERTIFIED TESTING LAB. A MINIMUM OF THREE COMPACTION TESTS PER LIFT SHALL BE PERFORMED. RESULTS SHALL BE PROVIDED TO THE CITY AND CONSULTANT. COST FOR THIS WORK SHALL BE SUBSIDIARY TO THE EARTHWORK.

GRADING PLAN

SHEET TITLE
468-84328

PROJECT NUMBER

MLP / MLP / GJA
DESIGNED / DRAWN / CHECKED

ISSUED
July 2012

REVISED

SHEET NO.
4 of 16