


NOTE: DRY STACK QUARRY BLOCK STONE PROVIDED BY:
 BAYER STONE, INC. - SITE: CHASE COUNTY, KS QUARRY
 TYPE: COTTONWOOD LIMESTONE
 SIZE: RANDOM SPLIT STONE, LEDGE HEIGHT: 9-24"
 LENGTH: (REFER TO STONE SCHEDULE)
 RESERVE LARGER STONES FOR BASE COURSES,
 COORDINATE PLACEMENT w/ LANDSCAPE ARCHITECT

NOTE: TILT ALL STONE SLABS
 SLIGHTING INWARD TOWARD THE
 RETAINED SURFACE
 NOTE: LEDGE FOR STONE SHALL
 BE MIN. 8" BELOW NORMAL POOL
 ELEVATION, TYP.

NOTE: TOP OF WALL ELEVATIONS
 VARY, REFER TO THE SITE
 GRADING PLAN FOR FINISHED
 TOP OF SLAB ELEVATIONS.

NOTE: USE FINE CHAT AS A
 LEVELING COURSE BETWEEN
 STONES WHERE NEEDED

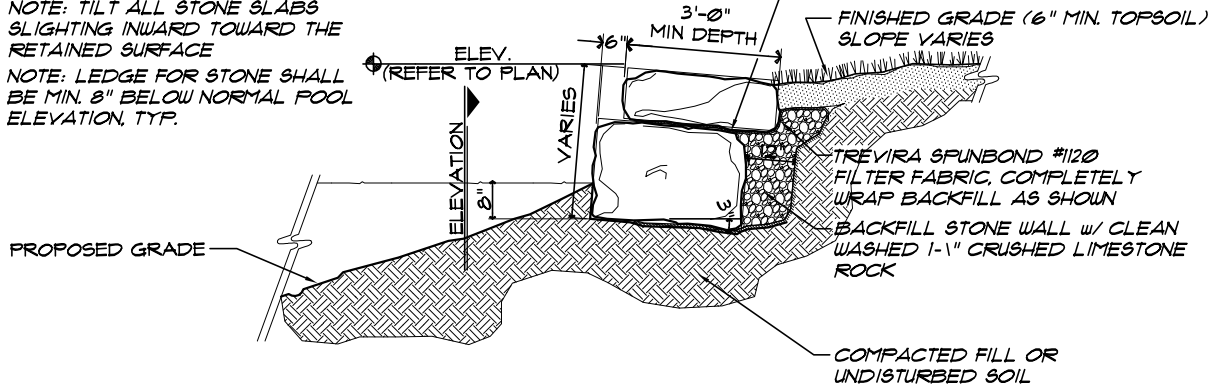

DRY STACK STONE WALL @ WEIR (BEYOND 9')

SCALE= 1/4" = 1'-0"

TYPICAL SECTION

NOTE: DRY STACK QUARRY BLOCK STONE PROVIDED BY:
 BAYER STONE, INC. - SITE: CHASE COUNTY, KS QUARRY
 TYPE: COTTONWOOD LIMESTONE
 SIZE: RANDOM SPLIT STONE, LEDGE HEIGHT: 9-24"
 LENGTH: (REFER TO STONE SCHEDULE)
 RESERVE LARGER STONES FOR BASE COURSES,
 COORDINATE PLACEMENT w/ LANDSCAPE ARCHITECT


NOTE: TILT ALL STONE SLABS
 SLIGHTING INWARD TOWARD THE
 RETAINED SURFACE
 NOTE: LEDGE FOR STONE SHALL
 BE MIN. 8" BELOW NORMAL POOL
 ELEVATION, TYP.

NORMAL POOL ELEV VARIES
 SEE GRADING PLAN

LAKE BOTTOM
 FINISHED
 GRADE

NOTE: TOP OF WALL ELEVATIONS
 VARY, REFER TO THE SITE
 GRADING PLAN FOR FINISHED
 TOP OF SLAB ELEVATIONS.

NOTE: USE FINE CHAT AS A
 LEVELING COURSE BETWEEN
 STONES WHERE NEEDED

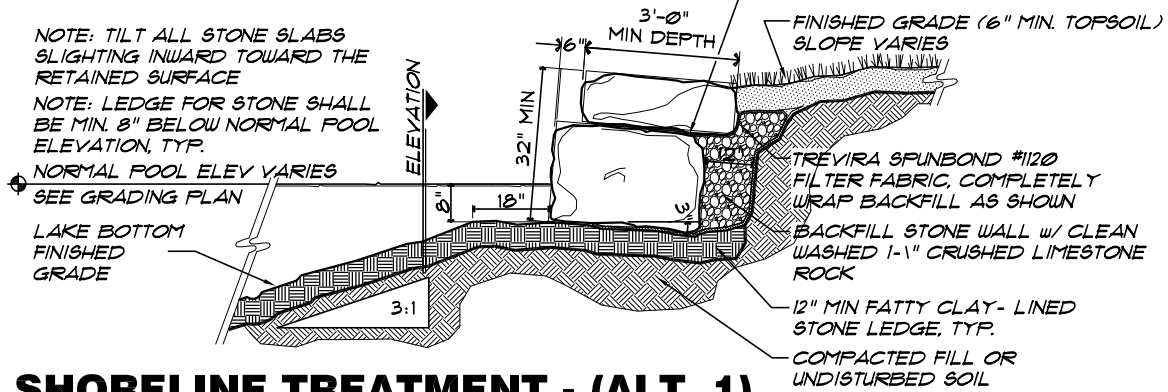

SHORELINE TREATMENT - (ALT. 1) DRY STACK STONE WALL

SCALE= 1/4" = 1'-0"

TYPICAL SECTION

H:\CIVIL\02167\DWG\Grad\POINDS\02167BRM



ENGINEERING CONSULTANTS

411 N. WEBB ROAD
 WICHITA, KS. 67206
 316-684-9600

HAWTHORNE ADDITION

PROJECT NAME

ADDENDUM 2 DETAILS

SHEET TITLE

JAG

DESIGN BY:

DMU

DRAWN BY:

DRK

CHECKED BY:

FEBRUARY 2003

DATE

02167

DRAWING NAME

2 / 46

SHEET / OF