


©2013
MKEC Engineering
All Rights Reserved
www.mkec.com
These drawings and their contents, including, but not limited to, all concepts, designs, & ideas are the exclusive property of MKEC Engineering (MKEC), and may not be used or reproduced in any way without the express consent of MKEC.

EROSION CONTROL PLAN


PROJECT NO.	472-85129	
DATE	JULY 2015	
SCALE	1" = 50'	
DESIGNED	DRAWN	CHECKED
DFL	JWC	GJA
NO.	REVISION	DATE
SHEET NO.		
18 OF 31		

EROSION CONTROL NOTES

1. EROSION CONTROL IS TO MEET ALL FEDERAL, STATE, COUNTY AND LOCAL CODE STANDARDS.
2. CONTRACTOR SHALL PROVIDE AND PRESERVE EROSION PROTECTION THROUGHOUT PROJECT CONSTRUCTION. THE PLAN PROVIDED HERE IS FOR FINAL PROTECTION. VARIOUS PHASES OF THIS PLAN SHALL BE IMPLEMENTED OR MODIFIED TO CONTROL EROSION. MODIFICATIONS OF THE PLAN SHALL BE APPROVED BY THE OWNERS REPRESENTATIVE.
3. CONTRACTOR IS RESPONSIBLE FOR MAINTAINING AND IMPLEMENTING ALL EROSION CONTROL.
4. CONTRACTOR SHALL INSTALL AND MAINTAIN A STABILIZED CONSTRUCTION ENTRANCE AT A LOCATION DETERMINED BY THE CITY.

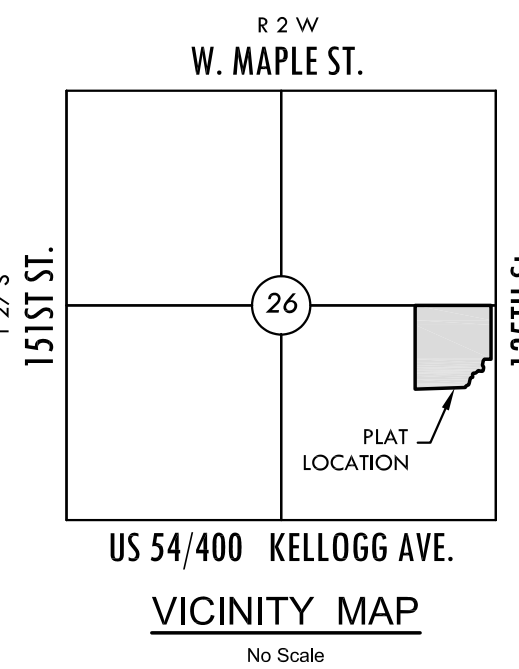



BENCH MARKS

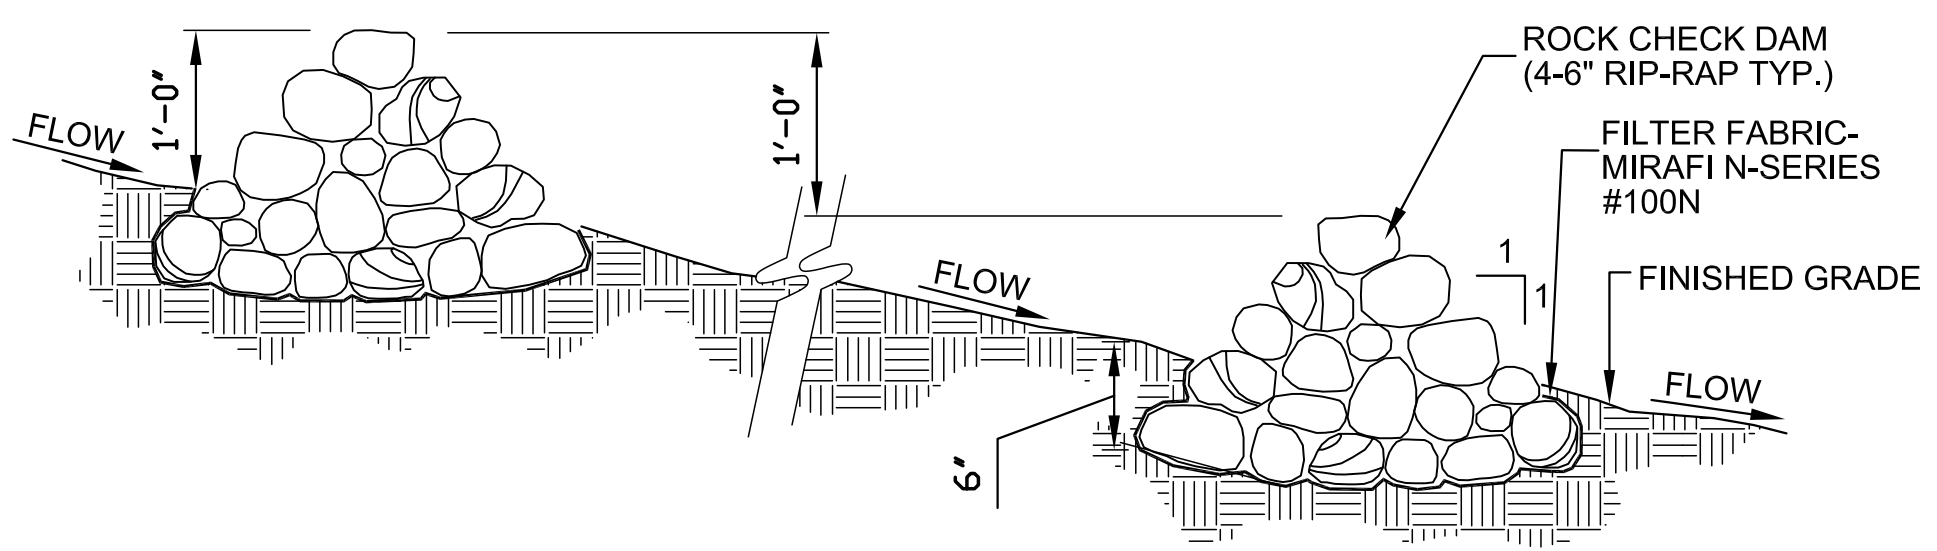

ROCK CHECK DAM - SECTION
SCALE: N.T.S.

EROSION CONTROL LEGEND

- SEEDING LIMITS
- ANNUAL RYE 200 LBS/ACRE
- FERTILIZE 10-20-10 @ 150 LBS/ACRE (BOUNDARY GIVEN FOR INFORMATION ONLY)
- SILT FENCE PROTECTION
- BACK OF CURB PROTECTION
- PROPOSED STORM SEWER LINE
- PROPOSED CONTOURS
- EXISTING CURB INLET FILTER
- EXISTING INLET PROTECTION
- CURB INLET FILTER
- INLET PROTECTION
- HAYBALE BARRIER
- STABILIZED ENTRANCE

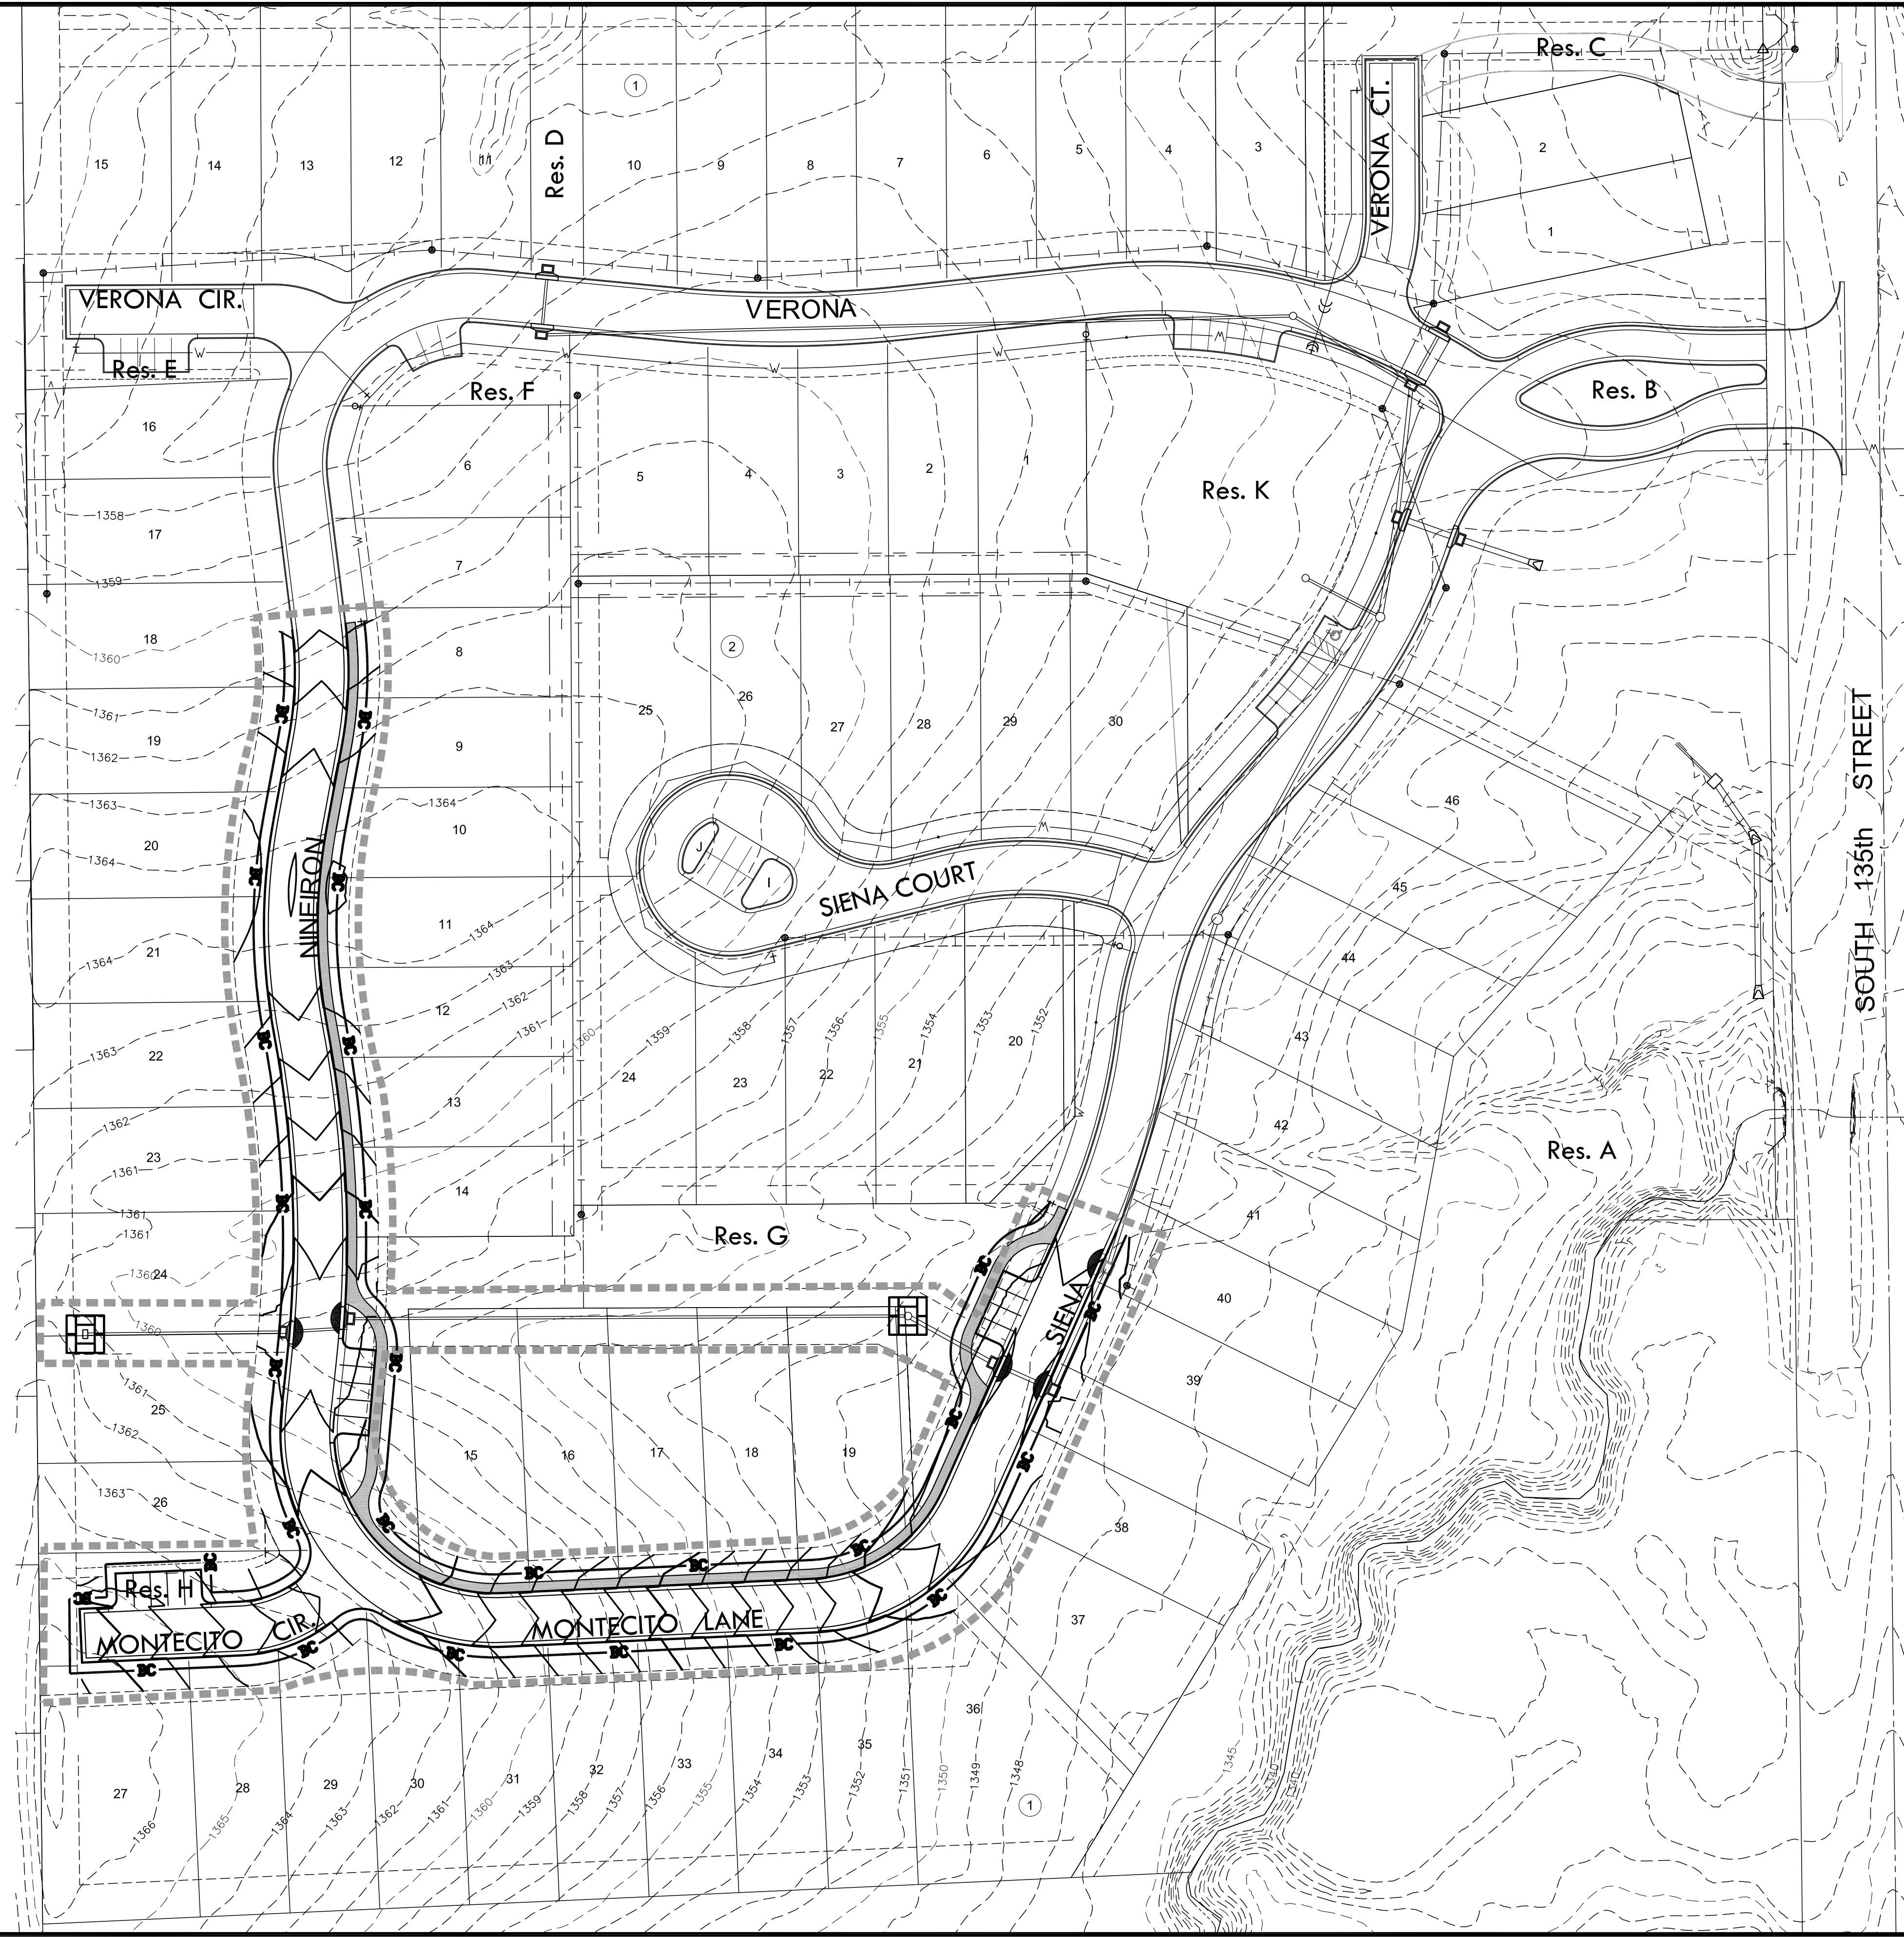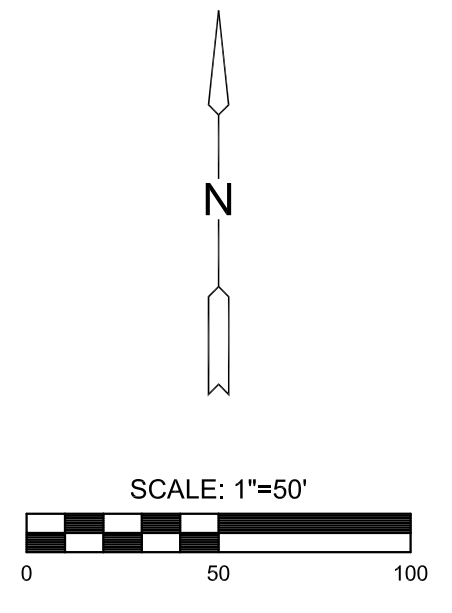

J:\PROJECTS\2013\1301010292_PERFECTION_COURTYARDS_AT_AUBURNHILLS\CADD\PAV\PHASE 2\13292-EP-01.DWG
 PLOTTED: Wednesday, July 29, 2015 @ 10:13AM