

PLOTTED: Tuesday, April 05, 2016 @ 10:55AM
 J:\CH\1026492\p11026492.LDWG

INDEX OF SHEETS

SHEET NO	DESCRIPTION
1	Title Sheet
2	General Notes & Details
3	Plan & Profile Sheet
4-6	Approach Slab Details
7-13	Concrete Pavement Details
14	Bridge Notes and Quantities
15	Deck Delamination Diagram
16	Construction Layout
17-23	Bridge Retaining Wall Plan and Details
24	Bill of Reinforcing Steel & Bending Diagrams
25	Bridge Concrete Curb Repair Details
26	Bridge Deck Patching and Overlay Details
27	Supports and Spacers for Reinforcing Steel
28-29	Handrail Rehabilitation Details
30	Summary of Quantities
31	Erosion Control & Sediment Control Plan
32-36	Erosion Control BMP Sheets
37	Roadside Improvement Plan
38	Pavement Marking Plan
39	Pavement Signing Details & Quantity
40	Construction Sequence
41-42	Traffic Control Plans
43-46	Traffic Control Details
47-48	Temporary Concrete Safety Barrier Details
49-51	Sidewalk Cross Sections


BRIDGE REHABILITATION IMPROVEMENTS

PAWNEE AVENUE BRIDGE OVER ARKANSAS RIVER

PROJECT NO. 472-84922


THE CITY OF WICHITA, KANSAS
GARY JANZEN, P.E. - CITY ENGINEER

OCA # 715726

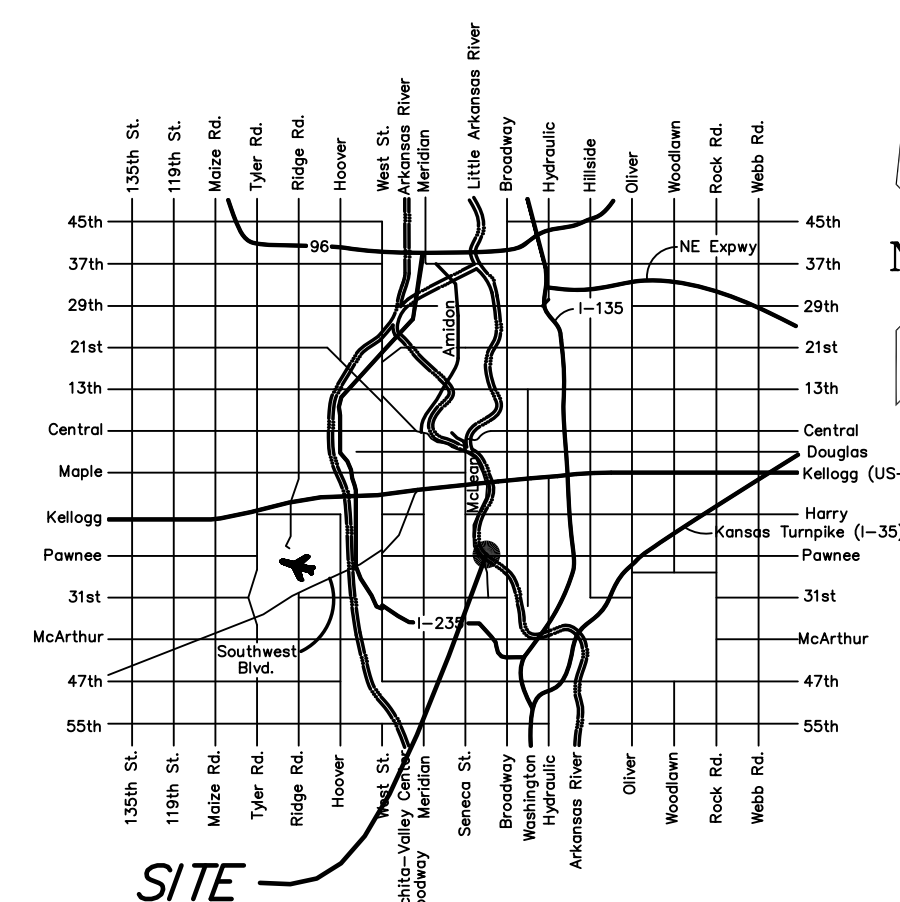

LOCATION MAP

Rehabilitate Existing Bridge
 36'-4" @ 47'-44"-42'-39'-29"
 Continuous R.C.S.H.
 68'-0" Roadway, Skew 35° Lt.
 with Walkway, Lt. & Rt.

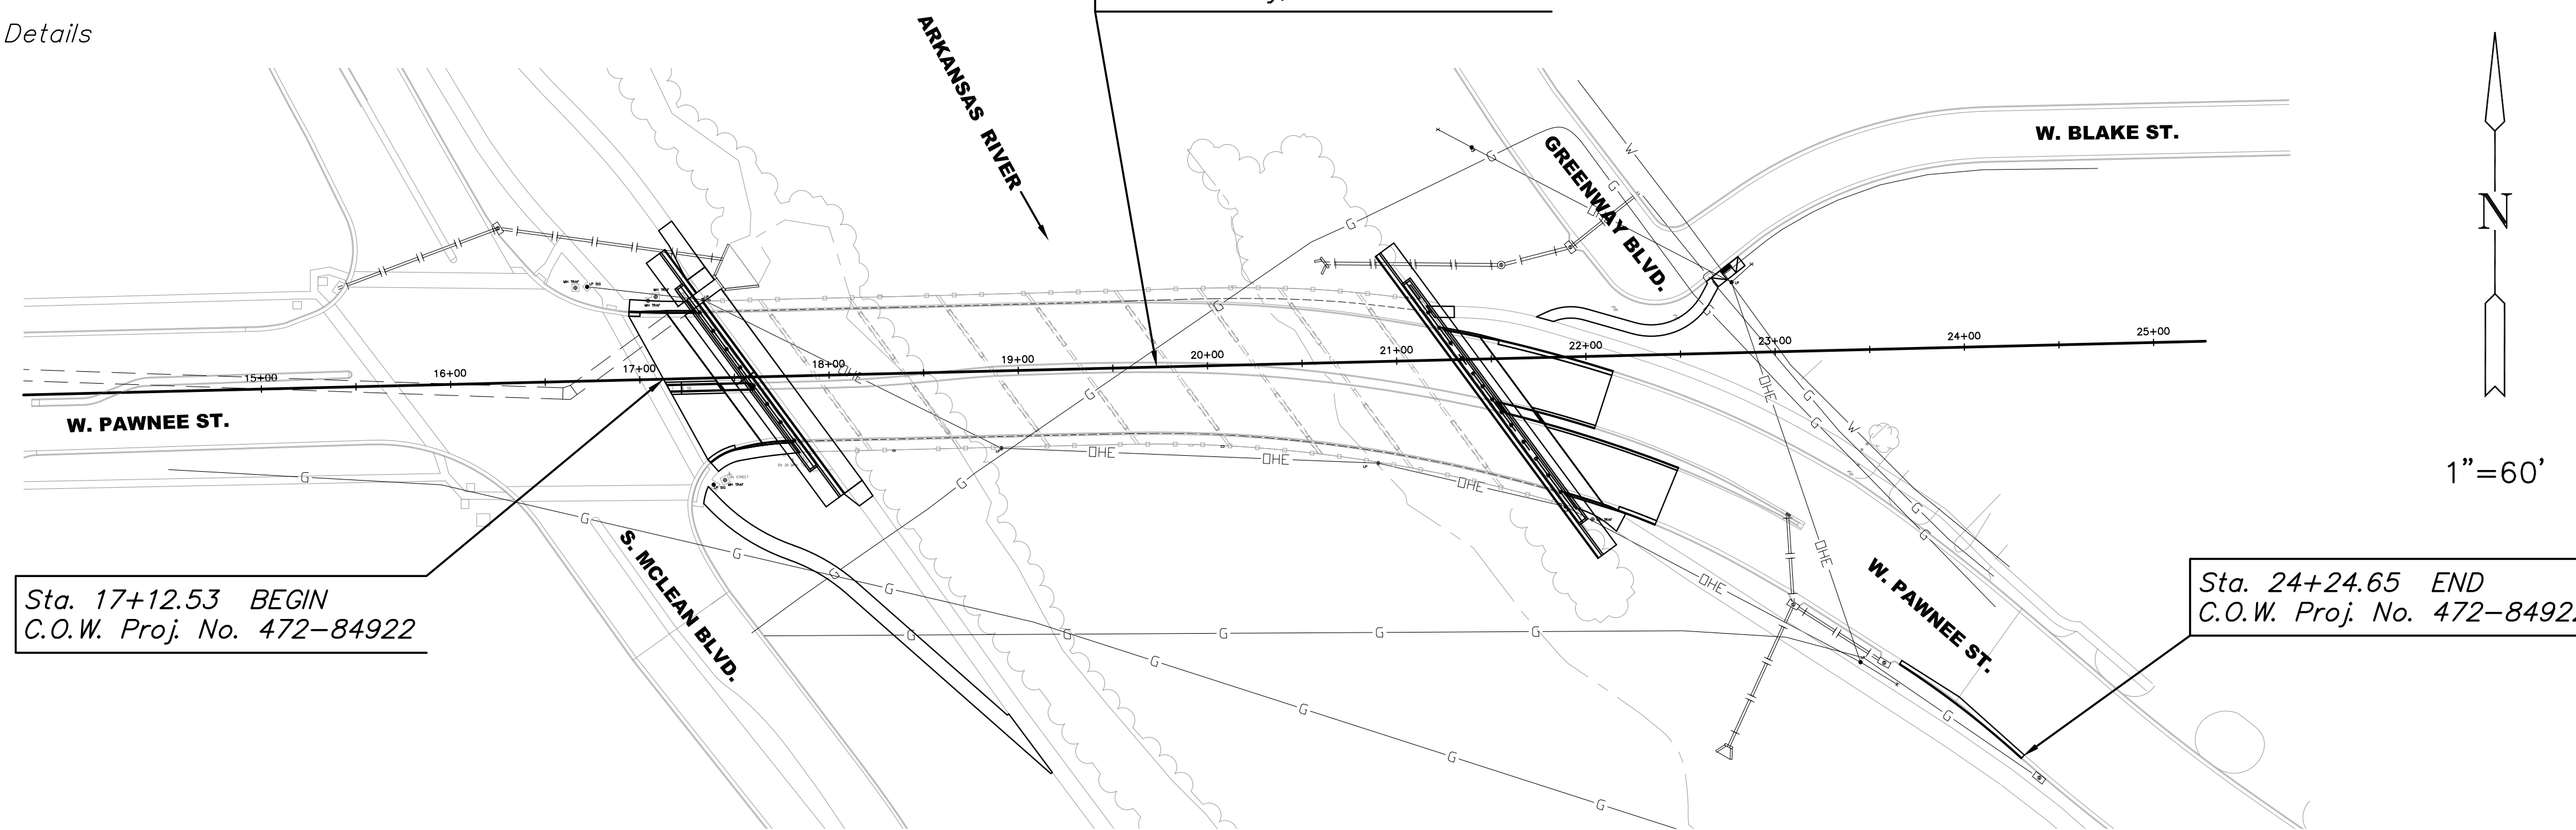

Sta. 17+12.53 BEGIN
 C.O.W. Proj. No. 472-84922

Sta. 24+24.65 END
 C.O.W. Proj. No. 472-84922

1"=60'

NOTE:
ROAD SHALL BE CLOSED TO TRAFFIC DURING CONSTRUCTION. LOCAL TRAFFIC WILL BE PERMITTED TO ADJACENT PROPERTIES.

PREPARED & SUBMITTED BY

MKEC ENGINEERING, INC.
WICHITA, KANSAS



APPROVED - DATE

GARY JANZEN, P.E.
CITY ENGINEER

DESIGN DESIGNATION

AADT (2013)	19,153
AADT (2033)	23,370
DHV	10%
D	60%
T	2%
V	35 M.P.H.
C of A	NONE
Clear Zone	6 FT.



Wichita, KS • 316-684-9600

PAWNEE AVENUE BRIDGE OVER ARKANSAS RIVER
BRIDGE REHABILITATION IMPROVEMENTS

©2013
 MKEC Engineering
 All Rights Reserved
 www.mkec.com
 These drawings and their contents, including, but not limited to, all concepts, designs, & ideas are the exclusive property of MKEC Engineering (MKEC), and may not be used or reproduced in any way without the express consent of MKEC.

PROJECT TITLE SHEET

PROJECT NO.	472-84922	
DATE	04/05/2016	
SCALE	1"=60'	
DESIGNED	DRAWN	CHECKED
KJS, JRA	DPG	KJS, JRA
NO.	REVISION	DATE

SHEET NO.