

©2018  
MKEC Engineering  
All Rights Reserved  
www.mkec.com  
These drawings and their contents, including, but not limited to, all concepts, designs, & ideas are the exclusive property of MKEC Engineering (MKEC), and may not be used or reproduced in any way without the express consent of MKEC.

**SITE PLAN 34**

PROJECT NO. 1701010567


DATE MAY 2, 2018

SCALE 1" = 30'

DESIGNED DRAWN CHECKED  
JAG CRM MAB



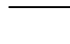
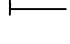
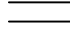
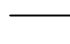
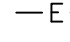

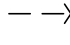

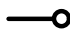

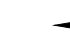


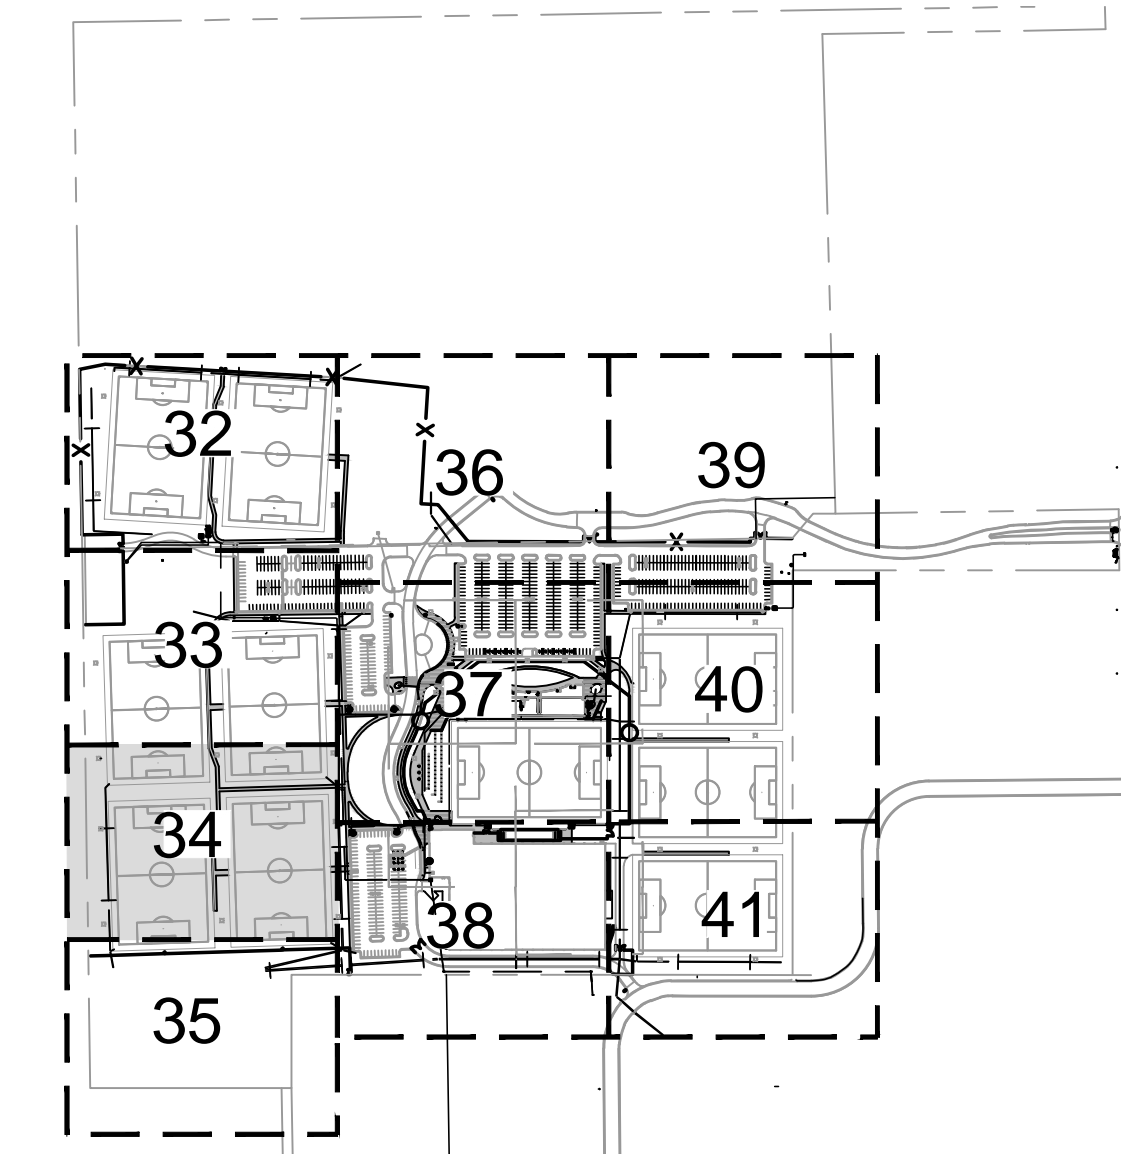

ISSUED FOR CONST. 05-02-18  
NO. REVISION DATE


SHEET NO.

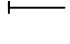

**LOCATION MAP**

**LEGEND**

-  EXISTING SANITARY SEWER
-  EXISTING GAS LINE
-  EXISTING WATER LINE
-  EXISTING STORM SEWER
-  PROPOSED STORM SEWER
-  PROPOSED UNDERDRAIN
-  PROPOSED ELEC. CONDUIT (SCHEMATIC)
-  PROPOSED GRADES
-  EXISTING GRADES
-  GRADING LIMITS
-  ORNAMENTAL FENCE
-  CHAINLINK FENCE
-  SLOPE ARROW
-  SPOT ELEVATION
-  PROP. PICNIC TABLE
-  PROP. TRASH RECEPTACLE
-  PROP. FLAGPOLE

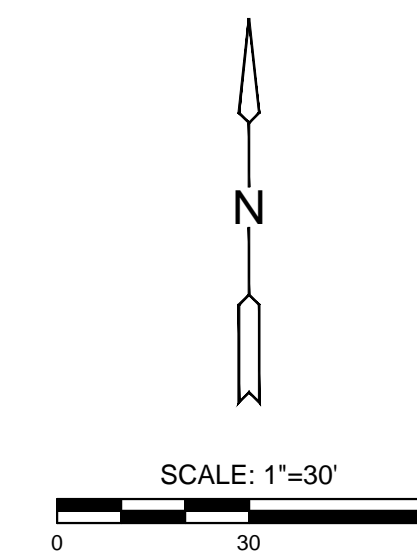

**DETAIL LEGEND**

KEY	DETAIL	DESCRIPTION	SHEET	DETAIL NO.
1	HANDRAIL DETAIL	SIDEWALK RAMP/ HANDRAIL DETAIL	31	1
②	CONCRETE PVMT.	TYPICAL SECTION: 6" THICK CONCRETE PAVEMENT	31	3
3	SPECIALTY PVMT.	TYPICAL SECTION: SPECIALTY PAVEMENT	31	5
4	CURB RAMP	TYPICAL SECTION: 6" THICK ADA CURB RAMP	7	1
5	CHAIN LINK FENCE	6' CHAIN LINK FENCE DETAIL	27	4
6	CHAIN LINK FENCE	8' CHAIN LINK FENCE DETAIL	27	4
7	DOUBLE HUNG GATE	6' CHAIN LINK GATE DETAIL	27	3
8	DOUBLE HUNG GATE	6' CHAIN LINK SLIDING GATE DETAIL	-	-
9	DOUBLE HUNG GATE	8' CHAIN LINK GATE DETAIL	27	3
10	PIPE GATE	TYPICAL SECTION: PIPE GATE DETAIL	27	1
11	ORNAMENTAL FENCE	TYPICAL SECTION: 7' ORNAMENTAL FENCE DETAIL	27	2
12	ORNAMENTAL GATE	TYPICAL SECTION: 7' ORNAMENTAL GATE DETAIL	-	-
13	PVMT. MARKING	CROSS WALK DETAIL	5	1
14	BOLLARD	BOLLARD	30	1
15	FENCING CURB	1' CONCRETE FENCING CURB	31	4

PLOTTED: Wednesday, May 02, 2018 @ 01:58PM

J:\PROJECTS\2017\1701010567\CAD\STRYKER\170567\_CAD\SHS\05\_OVALPAV\SIDEWALK AND FENCING\170567\_05\_1201.DWG