

BRIDGE GUARDRAIL TYPE I TERMINATION MITER SS RODS SEE PLAN DTL. D/A4
BRIDGE GUARDRAIL TYPE I (TYP) (IN BACKGROUND)

METAL BRIDGE TOWER ELEMENT - SEE SHTS AT # A8 FOR DETAILS
BRIDGE LIGHTING ELEMENT SEE ELECTRICAL

GREY CONCRETE TOPPING

PIER DIAPHRAGM (SEE CIVIL FOR DIMENSIONS ON REVEALS)

UNIT PAVERS

PIER FACE PANEL - SEE 5/A2 FOR NORTH/SOUTH ELEVATION


PROVIDE MED. ABRASIVE BLAST, STAIN, & SEALER AT TOP OF BEAM PROJECTION
BRUSH ABRASIVE BLAST W/ SEAL ONLY (ON CONC. EDGE BAND ONLY)

MEDIUM ABRASIVE BLAST W/ SEAL ONLY - APPLY SEALER TO PIER TO DEPTH OF 1'-0" BELOW STATIC WATER LEVEL - TYP. ALL AROUND

1253.1 (Flood Elev.)

1283.90 (Static Pool)

1215.00 (River Btm.)

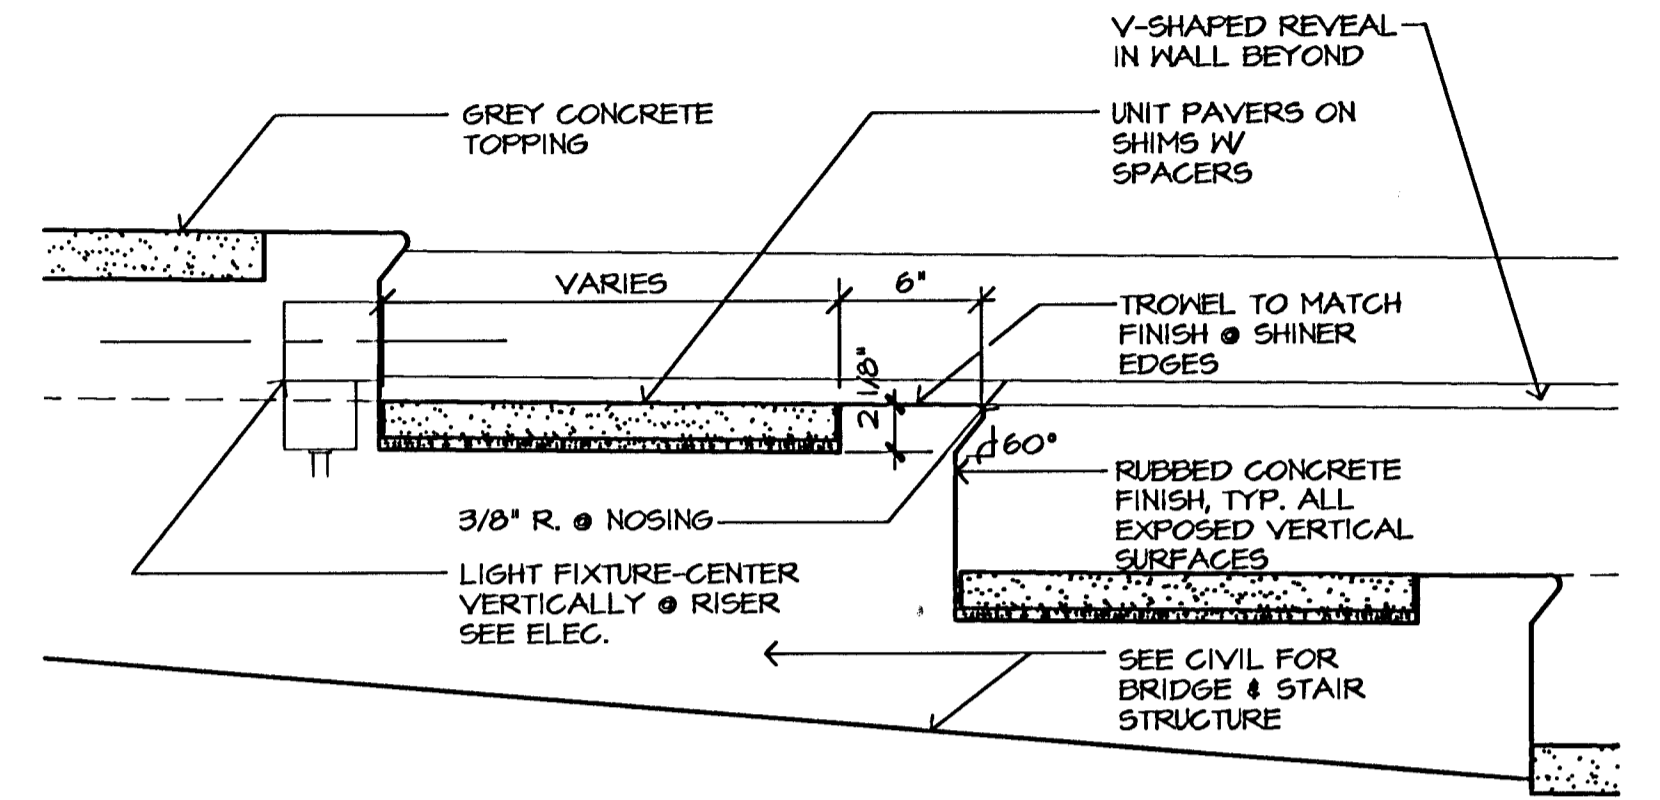

2 STAIR SECTION
1 1/2" = 1'-0"

GENERAL NOTES

- SEE SHEET A10 FOR BRIDGE GUARDRAIL DETAILS
- ALL COMPONENTS OF WALKWAY STRUCTURE TO RECEIVE ABRASIVE BLAST, STAIN, AND SEALER TO MATCH ADJACENT SURFACES. COMPONENTS INCLUDE, BUT ARE NOT LIMITED TO THE FOLLOWING: BOTTOM EDGES AND BACKSIDES OF T-BEAMS, UNDERSIDE OF CONCRETE DECK, DIAPHRAGM BEAMS & UNDERSIDE OF PIER BEAM.

LEGEND

- CONCRETE SURFACES TO RECEIVE MEDIUM ABRASIVE BLAST FINISH WITH STAIN AND SEALER
- CONCRETE SURFACES TO RECEIVE BRUSH ABRASIVE BLAST FINISH WITH STAIN AND SEALER
- CONCRETE SURFACES TO RECEIVE MEDIUM ABRASIVE BLAST FINISH WITH SEALER ONLY



1 PIERS #2 & #3 WEST ELEVATION

0' 2' 4' 8' 3/16" = 1'-0"

EAST ELEVATION SIMILAR

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|---|---------|---|----------|-----------------|------|
| 1 | | Revisions | | By | Date |
| <p>GossenLivingston Architecture 430 South Central Wichita, KS 67202 Tel: (316) 265-1307 Fax: (316) 265-3448</p> | | <p>CITY OF WICHITA, KANSAS MICHAEL E. LINDEBAK, P.E. - CITY ENGINEER DOUGLAS AVENUE BRIDGE OVER ARKANSAS RIVER ARCH. PIER ELEVATION CITY OF WICHITA PROJECT NO. 472-82721 PROFESSIONAL ENGINEERING CONSULTANTS, P.A. ENGINEERS WICHITA, KANSAS</p> | | | |
| Designed by | LBD/JPB | Checked by | JPB | | |
| Drawn by | LBD | Date | 11/21/97 | Job No. 95088-4 | |

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