
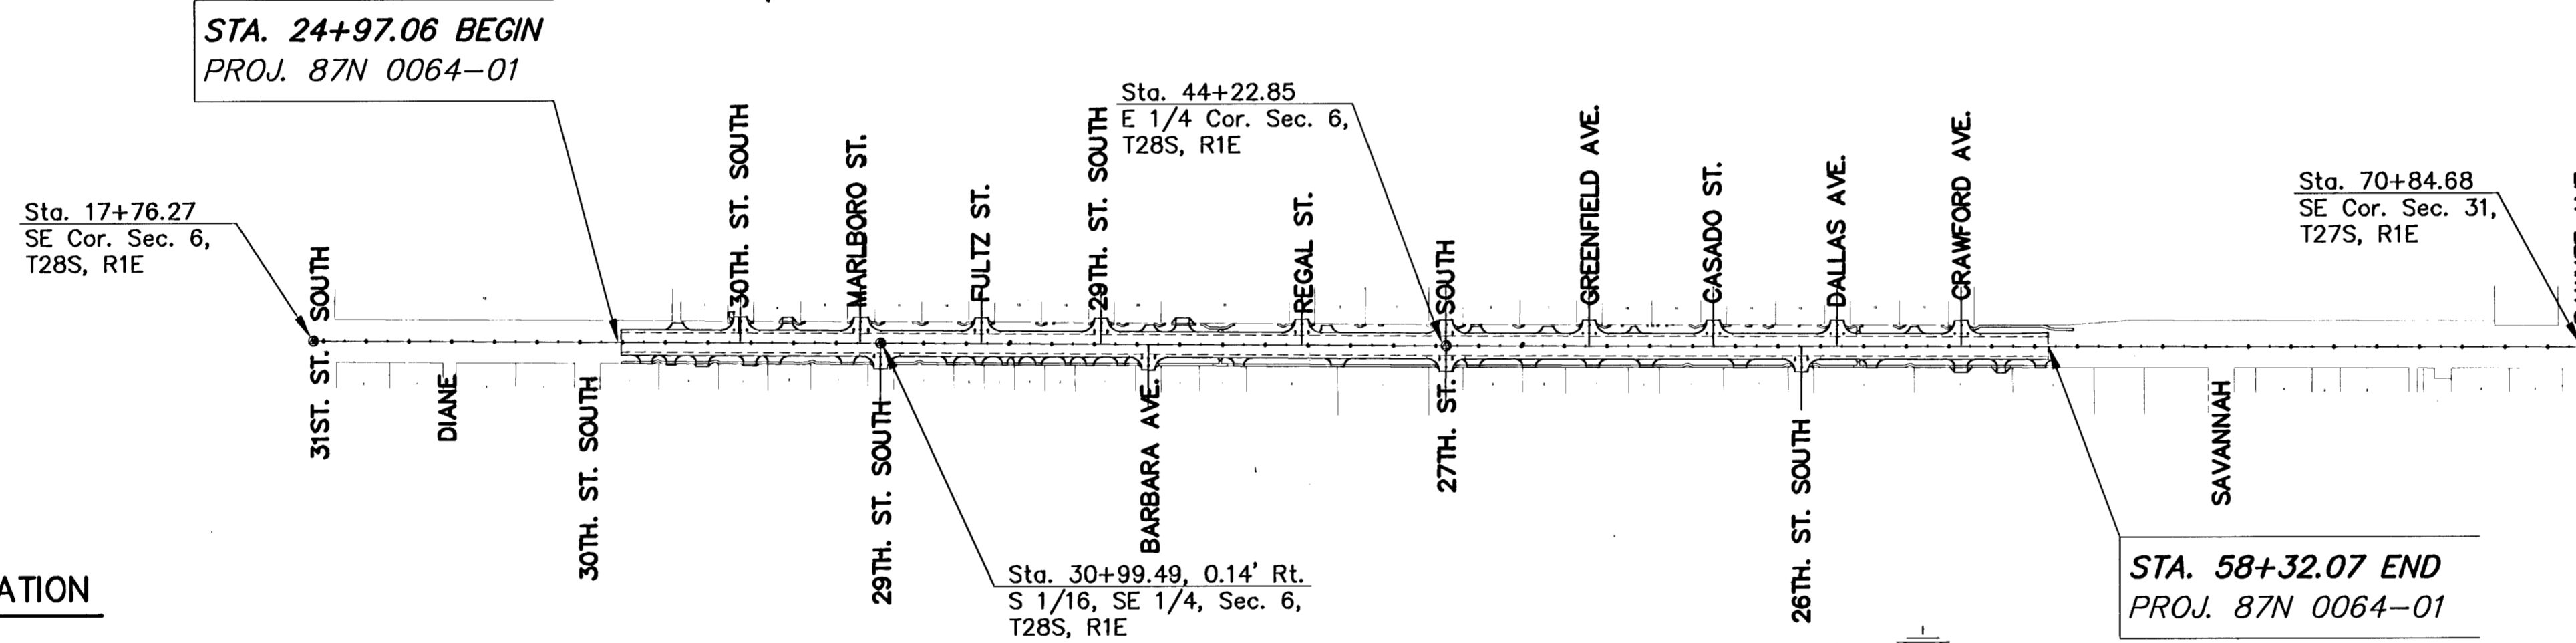


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PAVING PLANS FOR SOUTH SENECA STREET 30TH. STREET SOUTH TO CRAWFORD AVENUE

**WICHITA, SEDGWICK COUNTY
PROJECT NO. 472-83084
MICHAEL E. LINDEBAK, CITY ENGINEER
INDEX CODE 706778**

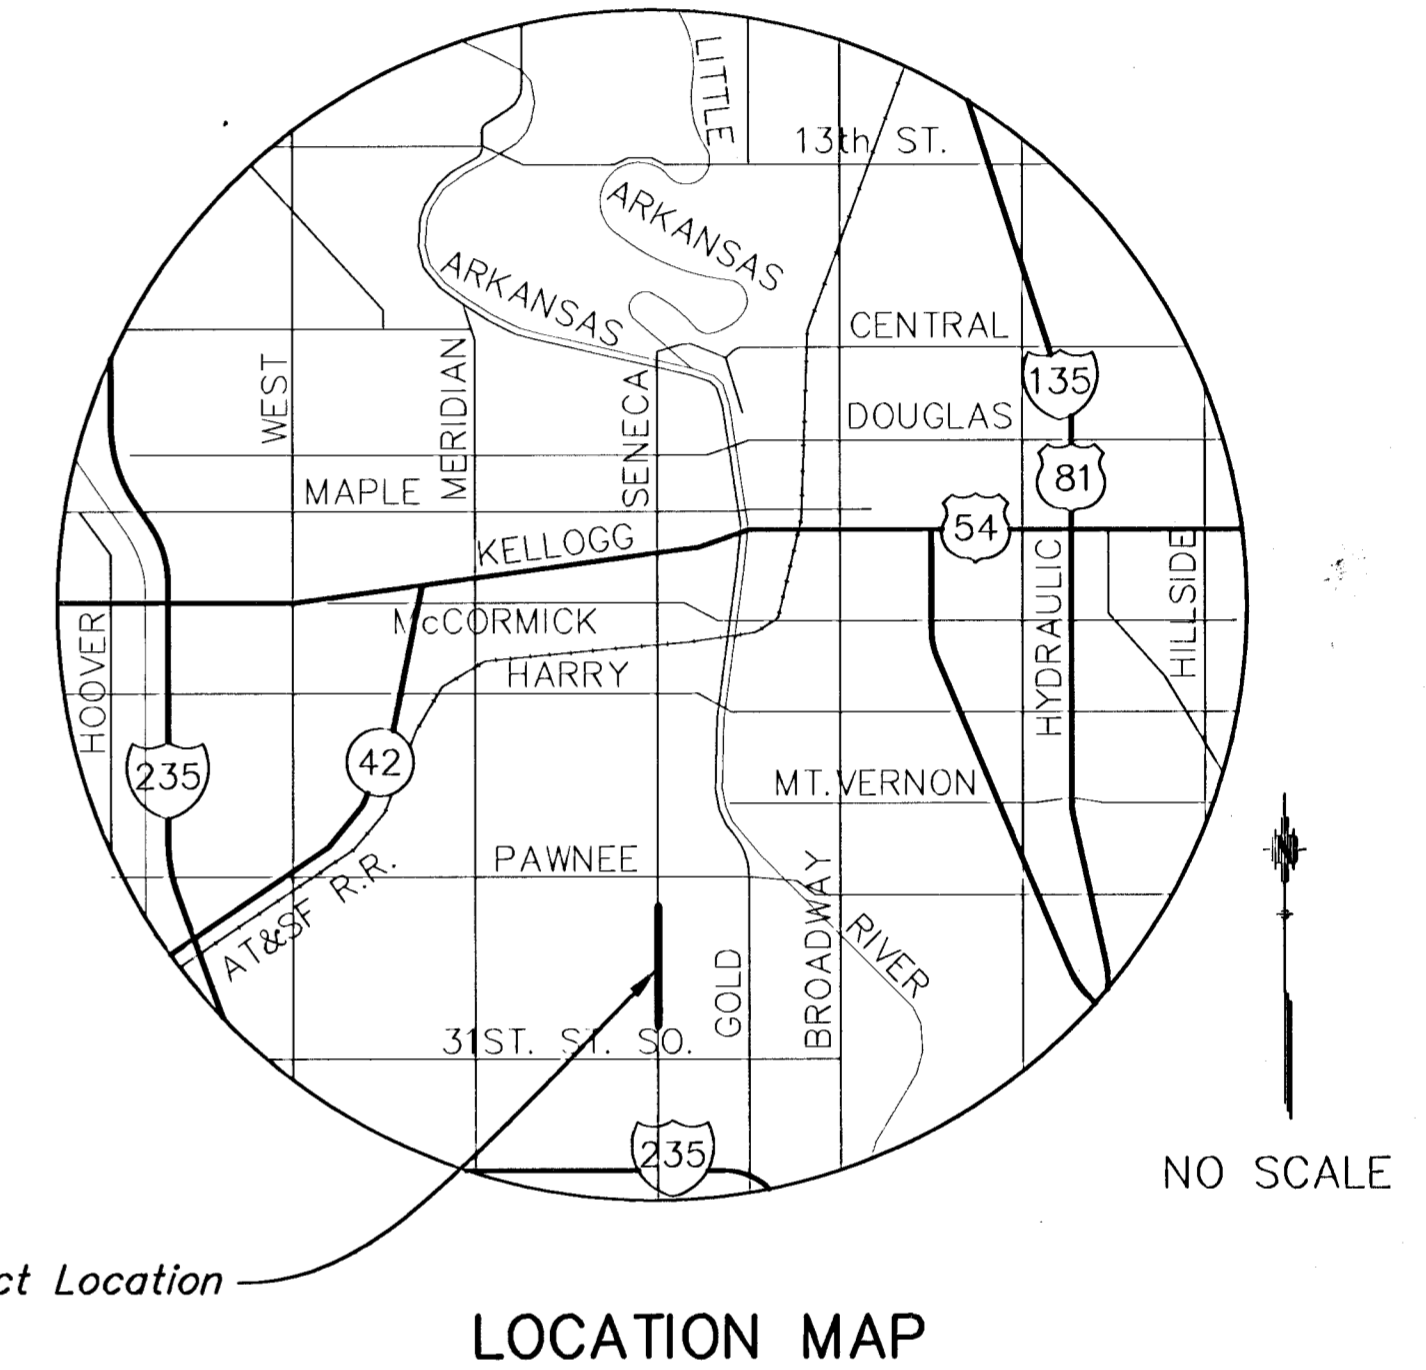

DESIGN DESIGNATION

AADT (1995)	=	18123
AADT (2015)	=	22100
DHV	=	722
D	=	56%
T	=	03%
V	=	40 M.P.H.
Control of Access	=	NONE
Clear Zone	=	6 FT.

SCALE: 1" = 300'

CONVENTIONAL SIGNS

COUNTY LINE	---	CENTER LINE OF PROJECT	---
CITY LIMITS		TERRACE	---
STATE OR NATIONAL LINE	----	CULVERTS	---
TOWNSHIP, SECTION or GRANT LINE	----	DROP INLET & STORM SEWER	---
PROPERTY LINE	----	ACCESS CONTROL	---
HIGHWAY FENCE	----	POWER POLE	---
EXISTING FENCE	----	TELEPHONE POLE	---
GUARD FENCE	----	MARSH	---
CONSTRUCTION LIMITS	----	HEDGE	---
RIGHT OF WAY LINE	----	TREES	---
TRAVELED WAY	----	PROFILE ELEVATION	---
RAILROADS	----	STREAM or CREEK	---

GROSS LENGTH OF PROJECT	3335.01 FT.	
EXCEPTIONS	FT.	
NET LENGTH OF PROJECT	3335.01 FT.	0.632 MILES
NET LENGTH OF BRIDGES	FT.	MILES
NET LENGTH OF ROAD	3335.01 FT.	0.632 MILES

NOTE: TRAFFIC SHALL BE CARRIED THROUGH CONSTRUCTION



SOUTH SENECA PAVING PLANS
PROJECT NAME

TITLE SHEET
SHEET TITLE

DCH DESIGN BY:	HNJ DRAWN BY:	DCH CHECKED BY:
MAY 1, 2000 DATE	94005ET JOB NO.	1 / 58 SHEET/OF

MID-KANSAS ENGINEERING CONSULTANTS, INC.
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