



PLOTTED: Thursday, December 23, 2021 @ 01:03PM

J:\PROJECTS\2019\1901010483_COW_37TH STREET WATERLINE_190483 CAD\SHOTS\05 CIVIL\EROSION\190483-05-5474.DWG

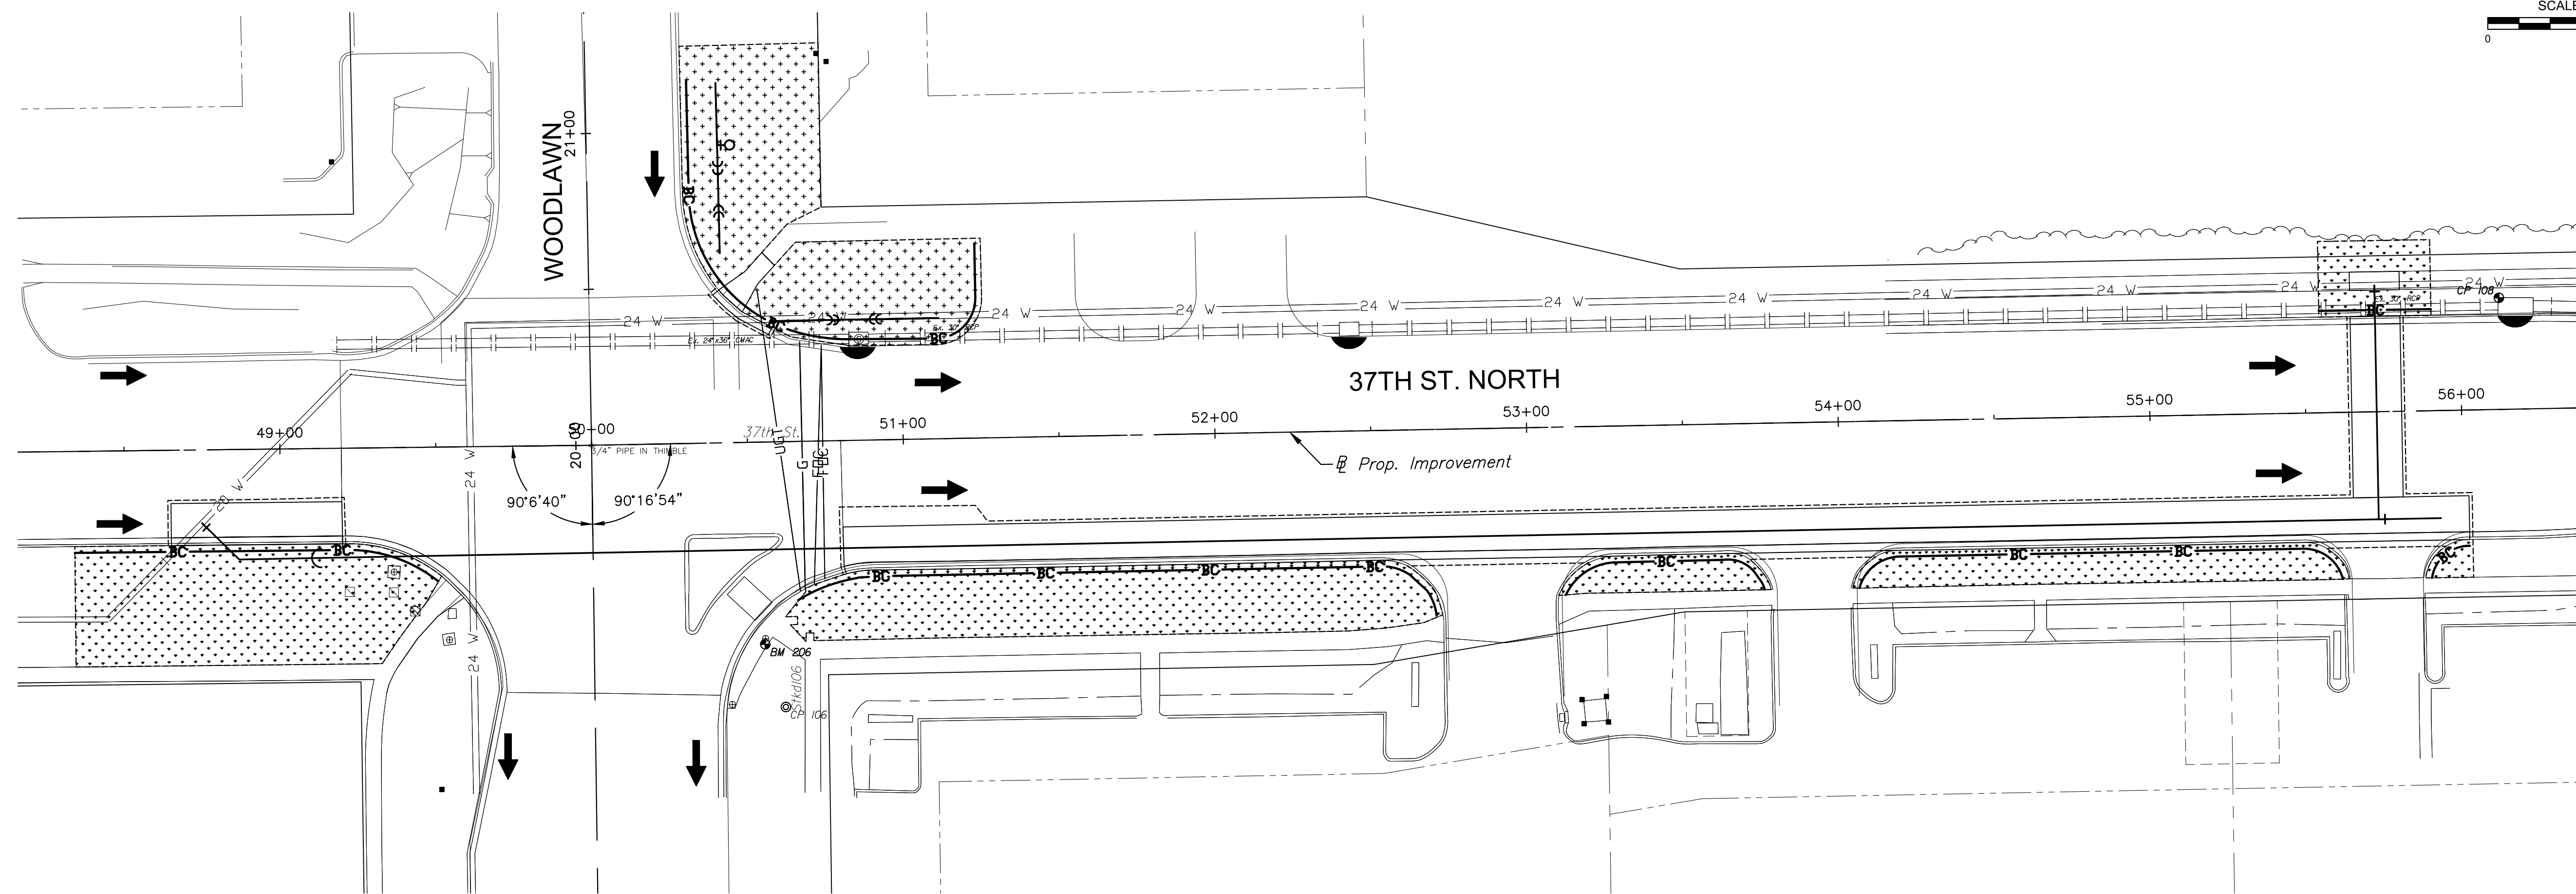

PLAN

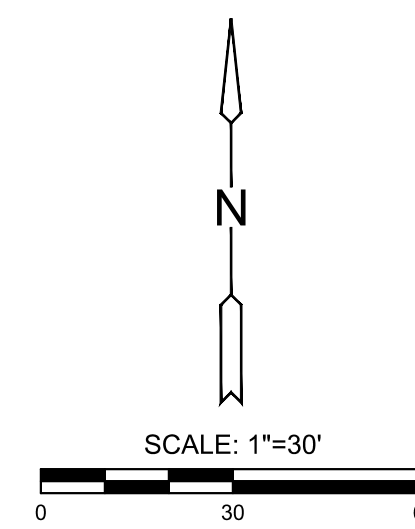

EROSION CONTROL NOTES

THIS PROJECT WILL NOT DISTURB MORE THAN 0.64 ACRES AT ANY ONE TIME.






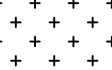
COST FOR EACH EROSION AND SEDIMENT CONTROL ITEM SHALL INCLUDE MAINTENANCE, INSPECTION AND EVENTUAL REMOVAL. BESIDES KEEPING EACH DEVICE IN WORKING ORDER, MAINTENANCE SHALL INCLUDE, AT A MINIMUM, SEDIMENT REMOVAL BEFORE 50% OF THE DEVICE'S CAPACITY IS REACHED.

CONTRACTOR SHALL ADJUST EROSION AND SEDIMENT CONTROL PLANS TO CONFORM TO ACTUAL CONSTRUCTION OPERATIONS. ALL CHANGES TO PLAN SHALL BE APPROVED BY THE CITY.

STOCKPILING OF EXCAVATED MATERIAL ON THE PROJECT SITE IS GENERALLY PROHIBITED. SMALL AND INTERIM STOCK PILES NOT IMMEDIATELY HAULED OFF-SITE SHOULD BE ENCLOSED AND PROTECTED WITH BIO-DEGRADABLE LOG AROUND THE ENTIRE CIRCUMFERENCE OF THE STOCK PILE. INSTALLING AND MAINTAINING THIS FENCE SHALL BE CONSIDERED SUBSIDIARY TO THE BID ITEM "SITE RESTORATION".

EROSION CONTROL DEVICES WILL NEED TO BE INSTALLED AS APPLICABLE FOR THE APPROPRIATE CONSTRUCTION PHASE. CONTRACTOR SHALL ADJUST EROSION AND SEDIMENT CONTROL PLAN TO CONFORM TO ACTUAL CONSTRUCTION OPERATIONS. ONCE INSTALLED, THE DEVICES SHALL REMAIN IN-PLACE AND CONTINUE TO BE MAINTAINED UNTIL NO LONGER NECESSARY AS DETERMINED BY THE CITY.

LEGEND

-  FLOW ARROW
-  BACK OF CURB PROTECTION
-  CURB INLET PROTECTION
-  CONSTRUCTION LIMITS
-  SODDING, FESCUE
-  TEMPORARY SEEDING - PAID FOR AS "SITE RESTORATION"



PLANS FOR
37TH STREET WATER LINE
WICHITA, KS

©2021
 MKEC Engineering
 All Rights Reserved
 www.mkec.com
 These drawings and their contents, including, but not limited to, all concepts, designs, & ideas are the exclusive property of MKEC Engineering (MKEC), and may not be used or reproduced in any way without the express consent of MKEC.

TEMPORARY EROSION CONTROL & SITE RESTORATION

PROJECT NO.	1901010483	
DATE	DEC. 2021	
SCALE	1"=30'	
DESIGNED	DRAWN	CHECKED
JRA	WNJ	JRA

NO.	REVISION	DATE

SHEET NO.
 12 OF 31