




## EROSION CONTROL NOTES

1. EROSION CONTROL IS TO MEET ALL FEDERAL, STATE, COUNTY & LOCAL CODE STANDARDS.
  2. CONTRACTOR SHALL PROVIDE EROSION PROTECTION THROUGHOUT PROJECT CONSTRUCTION. THE PLAN PROVIDED HERE IS FOR FINAL PROTECTION, VARIOUS PHASES OF THIS PLAN SHALL BE IMPLEMENTED OR MODIFIED TO CONTROL EROSION. MODIFICATIONS OF THE PLAN SHALL BE APPROVED BY THE OWNERS REPRESENTATIVE.
  3. SEEDING AREAS SHALL BE PREPARED FOR PLANTING WITH COMMON AGRICULTURAL TECHNIQUES. APPROVE WITH OWNER'S REPRESENTATIVE BEFORE PLANTING.
  4. CONTRACTOR IS RESPONSIBLE FOR MAINTAINING AND IMPLEMENTING ALL EROSION CONTROL.
  5. ALL SEED SHALL BE DISTRIBUTED WITH AN ACCEPTABLE DRILL INTENDED FOR SUCH OPERATIONS, OR OTHER EQUIPMENT APPROVED BY THE OWNER'S REPRESENTATIVE. SEEDING DEPTH SHALL BE 1/4".
  6. NATIVE SEEDING SHALL BE PERFORMED BETWEEN MARCH 1 AND MAY 1 OR OUTSIDE THIS TIME FRAME ONLY WITH PRIOR APPROVAL FROM THE LANDSCAPE ARCHITECT. BROADCASTING WILL BE ALLOWED IN UNACCESSIBLE AREAS TO THE DRILL ONLY AFTER GROUND IS DISTURBED TO CREATE A SUITABLE SEEDBED. SEEDING DEPTH SHALL BE 1/4". NOTE THAT TREE, SHRUB PLANTINGS AND IRRIGATION WILL BE INSTALLED BY THE OWNER AFTER THE EARTHWORK IS COMPLETE BUT PRIOR TO PERMANENT SEEDING. COORDINATE SCHEDULE AND OPERATIONS WITH THE OWNER. THE CONTRACTOR SHALL TAKE CARE TO SEED AROUND PLANTING IMPROVEMENTS. ANY RESULTING DAMAGES SHALL BE AMENDED.
  7. ALL AREAS DISTURBED SHALL BE SEEDED (COST SUBSIDIARY TO SEEDING) AND FERTILIZED AS FOLLOWS:  
BROME @ 200 LBS./ACRE  
10-20-10 @ 350 LBS./ACRE
- ALL AREAS SHALL BE FINE GRADED AND THE SURFACE SHALL BE FREE FROM STICKS, SMALL STONES, AND OTHER EXTRANEOUS MATERIALS.
9. ALL SEEDED AREAS SHALL BE IMMEDIATELY MULCHED W/PRAIRIE HAY AT 2 TONS/ACRE. ANCHOR MULCH BY CRIMPING INTO TOPSOIL WITH SUITABLE MECHANICAL EQUIPMENT.

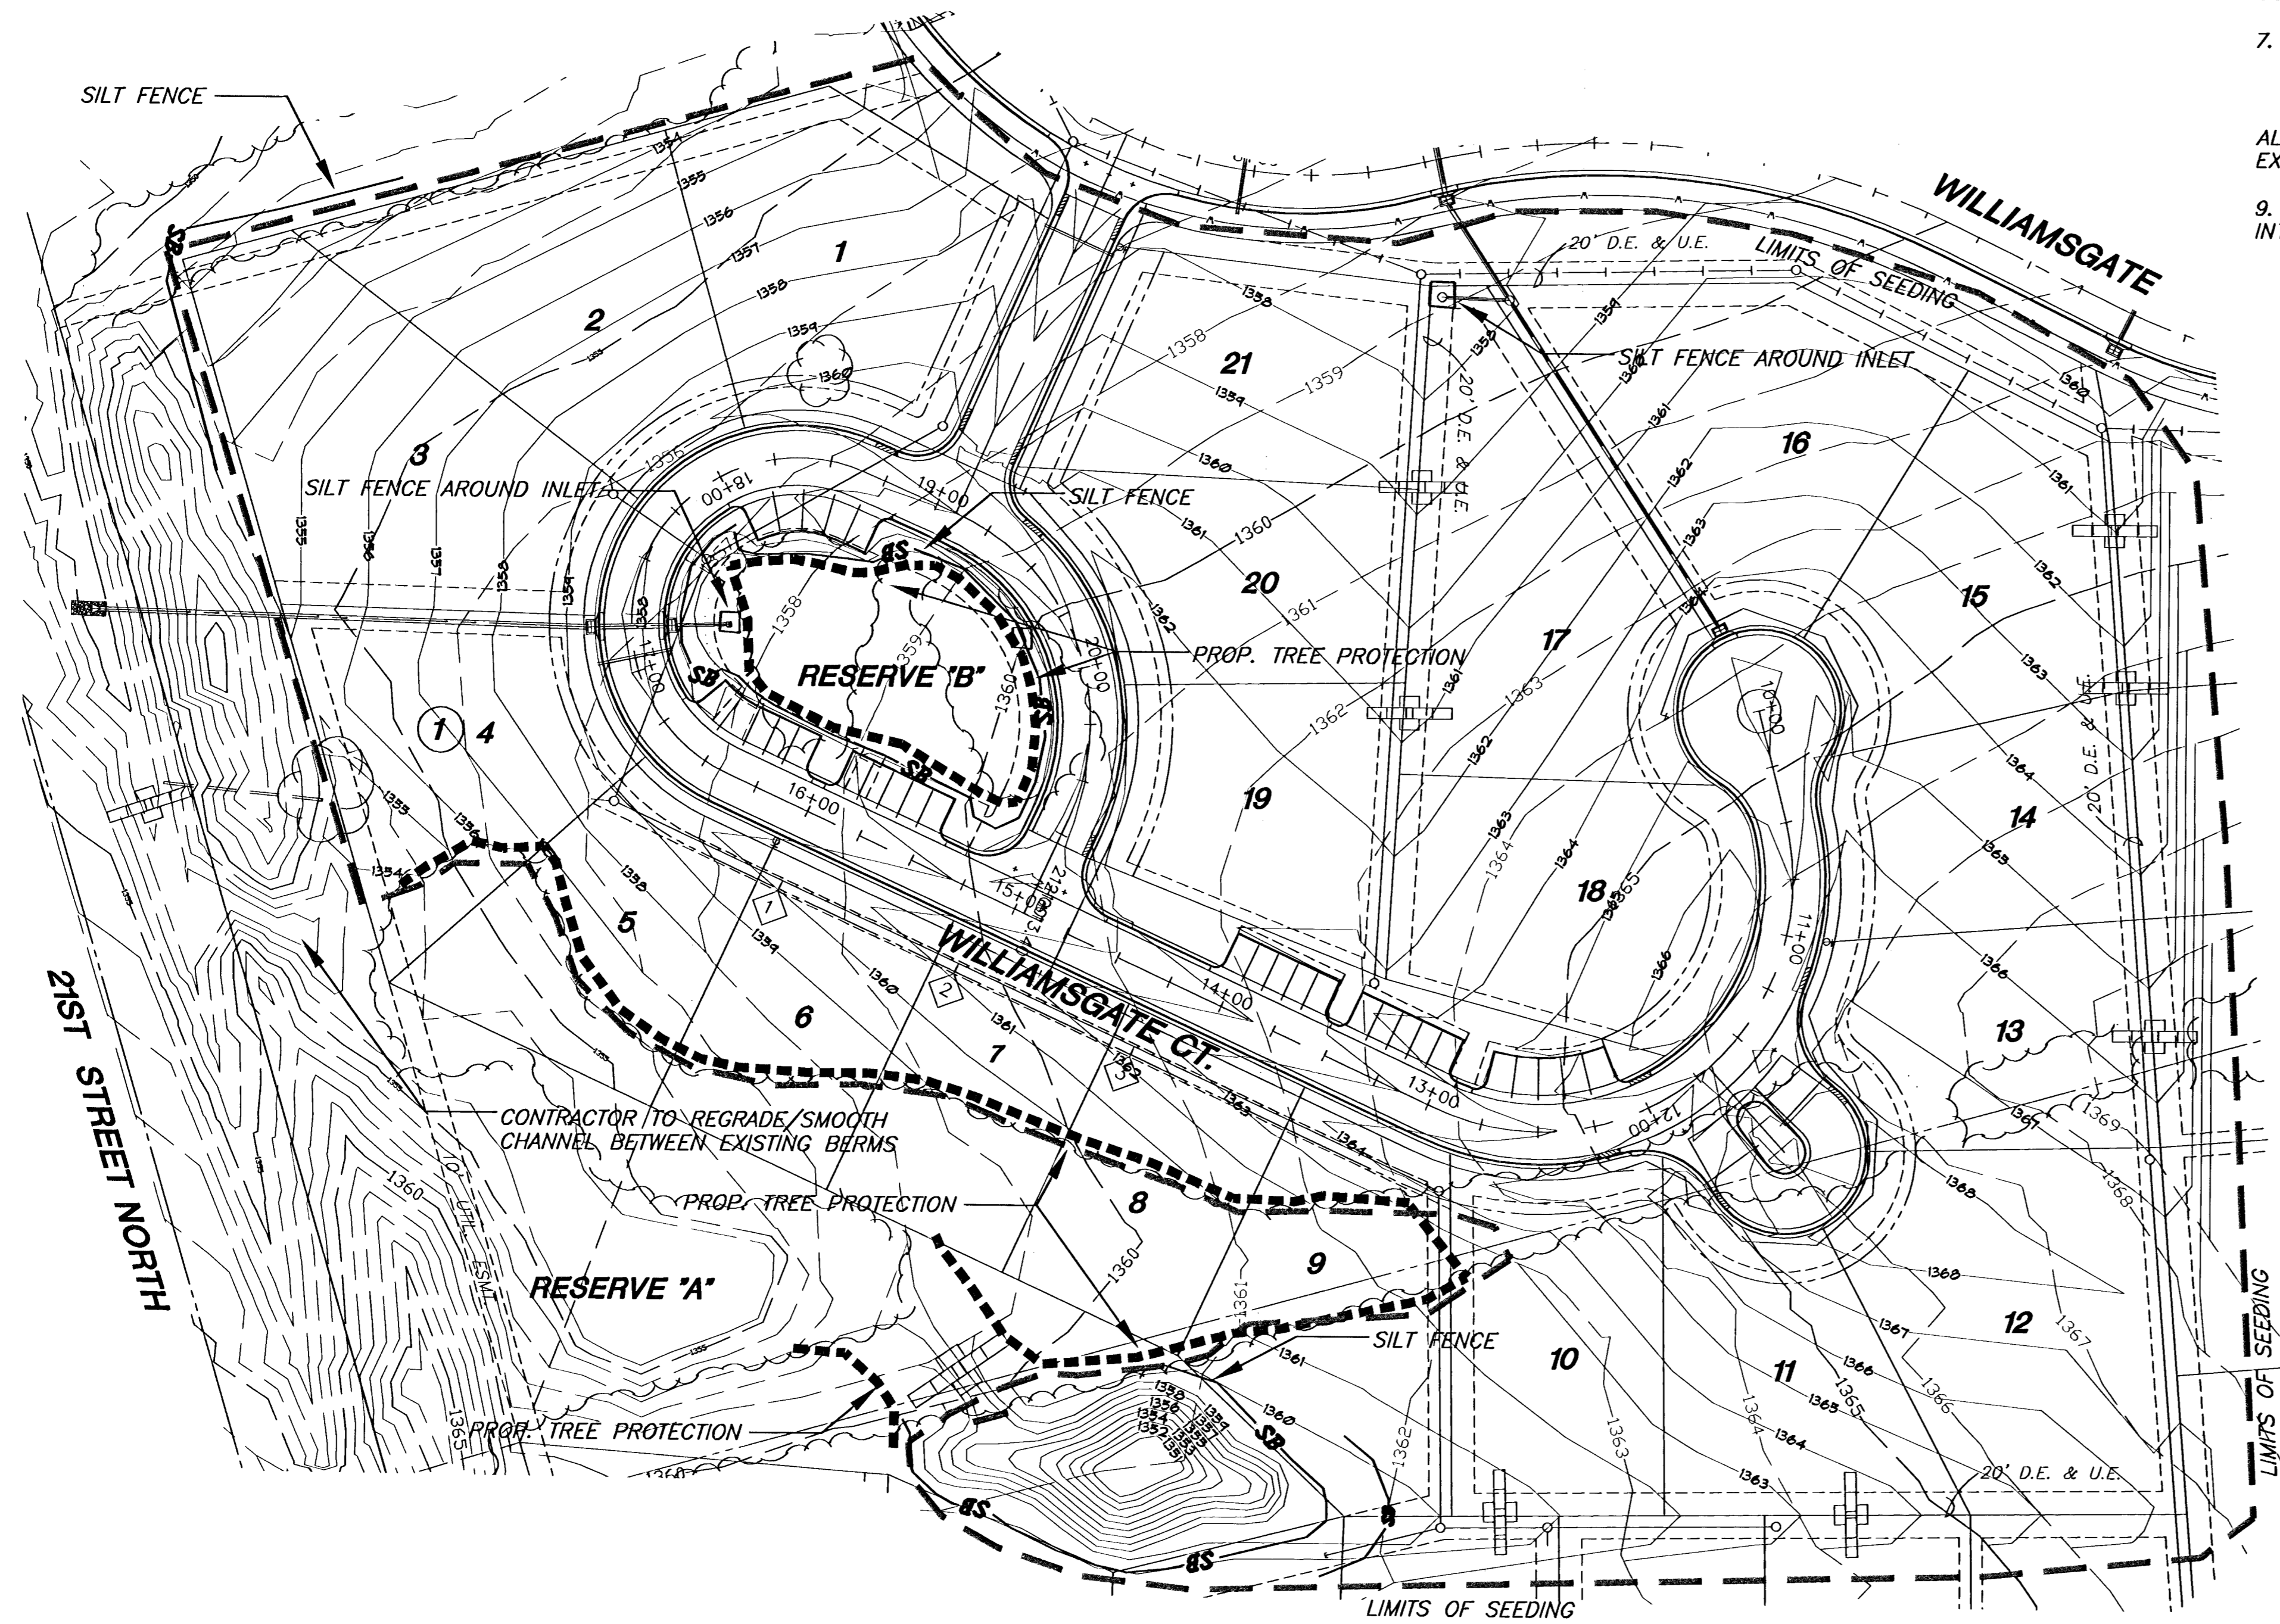

### LEGEND

- - - - - 1355 - - - - - EXIST. CONTOURS
- - - - - 1355 - - - - - PROP. CONTOURS
- - - - - LIMITS OF SEEDING
- - - - - TREE PROTECTION
- SB - - - - - SILT FENCE
- - - - - STRAW BALE DIKE

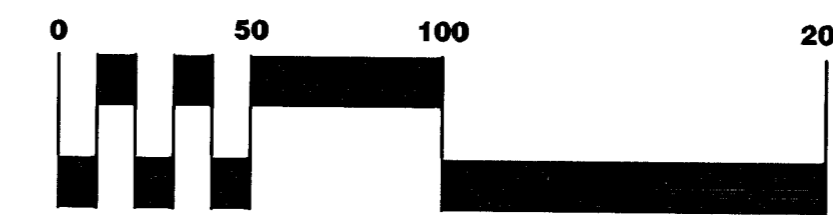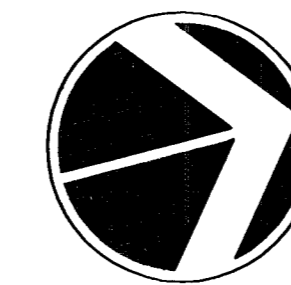

SCALE: 1" = 50'

H:\CIVIL\02167\DWG\Pa\Williamsgate.ct\02167ER1.DWG 08/23/2005 01:52:26 PM CST



**HAWTHORNE THIRD ADDITION - PH3**  
PROJECT NAME

**EROSION CONTROL PLAN**  
SHEET TITLE

MKEC DESIGN BY:	MKEC DRAWN BY:	JAG CHECKED BY:
AUGUST 2005 DATE	02167 JOB NO.	18 / 36 SHEET/OF